THE SCHOOL DISTRICT OF PHILADELPHIA Office of Capital Programs 440 North Broad Street, 3rd Floor – Suite 371 Philadelphia, PA 19130

TELEPHONE: (215) 400-4730

Addendum No. 001

Subject: George W. Childs School – Classroom Modifications

SDP Contract Nos. B-071C, B-074C of 2017/18

Location: George W. Childs School

1599 Wharton Street

Philadelphia, Pennsylvania 19146

This Addendum, dated May 9, 2018, shall modify and become part of the Contract Documents for the work of this project. Any items not mentioned herein, or affected by, shall be performed strictly in accordance with the original documents.

The following items, clarifications and/or revisions are to be included in the Contract Documents:

SPECIFICATIONS

Section: 01 1000 Summary of Work

Revisions: Delete the following classroom number from Paragraph 1.1, A.1. This room is not in scope.

a. DELETE 121

DRAWINGS

Drawing: A101

Revisions:

- a. Renovation Notes: Revise note A34 to read as follows (typical for all drawings):
 - A34 INSTALL NEW COAT HOOKS (30 HOOKS) AND PLASTIC LAMINATE SHELVES WHERE INDICATED.
- b. Renovation Notes: Add notes A39, A40 and A41 to read as follows (typical for all drawings):
 - A39 INSTALL NEW WOOD WALL BASE, STAIN AND CLEAR COAT FINISH TO MATCH EXISTING COLOR AND PROFILE OF EXISTING ADJACENT WOOD WALL BASE.
 - A40 PAINT EXISTING CERAMIC TILE WALL WAINSCOT AND BASE. SCRAPE EXISTING LOOSE PAINT, LIGHTLY SAND, CLEAN AND PREP SURFACE FOR NEW FINISH.
 - A41 PAINT EXISTING BRICK WALL AND EXPOSED PIPES. SCRAPE EXISTING LOOSE PAINT, LIGHTLY SAND, CLEAN AND PREP SURFACE FOR NEW FINISH.
- c. Basement Partial Floor Plan Area A, 2/A101: Add revision note A41 in Pre-K 001, Storage 001A, Storage 001B and Pre-K 002.
- d. Floor Finish Area Legend: Delete VCT-7, VCT-8 and VCT-9. Add Rooms 209 and 210 to VCT-4, VCT-5 and VCT-6.

Drawing: A101.1

Revisions:

a. Interior Elevation 5/A101.1: Add the dimension 2'-0" from the new markerboard to the adjacent wall on the right side.

Drawing: A103.1

Revisions:

- a. Interior Elevation 4/A103.1: The new plastic laminate shelving should have three support brackets at 36" o.c. in instead of two brackets.
- b. Interior Elevation 6/A103.1: See attached revised drawing A103.1 for revised coat hook layout.

Drawing: A102

Revisions:

- a. First Partial Floor Plan Area B, 2/A102: Add revision note A40 in Kindergarten 103.
- b. Floor Finish Area Legend: Delete VCT-7, VCT-8 and VCT-9. Add Rooms 209 and 210 to VCT-4, VCT-5 and VCT-6.

Drawing: A103

Revisions:

- a. Partial First Floor Plan Area C, 2/A103: Add revision note A40 in Classroom 105 and Classroom 106.
- b. Floor Finish Area Legend: Delete VCT-7, VCT-8 and VCT-9. Add Rooms 209 and 210 to VCT-4, VCT-5 and VCT-6.

Drawing: A105

Revisions:

- a. Partial Second Floor Plan Area E, 3/A105: See attached revised drawing A105 for new detail locations.
- b. Partial Second Floor Plan Area E, 3/A105: The renovation note tag A06 on both sides of the new wall between Classroom 212 and Classroom 214 should be changed to renovation note tag A39.
- c. See attached revised drawing A105 for revised Composite Second Floor Plan, 2/A105, renovation tag A34 changed to A30.

Drawing: A105.1

Revisions:

a. Floor Finish Area Legend: Delete VCT-7, VCT-8 and VCT-9. Add Rooms 209 and 210 to VCT-4, VCT-5 and VCT-6.

Drawing: A105.2

Revisions:

a. See attached revised drawing A105.2 for revised Interior Elevation 22/A105.2.

Drawing: A501

Revisions:

- a. New Partition Detail 4/A501: See attached revised drawing A501 for revised detail.
- b. See attached revised drawing A501 for new wood floor repair details.

Drawing: A901

Revisions:

a. See attached revised drawing A901 for revised Finish Specifications and Room Finish Schedule.

Drawing: All Mechanical and Electrical Drawings

Revisions:

- a. Revised B-numbers on titleblock
- b. Revised Project title on titleblock

Drawing: All mechanical drawings

Revisions:

a. ADD key plan and seal information on all mechanical sheets.

Drawing: M113

Revisions:

a. ADD window AC model information on key note 1 on M113.

- **b.** ADD room 224 on M113
- **c.** DELETE one room not in scope of work on M113

Drawing: **E001**

Revisions:

a. Add light fixture type B and C to lighting fixture schedule.

Drawing: ED101

Revisions:

 Revise existing lighting and power layout in rooms 001 and 002. Added key plan, graphic scale and north arrow.

Drawing: ED111

Revisions:

- a. Added existing lighting in toilets and storage rooms.
- b. Added IDF2 ROOM 102B.
- c. Added key plan, graphic scale and north arrow

Drawing: ED112

Revisions:

- a. Added IDF room 102B.
- b. Added key plan, graphic scale and north arrow.

Drawing: ED121

Revisions:

- a. Added existing lighting layout for rooms 208, 209, 210, 215 and 224.
- b. Added IDF3 room 202A, IDF4 room 222A and Girls Restroom 202.
- c. Added key note 1.
- d. Added key plan, graphic scale and north arrow.

Drawing: **ED122**

Revisions:

- a. Added existing receptacle and data layout in rooms 208, 209, 210, 212, 214, 215 and 224.
- b. Added IDF3 room 202A, IDF4 room 222A and Girls Restroom 202.
- c. Added key note 1.
- d. Added key plan, graphic scale and north arrow.

Drawing: **E101**

Revisions:

- a. Revise lighting and power layout in rooms 001 and 002.
- b. Added key plan, graphic scale and north arrow.
- c. Add key notes 1, 2 and 3.

Drawing: E111

Revisions:

- a. Revised lighting switching and added storage and toilet lighting.
- b. Added IDF room 102B.
- c. Added key plan, graphic scale and north arrow

Drawing: **E112**

Revisions:

- a. Added receptacles in rooms 102, 103, 105, 106 and 107.
- b. Added IDF room 102B.
- c. Added key notes 1, 2, 3, 4 and 5.
- d. Added key plan, graphic scale and north arrow.

Drawing: **E121**

Revisions:

- a. Revised lighting layout and switching in rooms 208, 209, 210, 212, 214, 215 and 224.
- b. Added IDF3 room 202A and girls restroom 202.
- c. Added key plan, graphic scale and north arrow.

Drawing: **E122**

Revisions:

- a. Added new receptacle and data layout in rooms 208, 209, 210, 212, 214, 215 and 224.
- b. Added IDF3 room 202A, IDF4 room 222A and Girls Restroom 202. Added key note 3 and 4.
- c. Added key plan, graphic scale and north arrow

Drawing: **E301**

Revisions:

- a. Deleted panelboard cover detail.
- b. Added note to data riser diagram.

BIDDER'S QUESTIONS

1. <u>Question</u>: Due to the scope of work for all projects, the substantial completion date is unachievable. Along with lost time for moving of furniture and equipment before start of project. Can the date for substantial completion be extended?

Response: No

2. Question: Visual Display Surfaces - in spec there is a note if new boards are not installed in time, to use temporary boards as necessary, how many temporary boards are we to provide per classroom?

Response: Temporary boards do not need to be provided.

3. Question: Do we need to provide temporary window shades, if new ones are not installed before start of school?

Response: No. Existing shades are to be removed and salvaged/protected and reinstalled until new shades can be installed.

Question: Wood Floor Refinishing- some projects call for 2 coats of stain, can we forgo the stain and just use 2 coats of sealer and 2 coats of finish for all projects. You are adding on time to an already accelerated schedule.

<u>Response:</u> Sand, seal, and finish the wood floors in accordance with the specifications. Omit staining of the floor.

5. Question: Have you checks on the choices of accent colors for the VCT tile? The colors may be a stock color, but do they have enough on hand, if not they may not be readily available for the substantial completion date.

<u>Response:</u> Armstrong has been made aware of this project and its approximate square footage needs. Contractor to provide updated information on each color's availability immediately after NTP.

6. Question: Can you please include and spec for electrostatic painting.

Response: See Electrostatic Paint spec in Addendum #2.

7. **Question**: Classroom 105 and 107 show type B 2x4 surface mounted fixtures, but the architectural RCP's shown existing ACT grid ceilings. Is the fixture specification correct?

<u>Response</u>: Classroom 105 has an existing ACT ceiling with surface mounted light fixtures and classroom 107 has an existing ACT ceiling with recessed mounted light fixtures.

8. **Question**: Panelboard cover detail 3 was shown on drawing E301 and a panelboard spec was included in the contract documents. No panel schedule and no one line diagram were shown on the drawings. Please confirm this spec and detail are not applicable to this project as we do not see any panelboards on this project.

<u>Response:</u> Panelboard cover detail and specification are not applicable for this school, specification applies to other schools also.

9. <u>Question:</u> Some speakers are tagged with the letter "E" meaning existing to remain, but some are not tagged with this. Please confirm all speakers are existing to remain on this project. If this is not the case, please provide basis of design manufacturer/model of speaker for rooms shown with providing a new speaker.

Response: Existing speakers are to remain unless otherwise noted on the existing drawings.

10. Question: Detail 1 drawing E301 shows (2) 2-jack data outlet and (1) 4-jack data outlet for each classroom; however these symbols with the D2 and D4 subscripts don't appear on the new work drawings. There are some data outlets shown with the subscript "2" for 2 data lines, but they don't appear in all the classrooms. Most of the data outlets are shown with a tag "E" for existing to remain. Please clarify design. Is each classroom supposed to get a (1) 2-jack data outlet and (1) 4-jack data outlet? If so please locate these devices on the floor plans.

Response: Yes, each classroom requires a minimum of (1) 2-jack data outlet and (1) 4-jack data outlet. Will locate data outlet location.

11. Question: Is each classroom supposed to get (1) 2" EMT conduit back to the data rack per detail 1 drawing E301?

<u>Response</u>: Detail 1 on drawing E301 is a typical detail, contractor may combine Cat 6 cables to a 2" inch conduit not to exceed allowable conduit fill.

12. Question: Detail 1 drawing E301 says a note about an existing data racks in MDF and IDF, but does not state whether the cables are supposed to go the MDF or IDF. Also the MDF and IDF rooms are not labeled on the floor plans. Please clarify where the existing data rack is located on the floor plan and whether the MDF or the IDF rack contains the rack mounted master clock.

Response: Note on detail 1/ E301 indicates "PROVIDE NEW PATCH PANEL TO MATCH EXISTING AND COORDINATE WITH OWNER PRIOR TO INSTALLTION TERMINATE EACH CABLE AT NEW PATCH PANEL". Room names and numbers are indicate on detail 1/E301. Existing Master clock is not located in existing MDF/IDF rooms, the existing wired master clock is to remain since all the classrooms are not being renovated. The new wireless clock shall be located as shown on detail 1/E301.

13. Question: (2) dimmer switches are shown in each classroom, but no zoning (a/b) is indicated on the electrical lighting plans. How are the fixtures supposed to be zoned?

Response: Will clarify and indicate classroom new lighting zoning control (a/b).

14. Question: Childs School- Mechanical note #1 What is your scope of work for refurbishment of the existing radiators and covers?

<u>Answer:</u> The scope of work for refurbishing steam radiators and covers include clean and remove dust from the radiator surface and cover. Disconnect radiator and remove sediment clogs from the coil and reconnect. Paint radiator cover.

15. Question: Can SDP provide pdf's of as built architectural or electrical drawings for takeoff purposes? We acknowledge that they may not be completely accurate, but we need them for takeoffs for data conduits back to the IT rack. The overall building floor plan for each floor is not shown on the architectural or electrical drawings.

Response: As-built drawings will not be provided.

16. Question: Classroom 002 shows what appears to be a 3 way dimmer configuration; however, one door has 3 dimmers and the other door has 2 dimmers. There is no zoning shown for the room and a wiring diagram on drawing E-301 was not provided. Please provide basis of design manufacturer/model #'s for the dimmers that can achieve required control intent. Are standalone digital lighting controls required to achieve control intent?

Response: There is no 3 way dimmer switching required. There are 3 dimmer switches in each classroom 001 and 002. For classrooms lighting zoning see Addendum 1 drawings E101 and E301. For dimmer switch basis of design control diagram and manufacturer see classroom LED lighting control diagram on drawing E301. The dimmer switches are standalone dimmer switches.

ATTACHMENTS

Drawing A103.1

Drawing A105

Drawing A105.2

Drawing A501

Drawing A901

Drawing M001

Drawing MD111

Drawing MD112

Drawing MD113

Drawing M111

Drawing M112

Drawing M113

Drawing M001

Drawing E001

Drawing ED101

Drawing ED111

Drawing ED112

Drawing ED121

Drawing ED122

Drawing E101 Drawing E111


Drawing E112


Drawing E121


Drawing E122


Drawing E301


End of Addendum No. 001

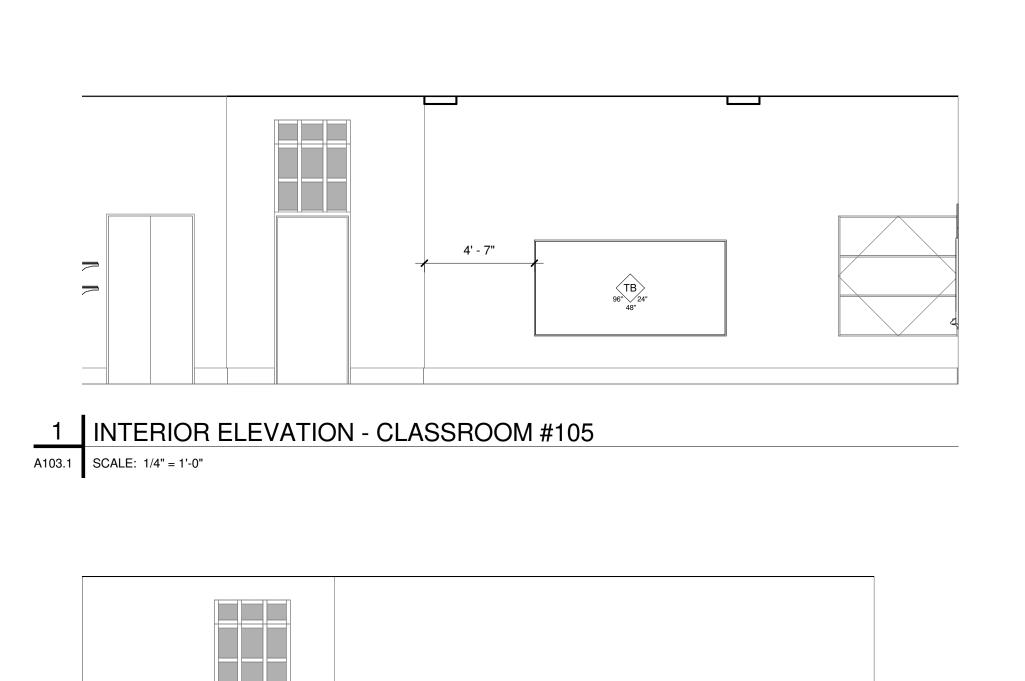

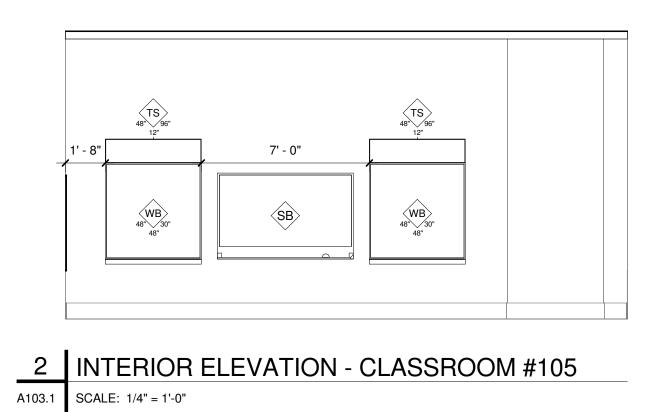


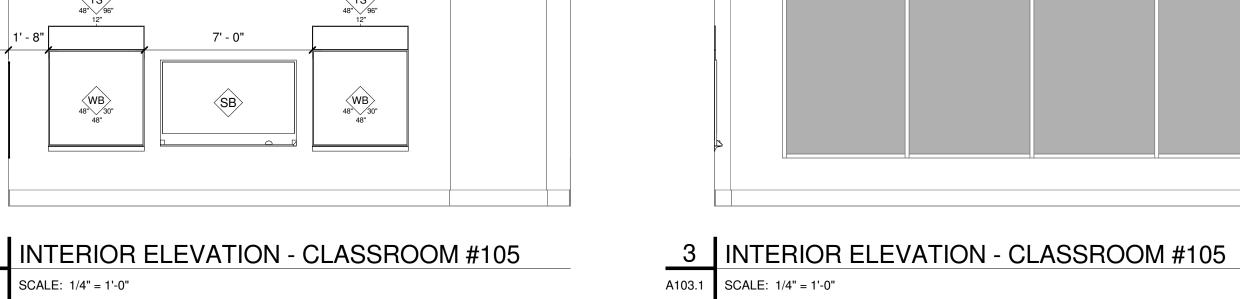

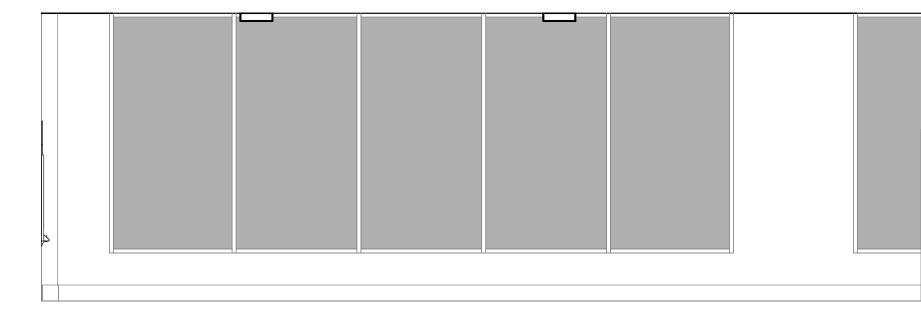


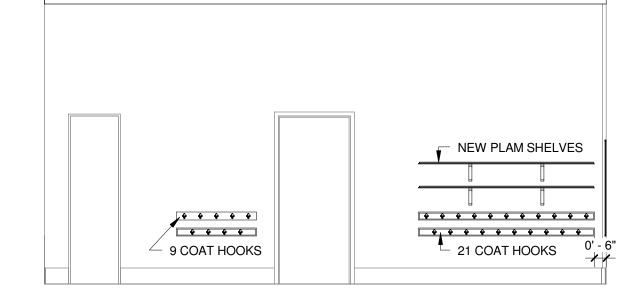


4 INTERIOR ELEVATION - CLASSROOM #105
A103.1 SCALE: 1/4" = 1'-0"

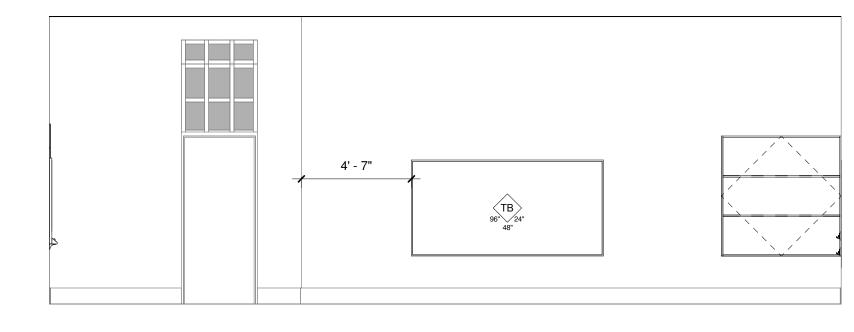


5 INTERIOR ELEVATION - CLASSROOM #106
A103.1 SCALE: 1/4" = 1'-0"

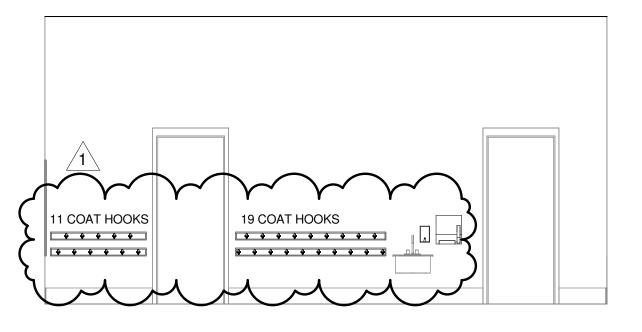


6 INTERIOR ELEVATION - CLASSROOM #106
A103.1 SCALE: 1/4" = 1'-0"

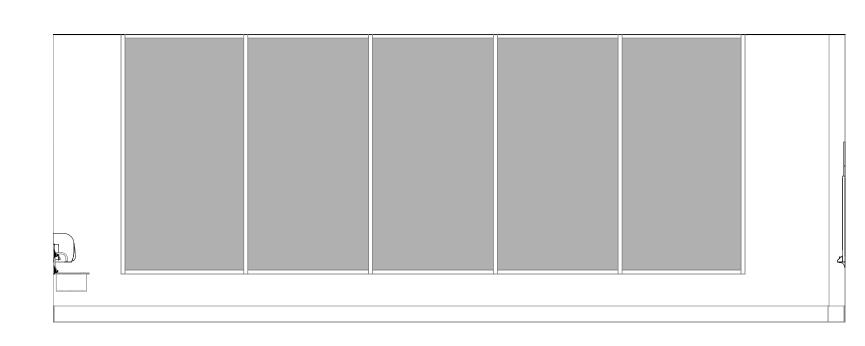


7 INTERIOR ELEVATION - CLASSROOM #106
A103.1 SCALE: 1/4" = 1'-0"

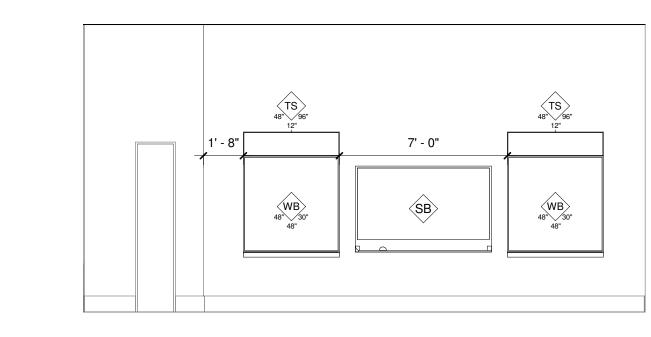


8 INTERIOR ELEVATION - CLASSROOM #106
A103.1 SCALE: 1/4" = 1'-0"

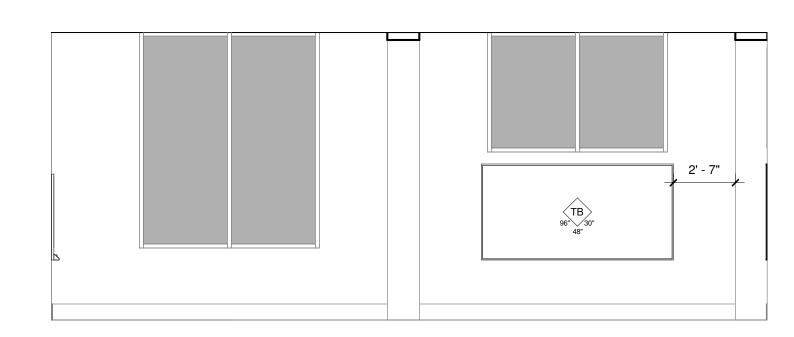


9 INTERIOR ELEVATION - CLASSROOM #107
A103.1 SCALE: 1/4" = 1'-0"

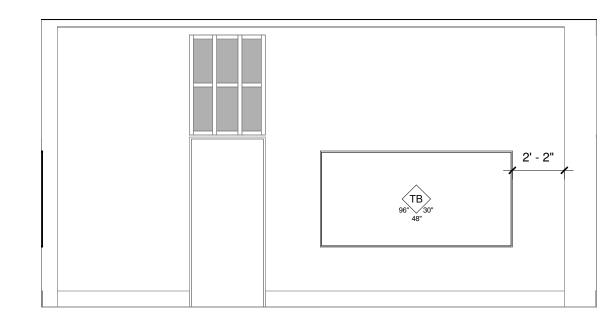


10 INTERIOR ELEVATION - CLASSROOM #107
A103.1 SCALE: 1/4" = 1'-0"

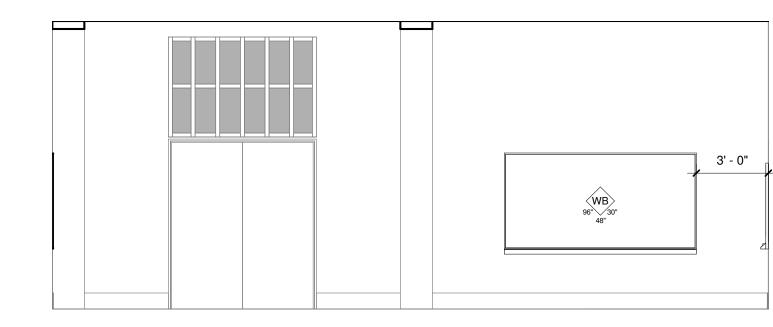

11 INTERIOR ELEVATION - CLASSROOM #107
A103.1 SCALE: 1/4" = 1'-0"

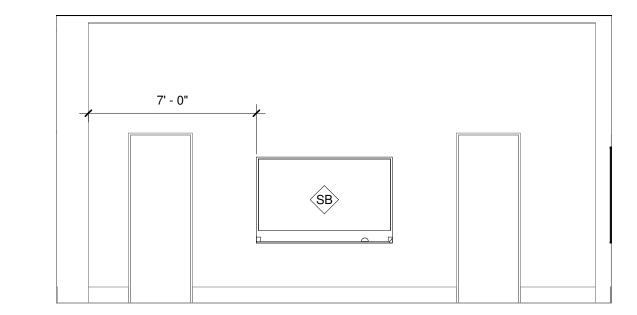

12 INTERIOR ELEVATION - CLASSROOM #107
A103.1 SCALE: 1/4" = 1'-0"

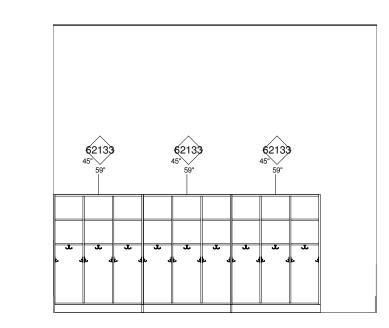

13 INTERIOR ELEVATION - CLASSROOM #107A A103.1 SCALE: 1/4" = 1'-0"

BID DOCUMENTS April 20, 2018

1 5/9/18 ADDENDUM #1

THE SCHOOL DISTRICT OF PHILADELPHIA

OFFICE OF CAPITAL PROGRAMS

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NO. DATE REVISION SCHOOL & LOCATION

G.W. Childs School

1599 Wharton St, Philadelphia, PA 19146

PROJECT TITLE


Classroom Modifications to G.W. Childs School

DRAWING TITLE


FIRST FLOOR INTERIOR ELEVATIONS AREA C

LOCATION NO. FILE NO. XX-XXX CHECKED BY DRAWN BY B-071 C **OF** 2017/18 B-074 C **OF** 2017/18



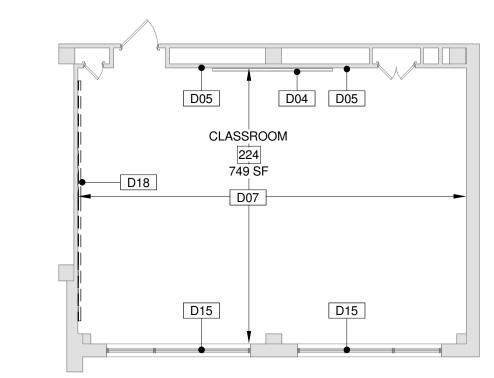


COMPOSITE SECOND FLOOR PLAN A105 SCALE: 1/8" = 1'-0"

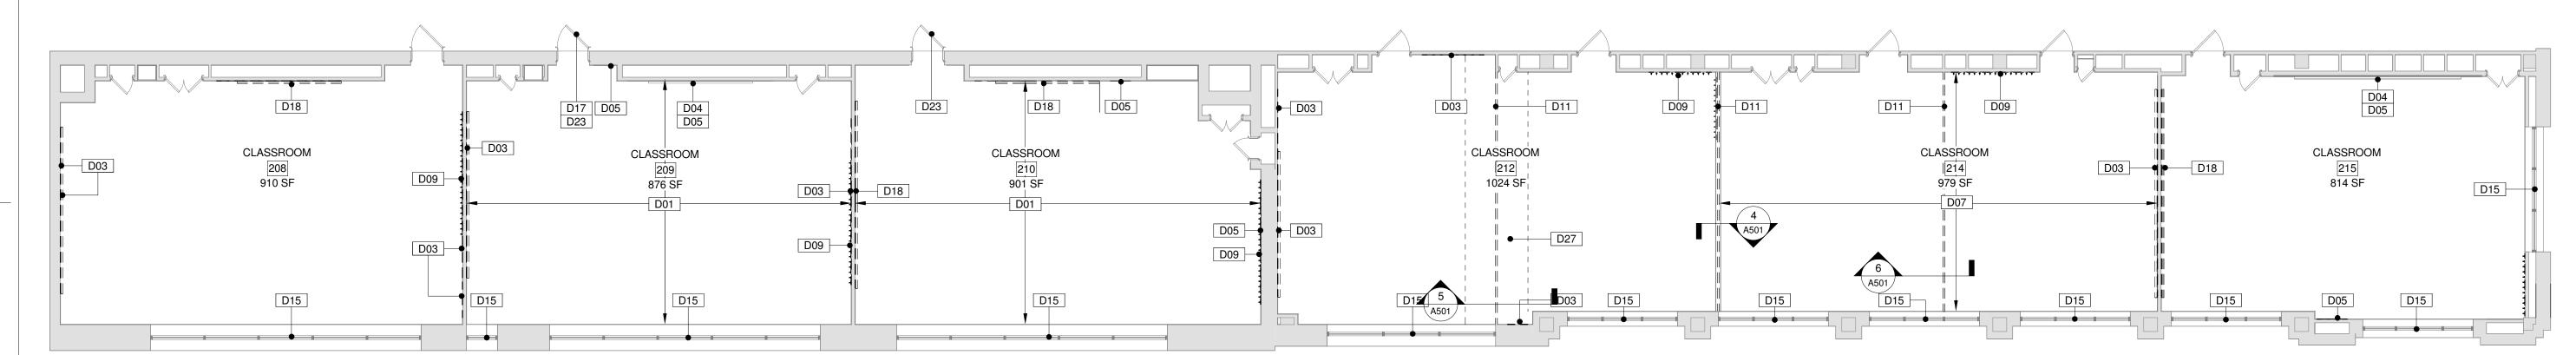


1 PARTIAL SECOND FLOOR DEMOLITION PLAN - AREA E

A105 SCALE: 1/8" = 1'-0"

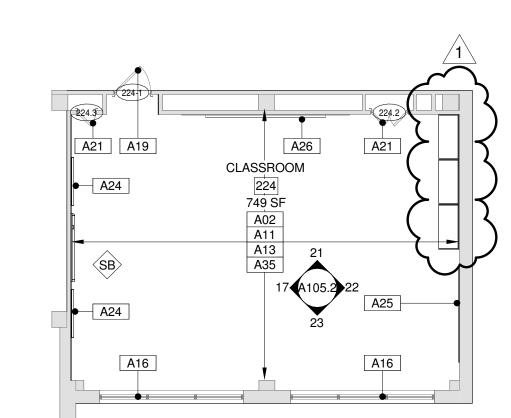


2 COMPOSITION A105 SCALE: 1/8" = 1'-0" COMPOSITE SECOND FLOOR PLAN

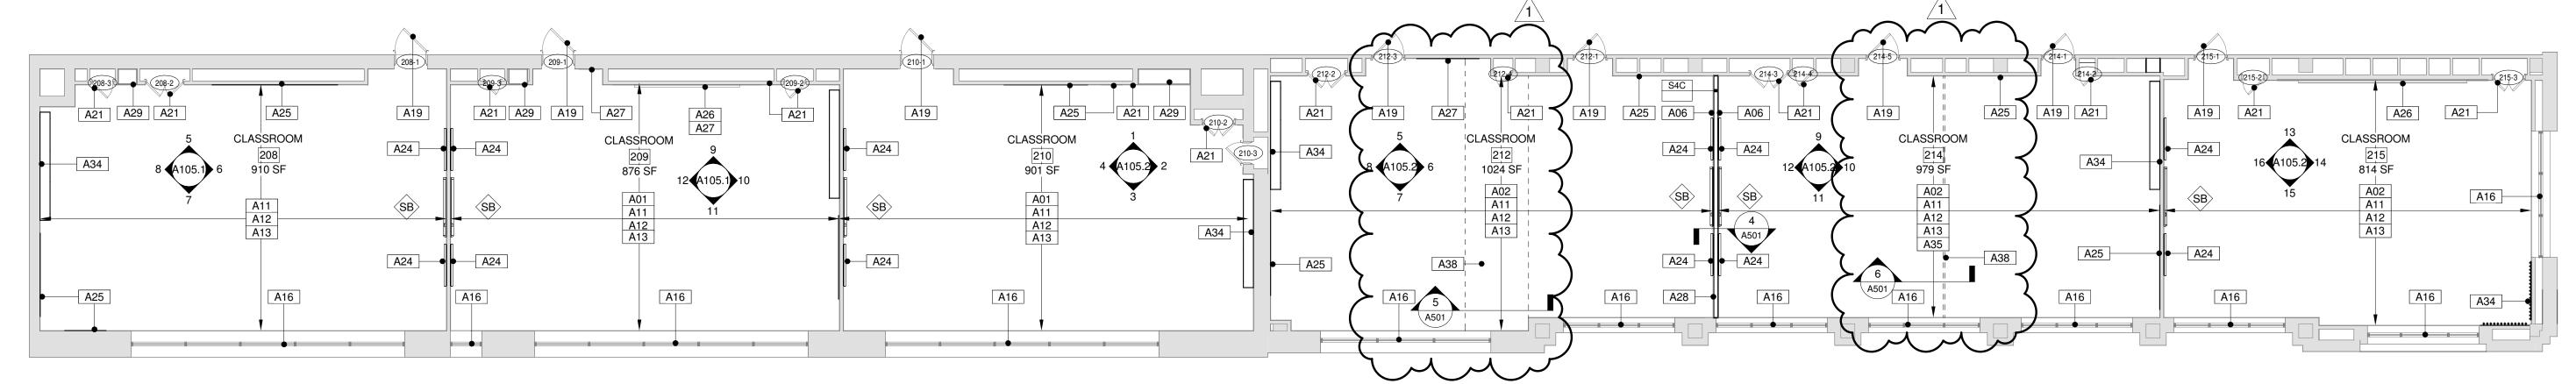


PARTIAL SECOND FLOOR PLAN - AREA E

A105 SCALE: 1/8" = 1'-0"

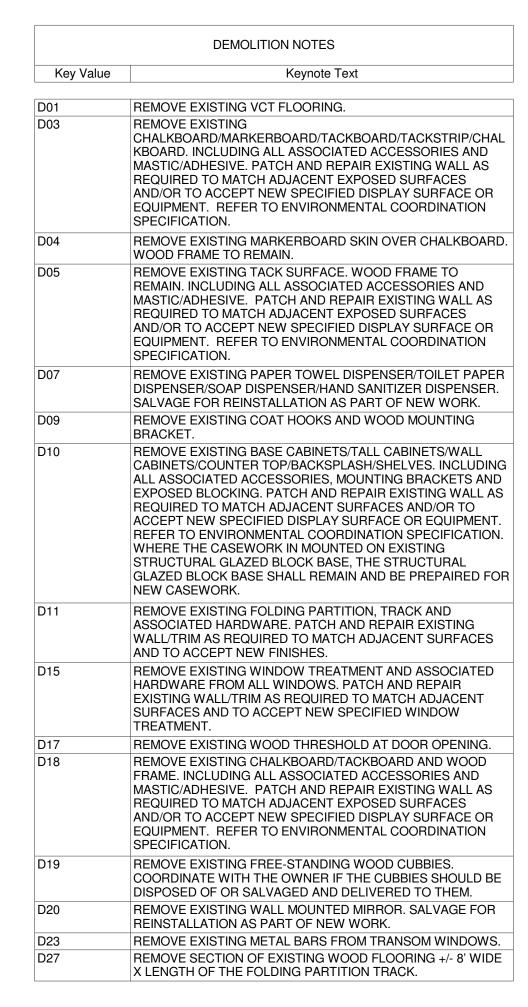

Key Value	Keynote Text				
rey value	regriote rext				
A01	INSTALL NEW VCT FLOORING. CLEAN, FLASH PATCH AND LEVEL FLOOR AS REQUIRED. PREP FLOOR TO RECEIVE NEW FINISH. REFER TO ENVIRONMENTAL COORDINATIONS SPECIFICATION.				
A02	STRIP AND SAND, PATCH, CLEAN AND PREP EXISTING WOOD FLOORING AND PROVIDE A NEW CLEAR COAT FINISH. REPAIR ANY DAMAGED FLOORING AS REQUIRED, NEW FLOORING TO MATCH EXISTING ADJACENT FLOORING. COORDINATE LOCATIONS OF NEW FLOORING IN THE FIELD WITH THE OWNER.				
A03	PAINT EXISTING METAL COVERS AT FLOOR PIPE CHASES. SCRAPE EXISTING LOOSE PAINT, SAND, CLEAN AND PREP SURFACE FOR NEW FINISH.				
A06	INSTALL NEW RUBBER WALL BASE. CLEAN AND PREP EXISTING SURFACE FOR NEW FINISH. PAINT EXISTING CONCRETE WALL BASE. SCRAPE EXISTING				
A08	LOOSE PAINT, SAND, CLEAN AND PREP SURFACE FOR NEW FINISH.				
A11	PATCH, LIGHTLY SAND, CLEAN (INCLUDING THE REMOVAL OF ALL STAPLES, ETC.) AND PREP EXISTING WOOD WALL BASE/WALL TRIM/DOOR FRAME-TRIM/WINDOW TRIM/CHALKBOARD-TACKBOARD FRAME AND PROVIDE A NEW PAINT FINISH. REPAIR DAMAGED AREAS TO MATCH ADJACENT PROFILE.				
A12	PAINT EXISTING CMU/PLASTER/GWB AND EXPOSED PIPES. SCRAPE EXISTING LOOSE PAINT, SAND, (INCLUDING THE REMOVAL OF ALL STAPLES, ETC.) CLEAN AND PREP SURFACE FOR NEW FINISH.				
A13	REPAIR DAMAGED EXISTING PLASTER WALL/CEILING/BULKHEAD TO MATCH ADJACENT SURFACE. PREP REPAIRED AREAS TO RECEIVE NEW PAINT FINISH.				
A15	PAINT EXISTING PLASTER/GWB CEILING/BULKHEAD AND EXPOSED PIPES. SCRAPE EXISTING LOOSE PAINT, SAND, CLEAN AND PREP SURFACE FOR NEW FINISH.				
A16	INSTALL NEW INTERIOR WINDOW SHADES AS SPECIFIED ON ALL EXTERIOR WINDOW UNITS IN CLASSROOM.				
A18 A19	REPAIR/PATCH EXISTING DAMAGED WOOD DOOR AND/OR FRAME. FINISH TO MATCH ADJACENT SURFACE. REPAIR/PATCH EXISTING DAMAGED DOOR TRANSOM				
	(INCLUDING FRAME, GRILLES AND GLASS). MATCH EXISTING ADJACENT. CLEAN, SAND, AND FINISH AS SCHEDULED.				
A21	PATCH, LIGHTLY SAND, CLEAN (INCLUDING THE REMOVAL OF ALL STAPLES, ETC.) AND PREP EXISTING WOOD DOOR AND PROVIDE NEW PAINT FINISH. REPAIR DAMAGED AREAS TO MATCH ADJACENT PROFILE, INCLUDING WOOD GRILLES AND GLASS WHERE OCCURS. DAMAGED WOOD AND GLAZING AREAS SHOULD BE REVIEWED WITH THE OWNER IN THE FIELD.				
A23	INSTALL NEW ADA COMPLIANT DOOR THRESHOLD.				
A24	INSTALL NEW MARKERBOARD AS SCHEDULED.				
A25 A26	INSTALL NEW TACKBOARD AS SCHEDULED. INSTALL NEW MARKERBOARD SKIN OVER EXISTING CHALKBOARD.				
A27	INSTALL NEW TACK SURFACE IN EXISTING WOOD FRAME.				
A28	INSTALL NEW STUD/GWB WALL AS SCHEDULED IN EXISTING FOLDING PARTITION OPENING. FINISH/PAINT AS SCHEDULED (BOTH SIDES).				
A29	PATCH, LIGHTLY SAND, CLEAN (INCLUDING THE REMOVAL OF ALL STAPLES, ETC.) AND PREP EXISTING WOOD CASEWORK/COUNTER TOP/SHELVES AND PROVIDE NEW CLEAR COAT FINISH. REPAIR DAMAGED AREAS/HARDWARE TO MATCH EXISITNG ADJACENT.				
A30	INSTALL NEW PLASTIC LAMINATE CASEWORK AS SCHEDULED.				
A34	INSTALL NEW COAT HOOKS (30 HOOKS).				
A35	RE-INSTALL SALVAGED PAPER TOWEL DISPENSER/TOILET PAPER DISPENSER/SOAP DISPENSER/HAND SANITIZER DISPENSER.				
A36 A38	CLEAN EXISTING MARBLE TOILET PARTIONS AND WAINSCOT. INSTALL NEW WOOD FLOORING AND CLEAR COAT FINISH. MATCH EXISTING ADJACENT FLOOR SYSTEM.				
A40	PAINT EXISTING CERAMIC TILE WALL WAINSCOT AND BASE. SCRAPE EXISTING LOOSE PAINT, LIGHTLY SAND, CLEAN AND				
A41	PREP SURFACE FOR NEW FINISH. PAINT EXISTING BRICK WALL AND EXPOSED PIPES. SCRAPE EXISTING LOOSE PAINT, LIGHTLY SAND, CLEAN AND PREP SURFACE FOR NEW FINISH.				

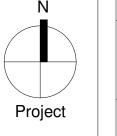


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BID DOCUMENTS April 20, 2018

1 5/9/18 ADDENDUM #1 NO. DATE REVISION

SCHOOL & LOCATION G.W. Childs School

1599 Wharton St, Philadelphia, PA

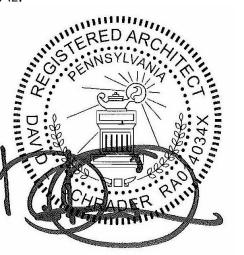
PROJECT TITLE **Classroom Modifications to G.W. Childs School**

DRAWING TITLE

PARTIAL SECOND FLOOR FLOOR PLANS

LOCATION NO. FILE NO. XX-XXX CHECKED BY DRAWN BY B-071 C **OF** 2017/18 B-074 C **OF** 2017/18

DRAWING NO.

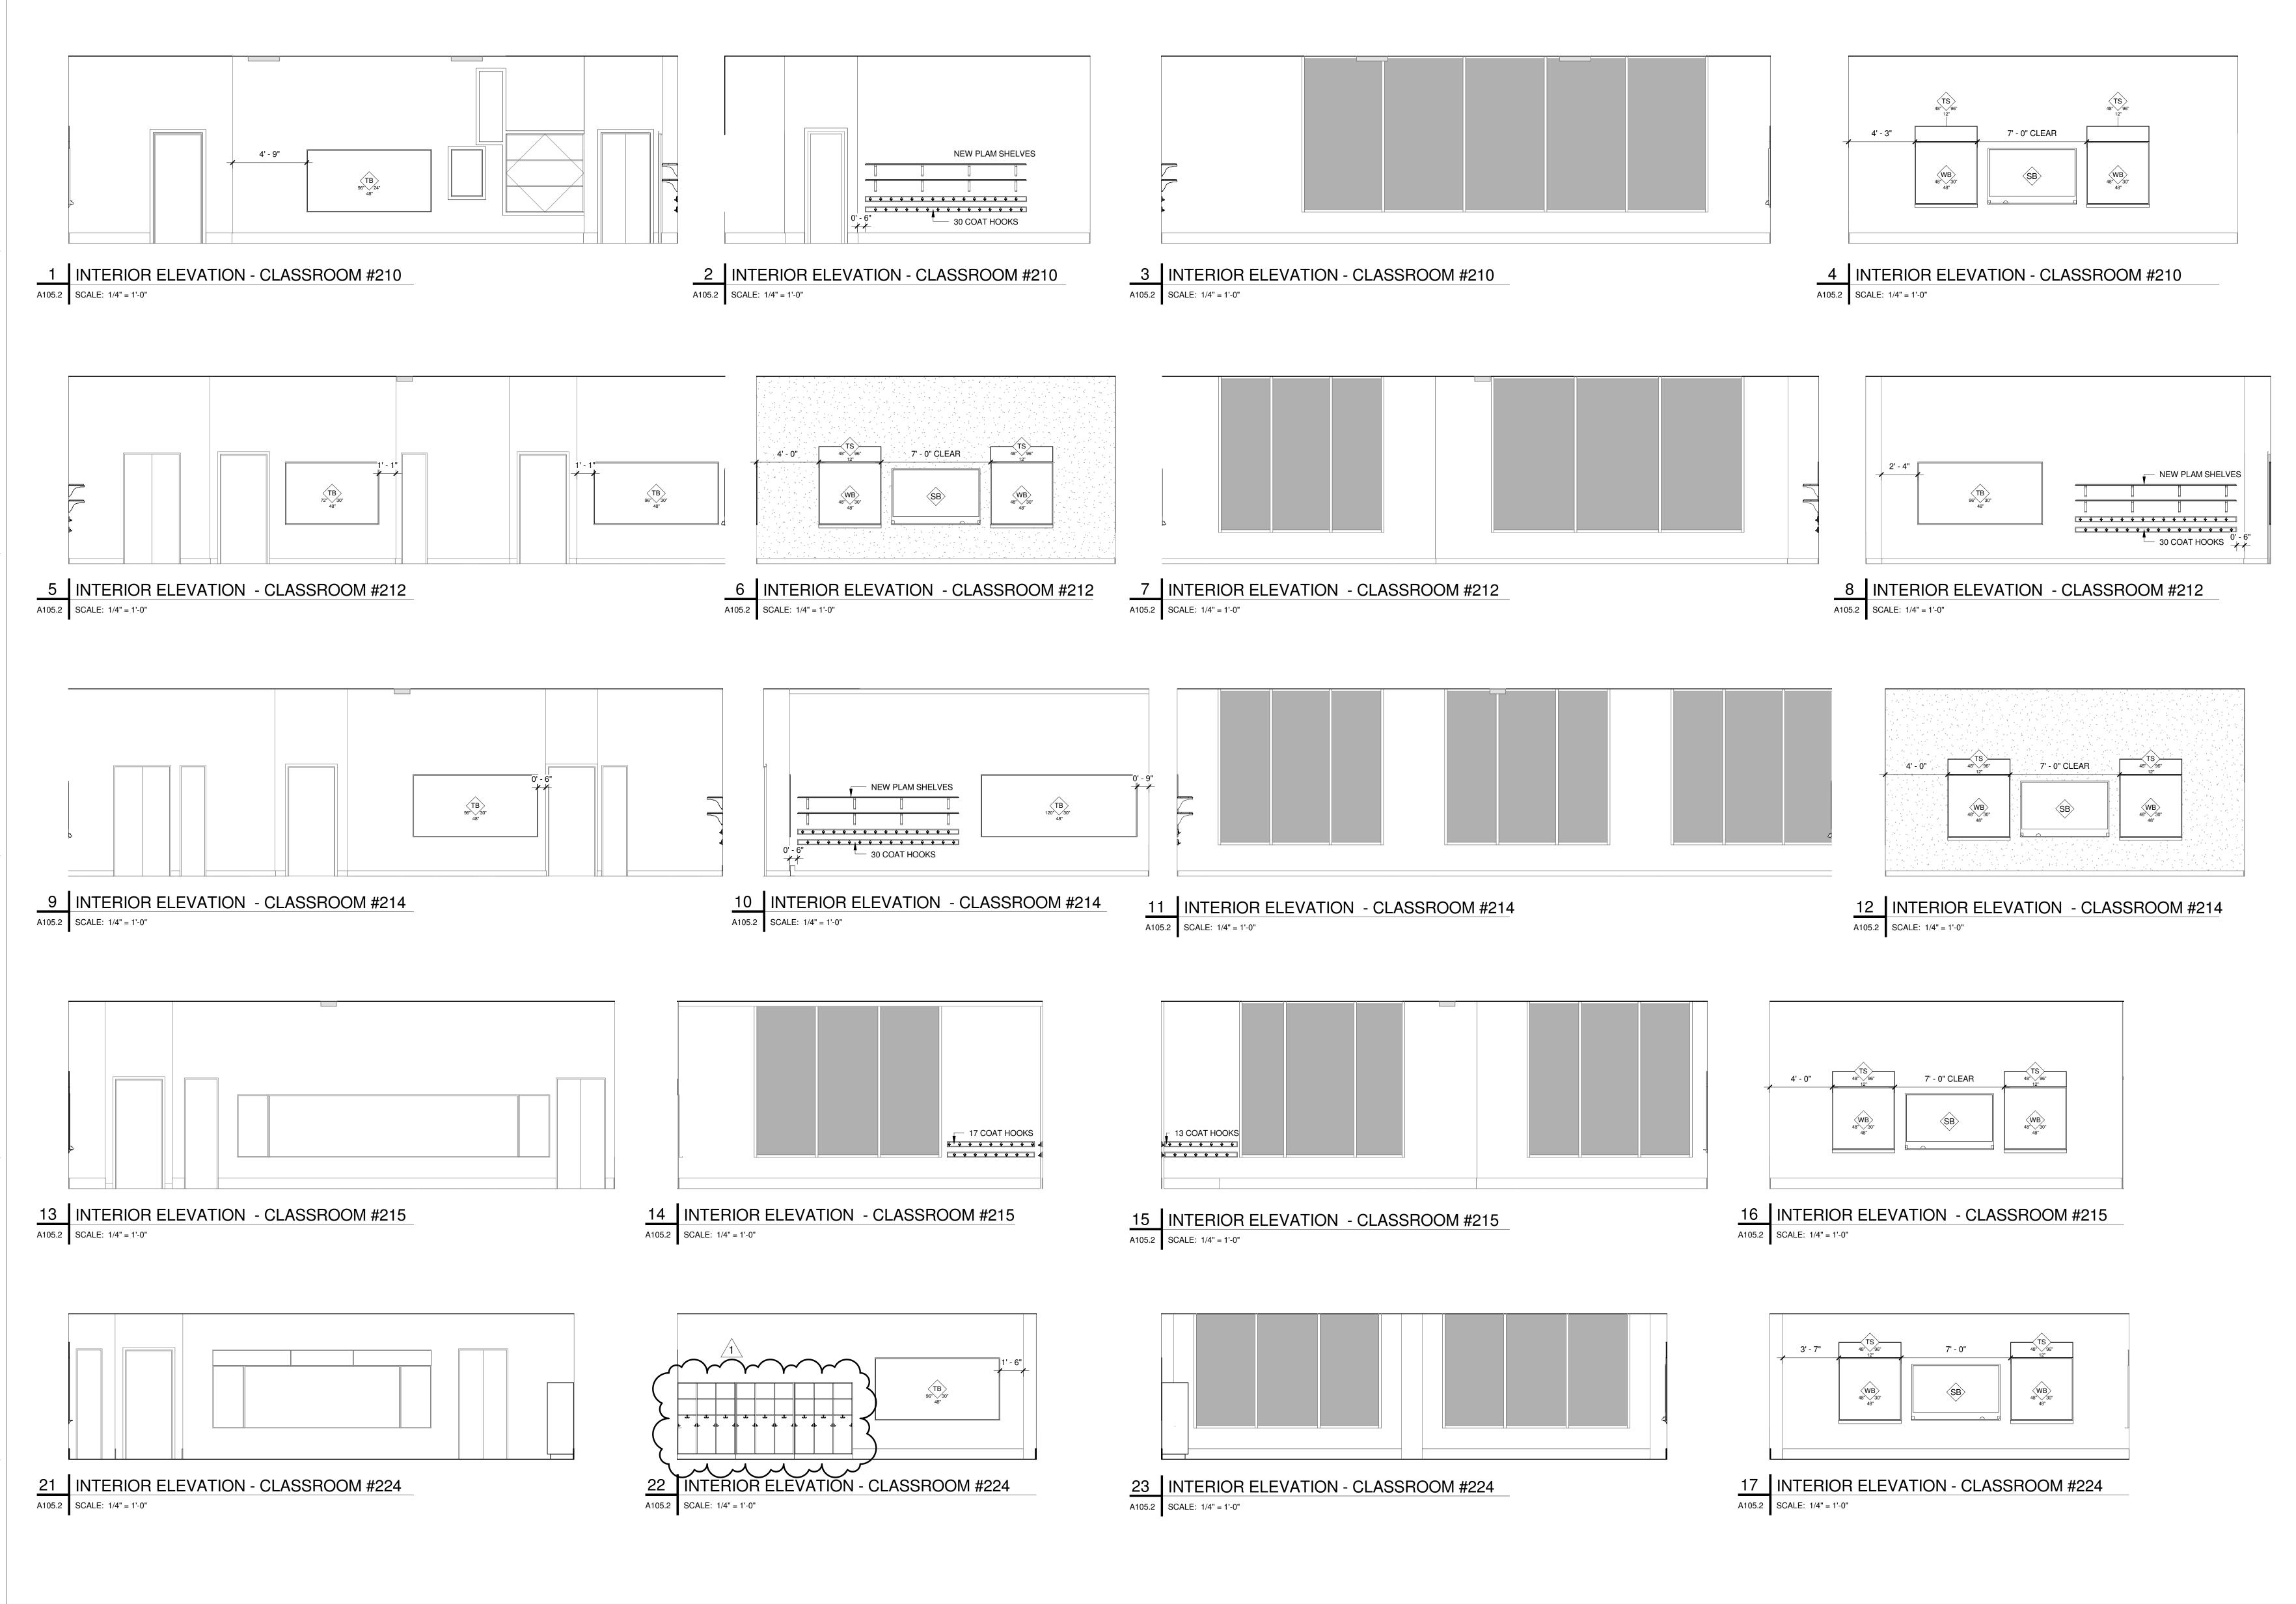


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NAME (LICENSED PROFESSIONAL)

STATE AND LICENSE NO:

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BID DOCUMENTS April 20, 2018

SCHOOL & LOCATION

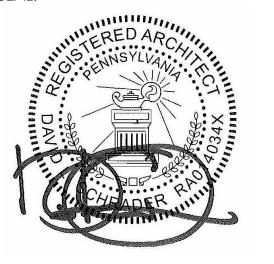G.W. Childs School

1599 Wharton St, Philadelphia, PA

19146

PROJECT TITLE

Classroom Modifications to G.W.

DRAWING TITLE

Childs School

PARTIAL SECOND FLOOR INTERIOR ELEVATIONS AREA E

LOCATION NO. FILE NO.

XX-XXX


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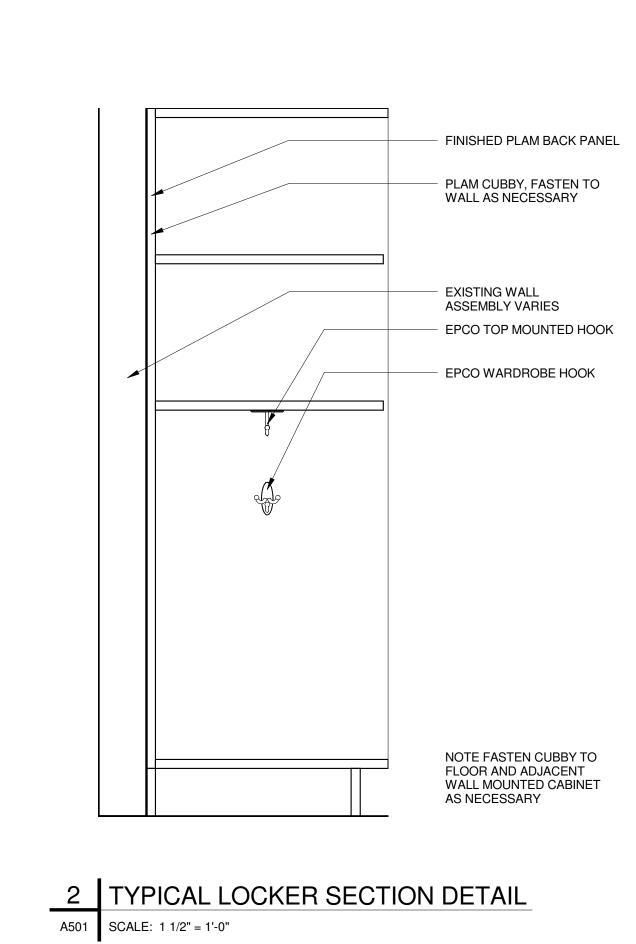
Author


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B-071 C OF 2017/18
B-074 C OF 2017/18


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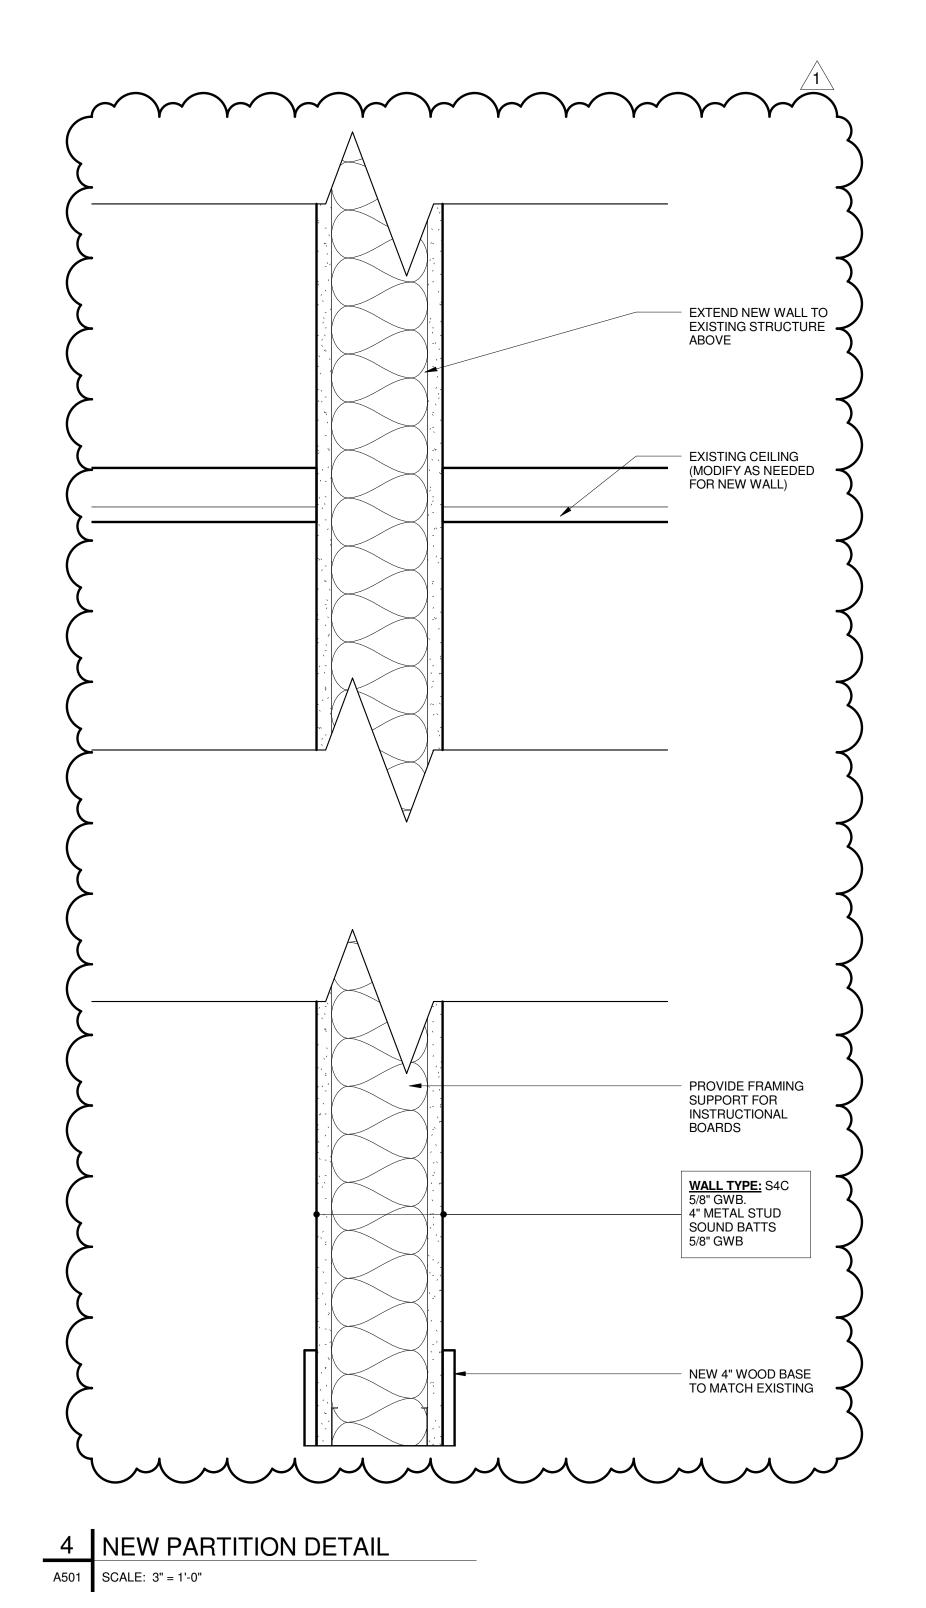






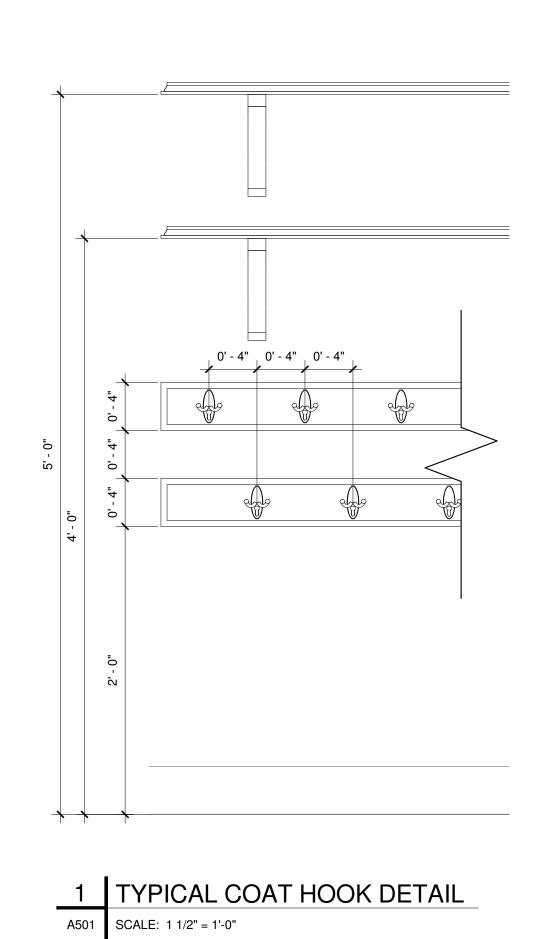

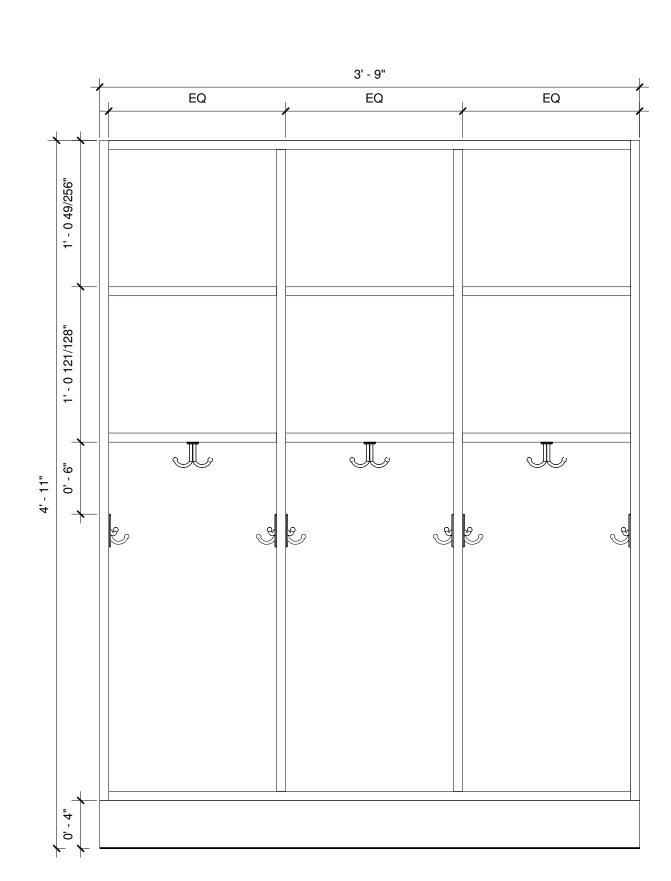

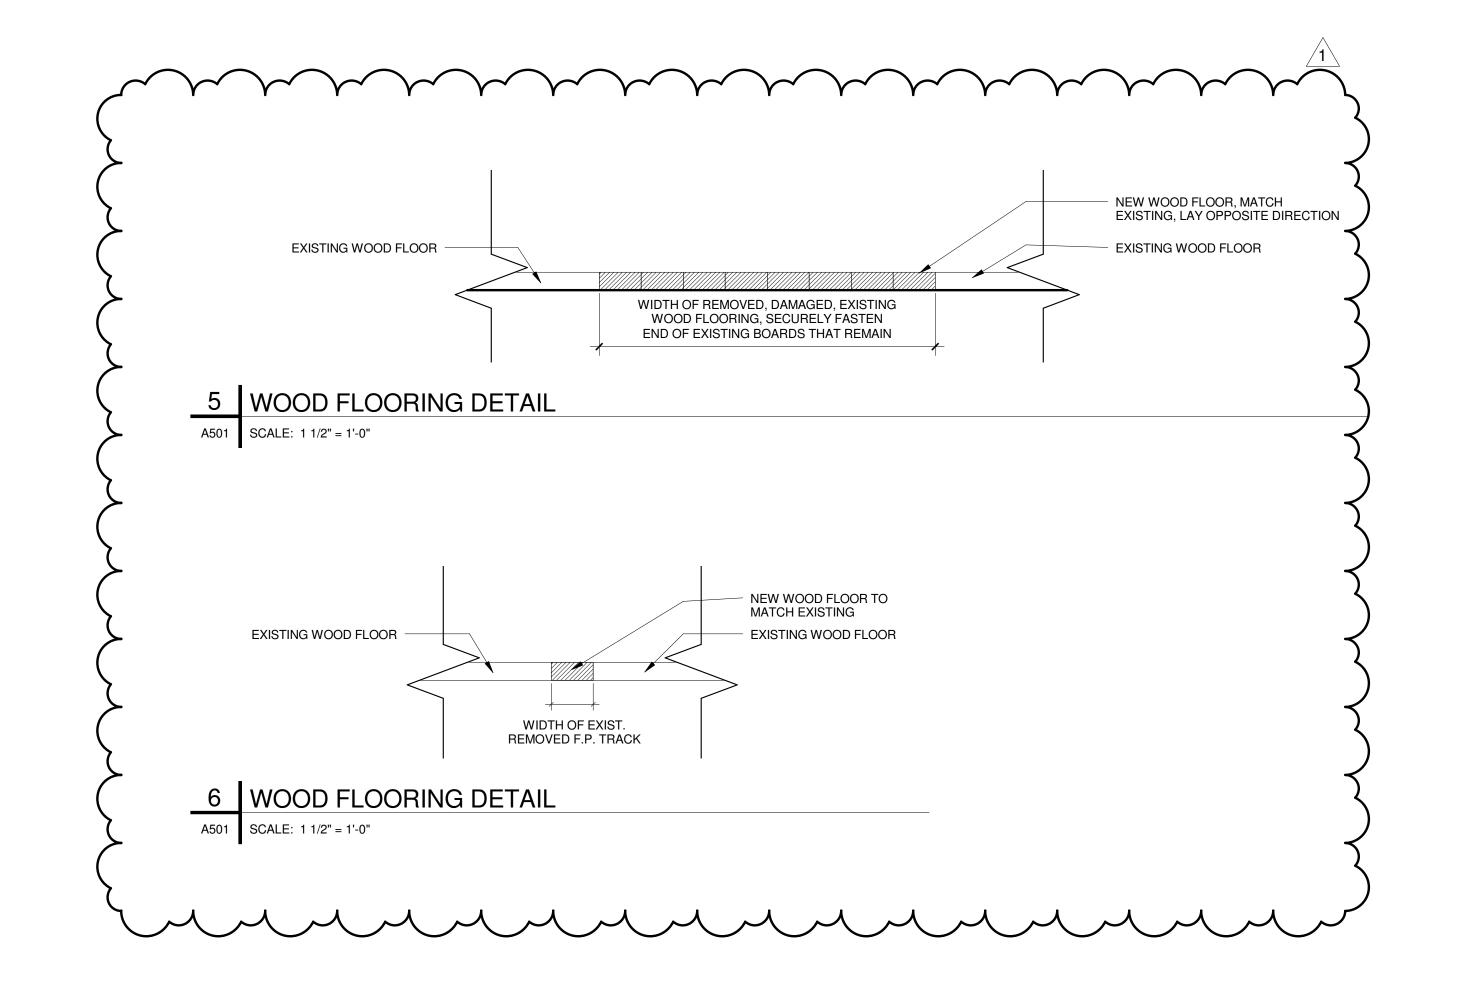


OFFICE OF CAPITAL PROGRAMS

THE SCHOOL DISTRICT OF PHILADELPHIA

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NAME (LICENSED PROFESSIONAL)

STATE AND LICENSE NO:

XX/XX/20XX
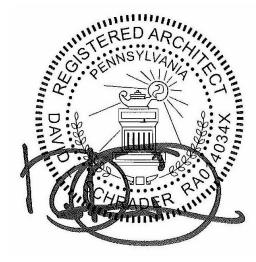
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Phone: 301.216.2871 Fax: 301.216.9671 Email: AnilG@theges.com Attn: Anil Giri

BID DOCUMENTS April 20, 2018

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1	5/9/18	ADDENDUM #1
NO.	DATE	REVISION

SCHOOL & LOCATION

G.W. Childs School

1599 Wharton St, Philadelphia, PA 19146


Classroom Modifications to G.W. Childs School

PROJECT TITLE

DRAWING TITLE

DETAILS

LOCATION NO. XX-XXX	FILE NO.
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Author	Checker
B-071 C	OF 2017/18

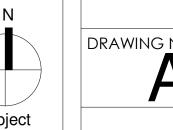

	ROOM	FLOOR	BASE		WAL	L FINISH		CEILIN	IG FINISH	CASEWORK	(FINISH	
ROOM#	NAME	FINISH	TYPE	NORTH	EAST	SOUTH	WEST	MATERIAL	FINISH	COUNTERTOP	CABINET	COMMENTS
01	PRE-K	VCT-4,5,6	PT-8	PT-6	PT-6	PT-6	PT-7	EX	-	-	-	PT-8 AT DOOR FRAMES, TRIM, ETC
01A	STORAGE	VCT-4	PT-8	PT-6	PT-6	PT-6	PT-6	EX	PT-9	-	PLAM-2	PT-8 AT DOOR FRAMES, TRIM, ETC, B-1 AT CUBBIES
01B	STORAGE	VCT-4	PT-8	PT-6	PT-6	PT-6	PT-6	EX	PT-9	-	-	PT-8 AT DOOR FRAMES, TRIM, ETC
02	PRE-K	VCT-4,5,6	PT-8	PT-7	PT-6	PT-6	PT-6	EX	-	-	PLAM-2	PT-8 AT DOOR FRAMES, TRIM, ETC, B-1 AT CUBBIES
02	KINDERGARTEN	VCT-1,2,3	PT-8	PT-3	PT-1	PT-1	PT-1	EX	-	-	PLAM-2	PT-8 AT DOOR FRAMES, TRIM, ETC, B-1 AT CUBBIES
02A	STORAGE	VCT-1	PT-8	PT-2	PT-2	PT-2	PT-1	EX	-	-	-	PT-8 AT DOOR FRAMES, TRIM, ETC
03	KINDERGARTEN	VCT-1,2,3	PT-8	PT-3	PT-1	PT-1	PT-1	EX	PT-9 (BULKHEAD)	-	PLAM-2	PT-8 AT DOOR FRAMES, TRIM, ETC, B-1 AT CUBBIES
)3A	STORAGE	VCT-1	PT-8	PT-2	PT-2	PT-2	PT-2	EX	-	-	-	PT-8 AT DOOR FRAMES, TRIM, ETC
)5	CLASSROOM	VCT-1,2,3	PT-8	PT-1	PT-3	PT-1	PT-1	EX	PT-9 (BULKHEAD)	-	-	PT-8 AT DOOR FRAMES, TRIM, ETC
)5A	STORAGE	VCT-1	PT-8	PT-2	PT-2	PT-2	PT-2	EX	-	-	-	PT-8 AT DOOR FRAMES, TRIM, ETC
06	CLASSROOM	VCT-1,2,3	PT-8	PT-1	PT-1	PT-1	PT-3	EX	-	-	-	PT-8 AT DOOR FRAMES, TRIM, ETC
06A	STORAGE	VCT-1	PT-8	PT-2	PT-2	PT-2	PT-2	EX	-	-	-	PT-8 AT DOOR FRAMES, TRIM, ETC
06B	STORAGE	VCT-1	PT-8	PT-2	PT-2	PT-2	PT-2	EX	-	-	-	PT-8 AT DOOR FRAMES, TRIM, ETC
)7	CLASSROOM	VCT-1,2,3	PT-8	PT-1	PT-1	PT-1	PT-3	EX	PT-9 (BULKHEAD)	-	$\dot{\sim}$	PT-8 AT DOOR FRAMES, TRIM_ETC
7A	STORAGE	VQT-1	P7-8	N-2	№ 7-2	PI-2	RT-2	EX	-	-	PLAM-	PT-8 AVDOOR FRAMES, TRIMETE, B-1 AVCOBBIES
)7B	TOILET	P1/8	Y PT-8 Y	PT 1	Y PT-1 Y	YPT-1	P Y -1	EX	-	- /	-	PT-8 AT DOOR FRAMES, TRIM, ETC
18	CLASSROOM	EX	PT-8	PT-6	PT-7	PT-4	PT-6	EX	-	-	-	PT-8 AT DOOR FRAMES, TRIM, ETC, B-1 AT CUBBIES, EXISTING WOOD FLOOR TO RECEIVE CLEAR COAT FINI
	CLASSROOM	VCT-4,5,6	PT-8	PT-6	PT-6	PT-6	PT-7	EX	PT-9 (BULKHEAD)	-	-	PT-8 AT DOOR FRAMES, TRIM, ETC
0	CLASSROOM	VCT-4,5,6	PT-8	PT-6	PT-6	PT-6	PT-7	EX	PT-9 (BULKHEAD)	-	-	PT-8 AT DOOR FRAMES, TRIM, ETC
2	CLASSROOM	EX	PT-8	PT-6	PT-7	PT-6	PT-6	EX	PT-9 (BULKHEAD)	-	-	PT-8 AT DOOR FRAMES, TRIM, ETC, B-1 AT CUBBIES, EXISTING WOOD FLOOR TO RECEIVE CLEAR COAT FINIS
14	CLASSROOM	EX	PT-8	PT-6	PT-6	PT-6	PT-7	EX	PT-9 (BULKHEAD)	- (-	PT-8 AT DOOR FRAMES, TRIM, ETC, B-1 AT CUBBIES, EXISTING WOOD FLOOR TO RECEIVE CLEAR COAT FINIS
	CLASSROOM	EX	PT-8	PT-6	PT-6	PT-6	PT-7	EX	PT-9 (BULKHEAD)	-	-	PT-8 AT DOOR FRAMES, TRIM, ETC, B-1 AT CUBBIES, EXISTING WOOD FLOOR TO RECEIVE CLEAR COAT FINI
24	CLASSROOM	EX	PT-8	PT-6	PT-6	PT-6	PT-7	EX	-	- 7	PLAM-2	PT-8 AT DOOR FRAMES, TRIM, ETC, B-1 AT CUBBIES, EXISTING WOOD FLOOR TO RECEIVE CLEAR COAT FINIS

VINYL COMPOSITE TILE: VINYL COMPOSITION TILE (FIELD COLOR)
MFR: ARMSTRONG
STYLE: STANDARD EXCELON IMPERIAL TEXTURE SIZE: 12" x 12" x 1/8" COLOR: 51803 PEARL WHITE VINYL COMPOSITION TILE (ACCENT COLOR) MFR: ARMSTRONG STYLE: STANDARD EXCELON IMPERIAL TEXTURE SIZE: 12" x 12" x 1/8" COLOR: 51866 LITTLE GREEN APPLE VINYL COMPOSITION TILE (ACCENT COLOR)
MFR: ARMSTRONG
STYLE: STANDARD EXCELON IMPERIAL TEXTURE VCT-3 SIZE: 12" x 12" x 1/8" COLOR: 51884 GREENERY VINYL COMPOSITION TILE (FIELD COLOR) MFR: ARMSTRONG STYLE: STANDARD EXCELON IMPERIAL TEXTURE SIZE: 12" x 12" x 1/8" COLOR: 51803 PEARL WHITE VINYL COMPOSITION TILE (ACCENT COLOR) MFR: ARMSTRONG STYLE: STANDARD EXCELON IMPERIAL TEXTURE SIZE: 12" x 12" x 1/8" COLOR: 51867 CANTALOUPE VINYL COMPOSITION TILE (ACCENT COLOR) MFR: ARMSTRONG STYLE: STANDARD EXCELON IMPERIAL TEXTURE SIZE: 12" x 12" x 1/8"
COLOD: 518 3 PUMPKIN ORANGE VCT-7 NOT USED VCT-8 NOT USED • VCT-9 NOT USED MFR: SHERWIN WILLIAMS COLOR: SW7044 AMAZING GRAY PT-2 (STORAGE ROOM) MFR: SHERWIN WILLIAMS COLOR: SW9171 FELTED WOOL (ACCENT)
MFR: SHERWIN WILLIAMS
COLOD: SW0890 OSAGE ORANGE NOT USED MFR: SHERWIN WILLIAMS COLOR: SW1015 SKYLINE STEEL (ACCENT) MFR: SHERWIN WILLIAMS COLOR: SW6627 EMBERGLOW (DOOR FRAMES, BASE, TRIM, EXIST. PTD. DOORS, MECH. EQUIP.) MFR: SHERWIN WILLIAMS COLOR: SW7068 GRIZZLE GRAY (CEILINGS/BULKHEADS) MFR: SHERWIN WILLIAMS COLOR: SW7757 HIGH REFLECTIVE WHITE RUBBER BASE MF: JOHNSONITE TRADITIONAL PLASTIC LAMINATE:

MFR: WILSONART STANDARD LAMINATE

COLOR: D96 SHADOW


FINISH SPECIFICATIONS

THE SCHOOL DISTRICT OF PHILADELPHIA

OFFICE OF CAPITAL PROGRAMS

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(215) 400 - 4730 | (215) 400 - 4731 (fax)
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Attn: Anil Giri

BID DOCUMENTS April 20, 2018
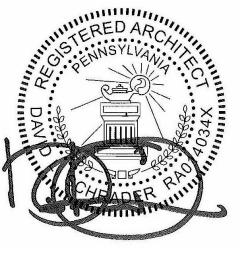
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1	5/9/18	ADDENDUM #1
NO.	DATE	REVISION

SCHOOL & LOCATION

G.W. Childs School

1599 Wharton St, Philadelphia, PA 19146

PROJECT TITLE


Classroom Modifications to G.W.


Childs School

DRAWING TITLE

FINISH SCHEDULE

LOCATION NO.	FILE	E NO.
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B-071 C B-074 C	OF OF	2017/18

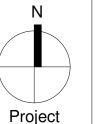

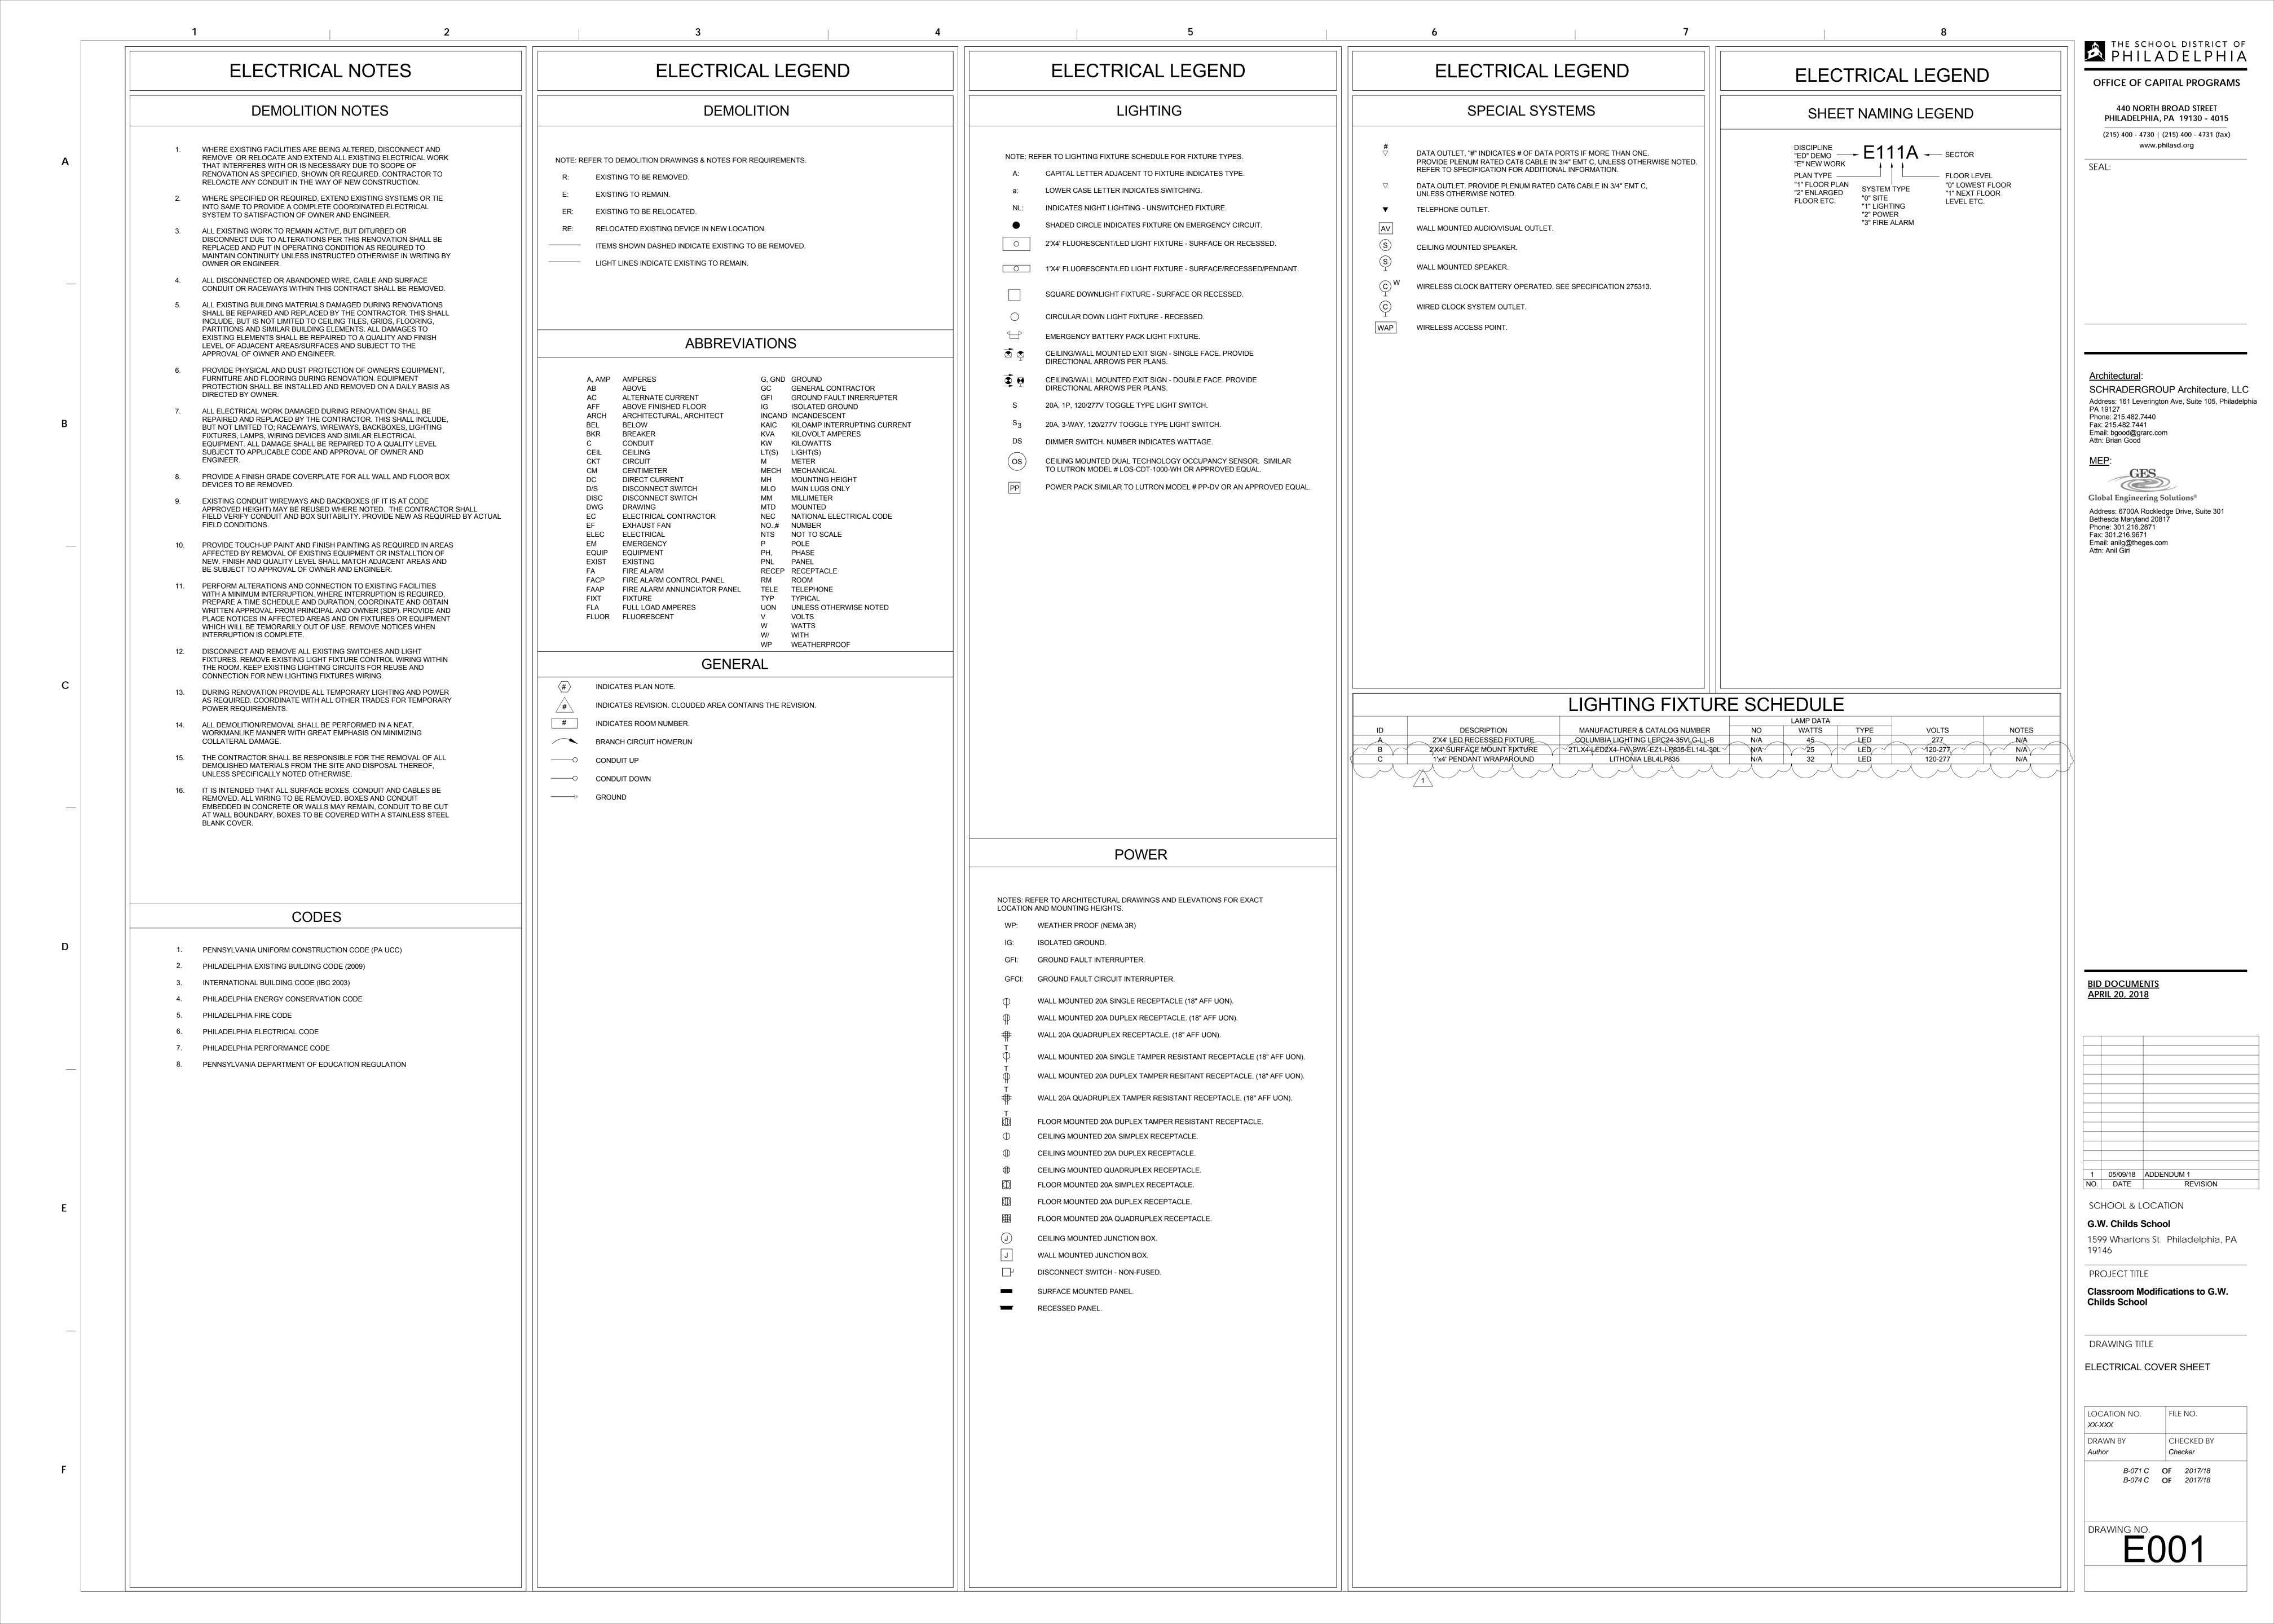



THE SCHOOL DISTRICT OF PHILADELPHIA

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1 05/09/18 ADDENDUM 1

SCHOOL & LOCATION

1599 Whartons St. Philadelphia, PA

Classroom Modifications to G.W.

BASEMENT LEVEL - ELECTRICAL FLOOR PLANS - DEMOLITION

FILE NO. CHECKED BY B-071 C OF 2017/18 B-074 C OF 2017/18


Project

KEY PLAN (NTS)


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1 05/09/18 ADDENDUM 1

SCHOOL & LOCATION


1599 Whartons St. Philadelphia, PA

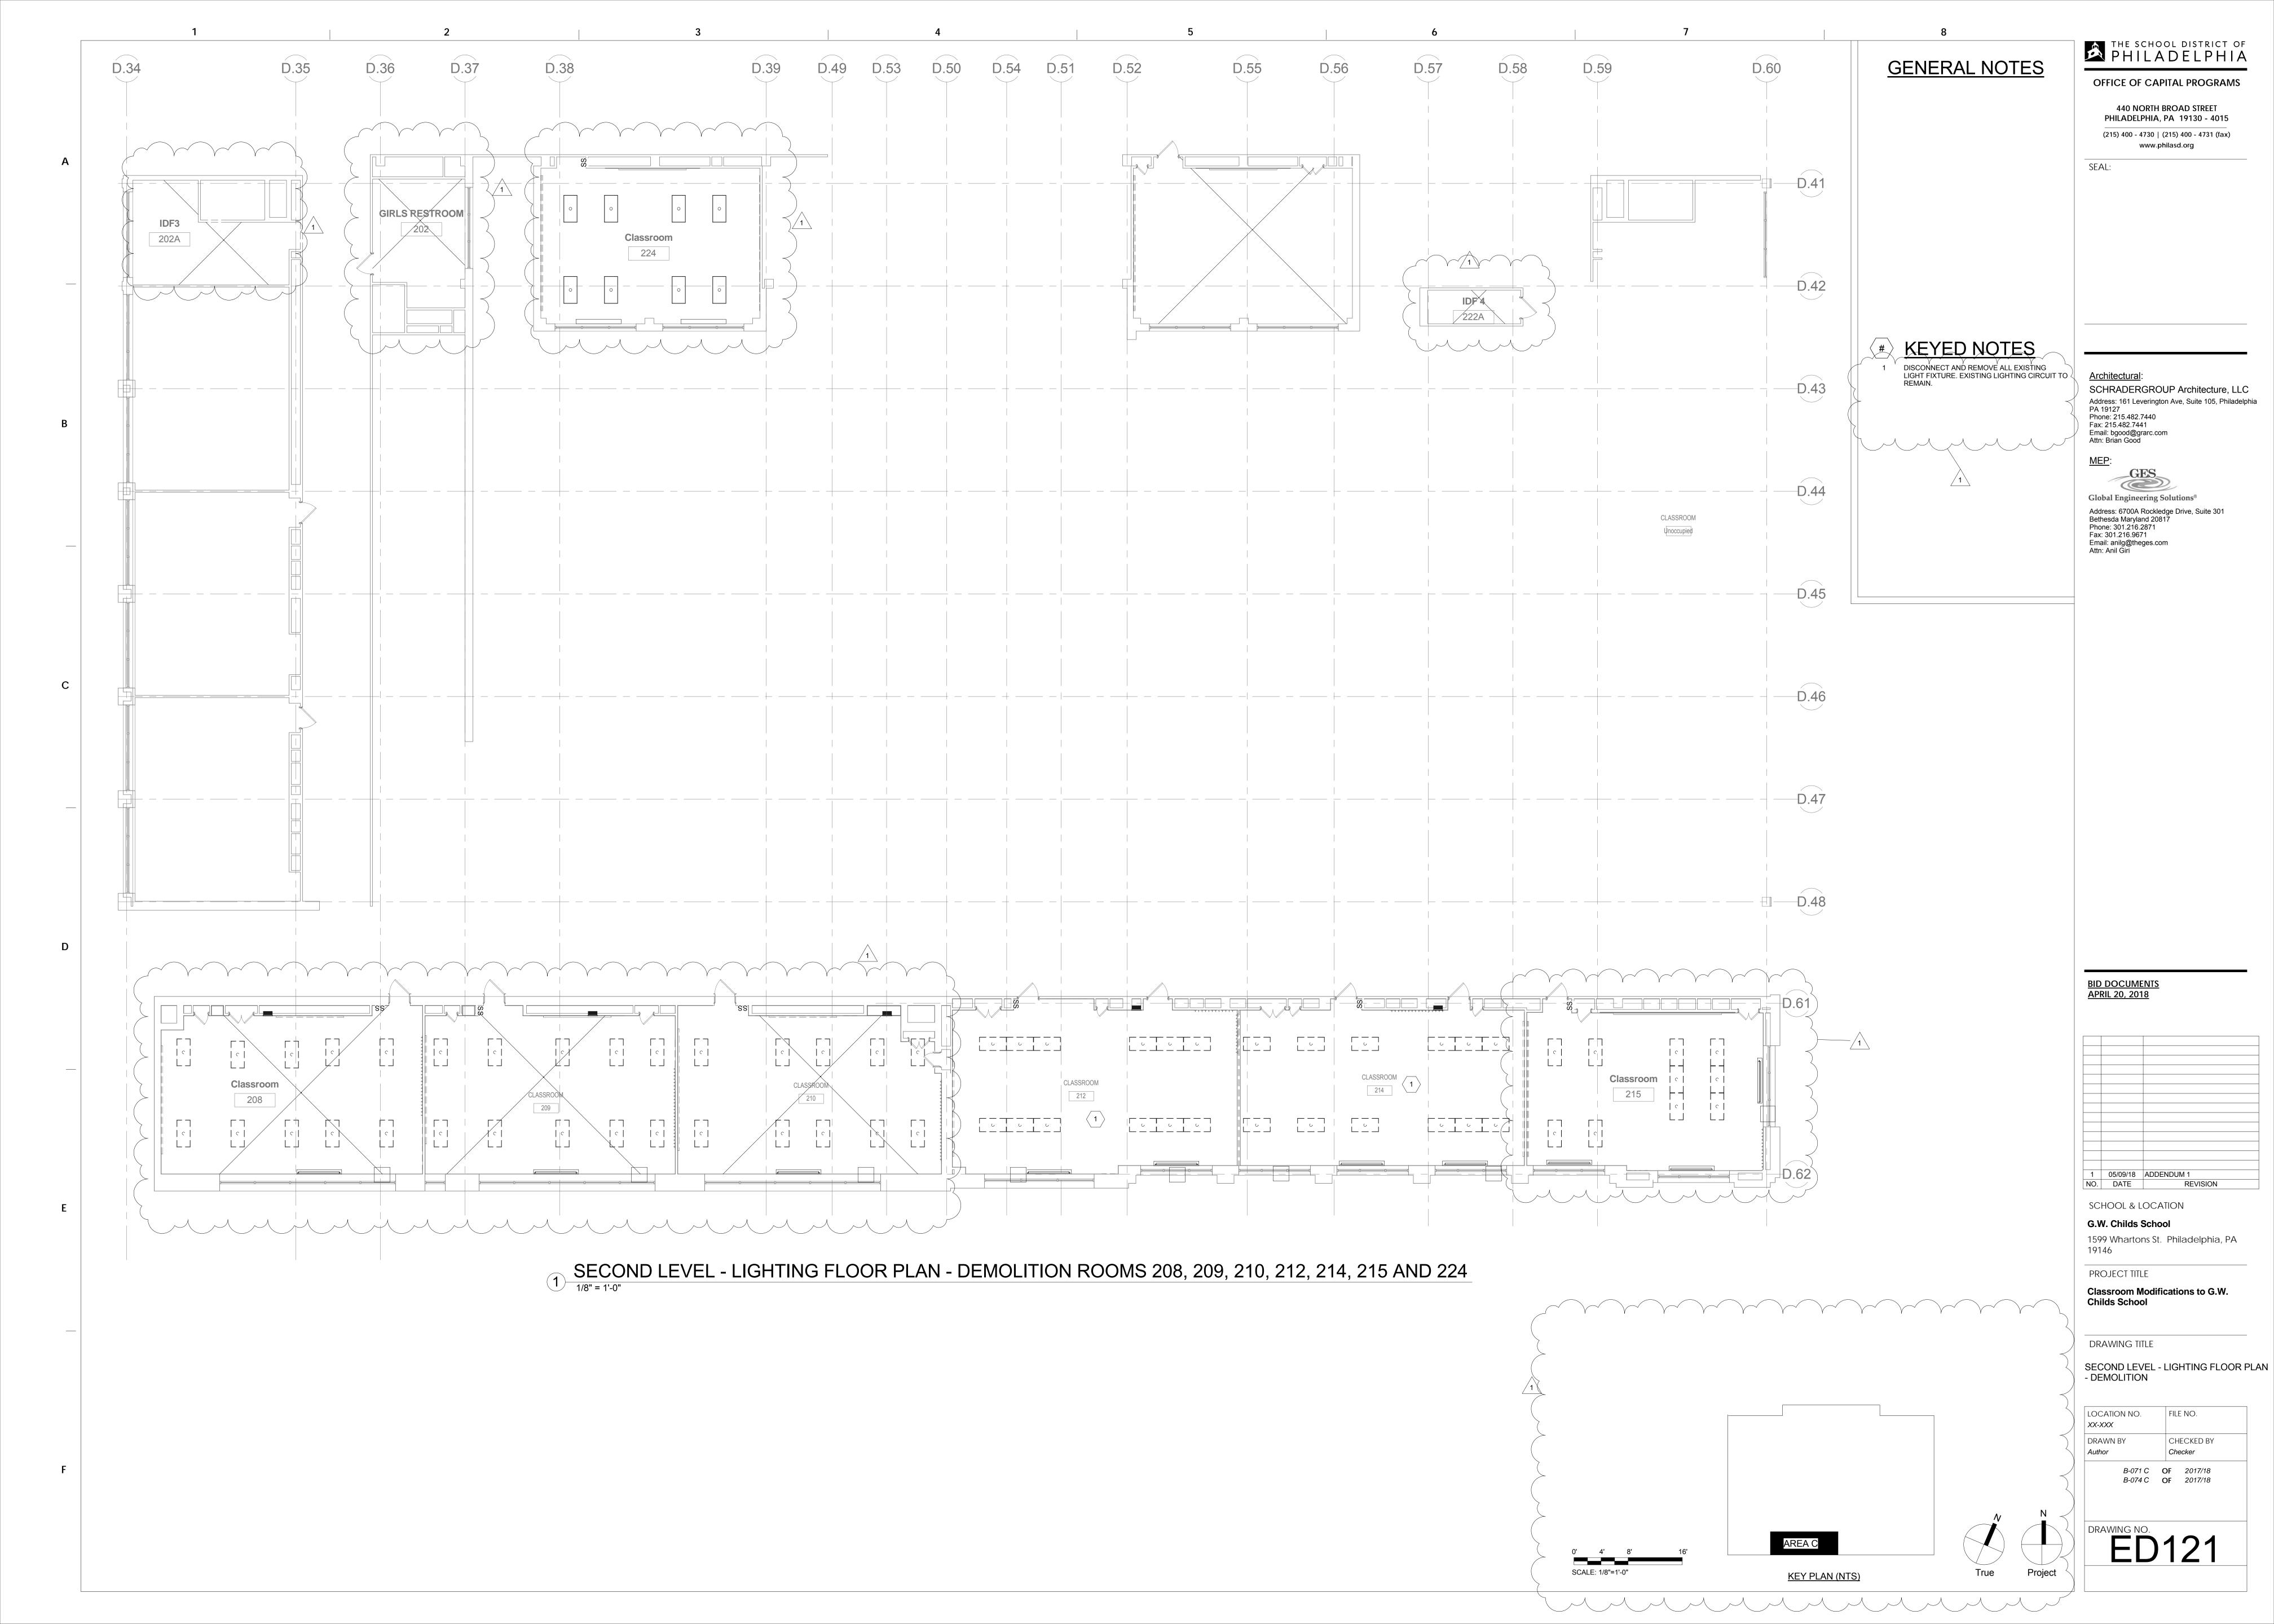
Classroom Modifications to G.W.

BASEMENT LEVEL - ELECTRICAL FLOOR PLANS - NEW WORK

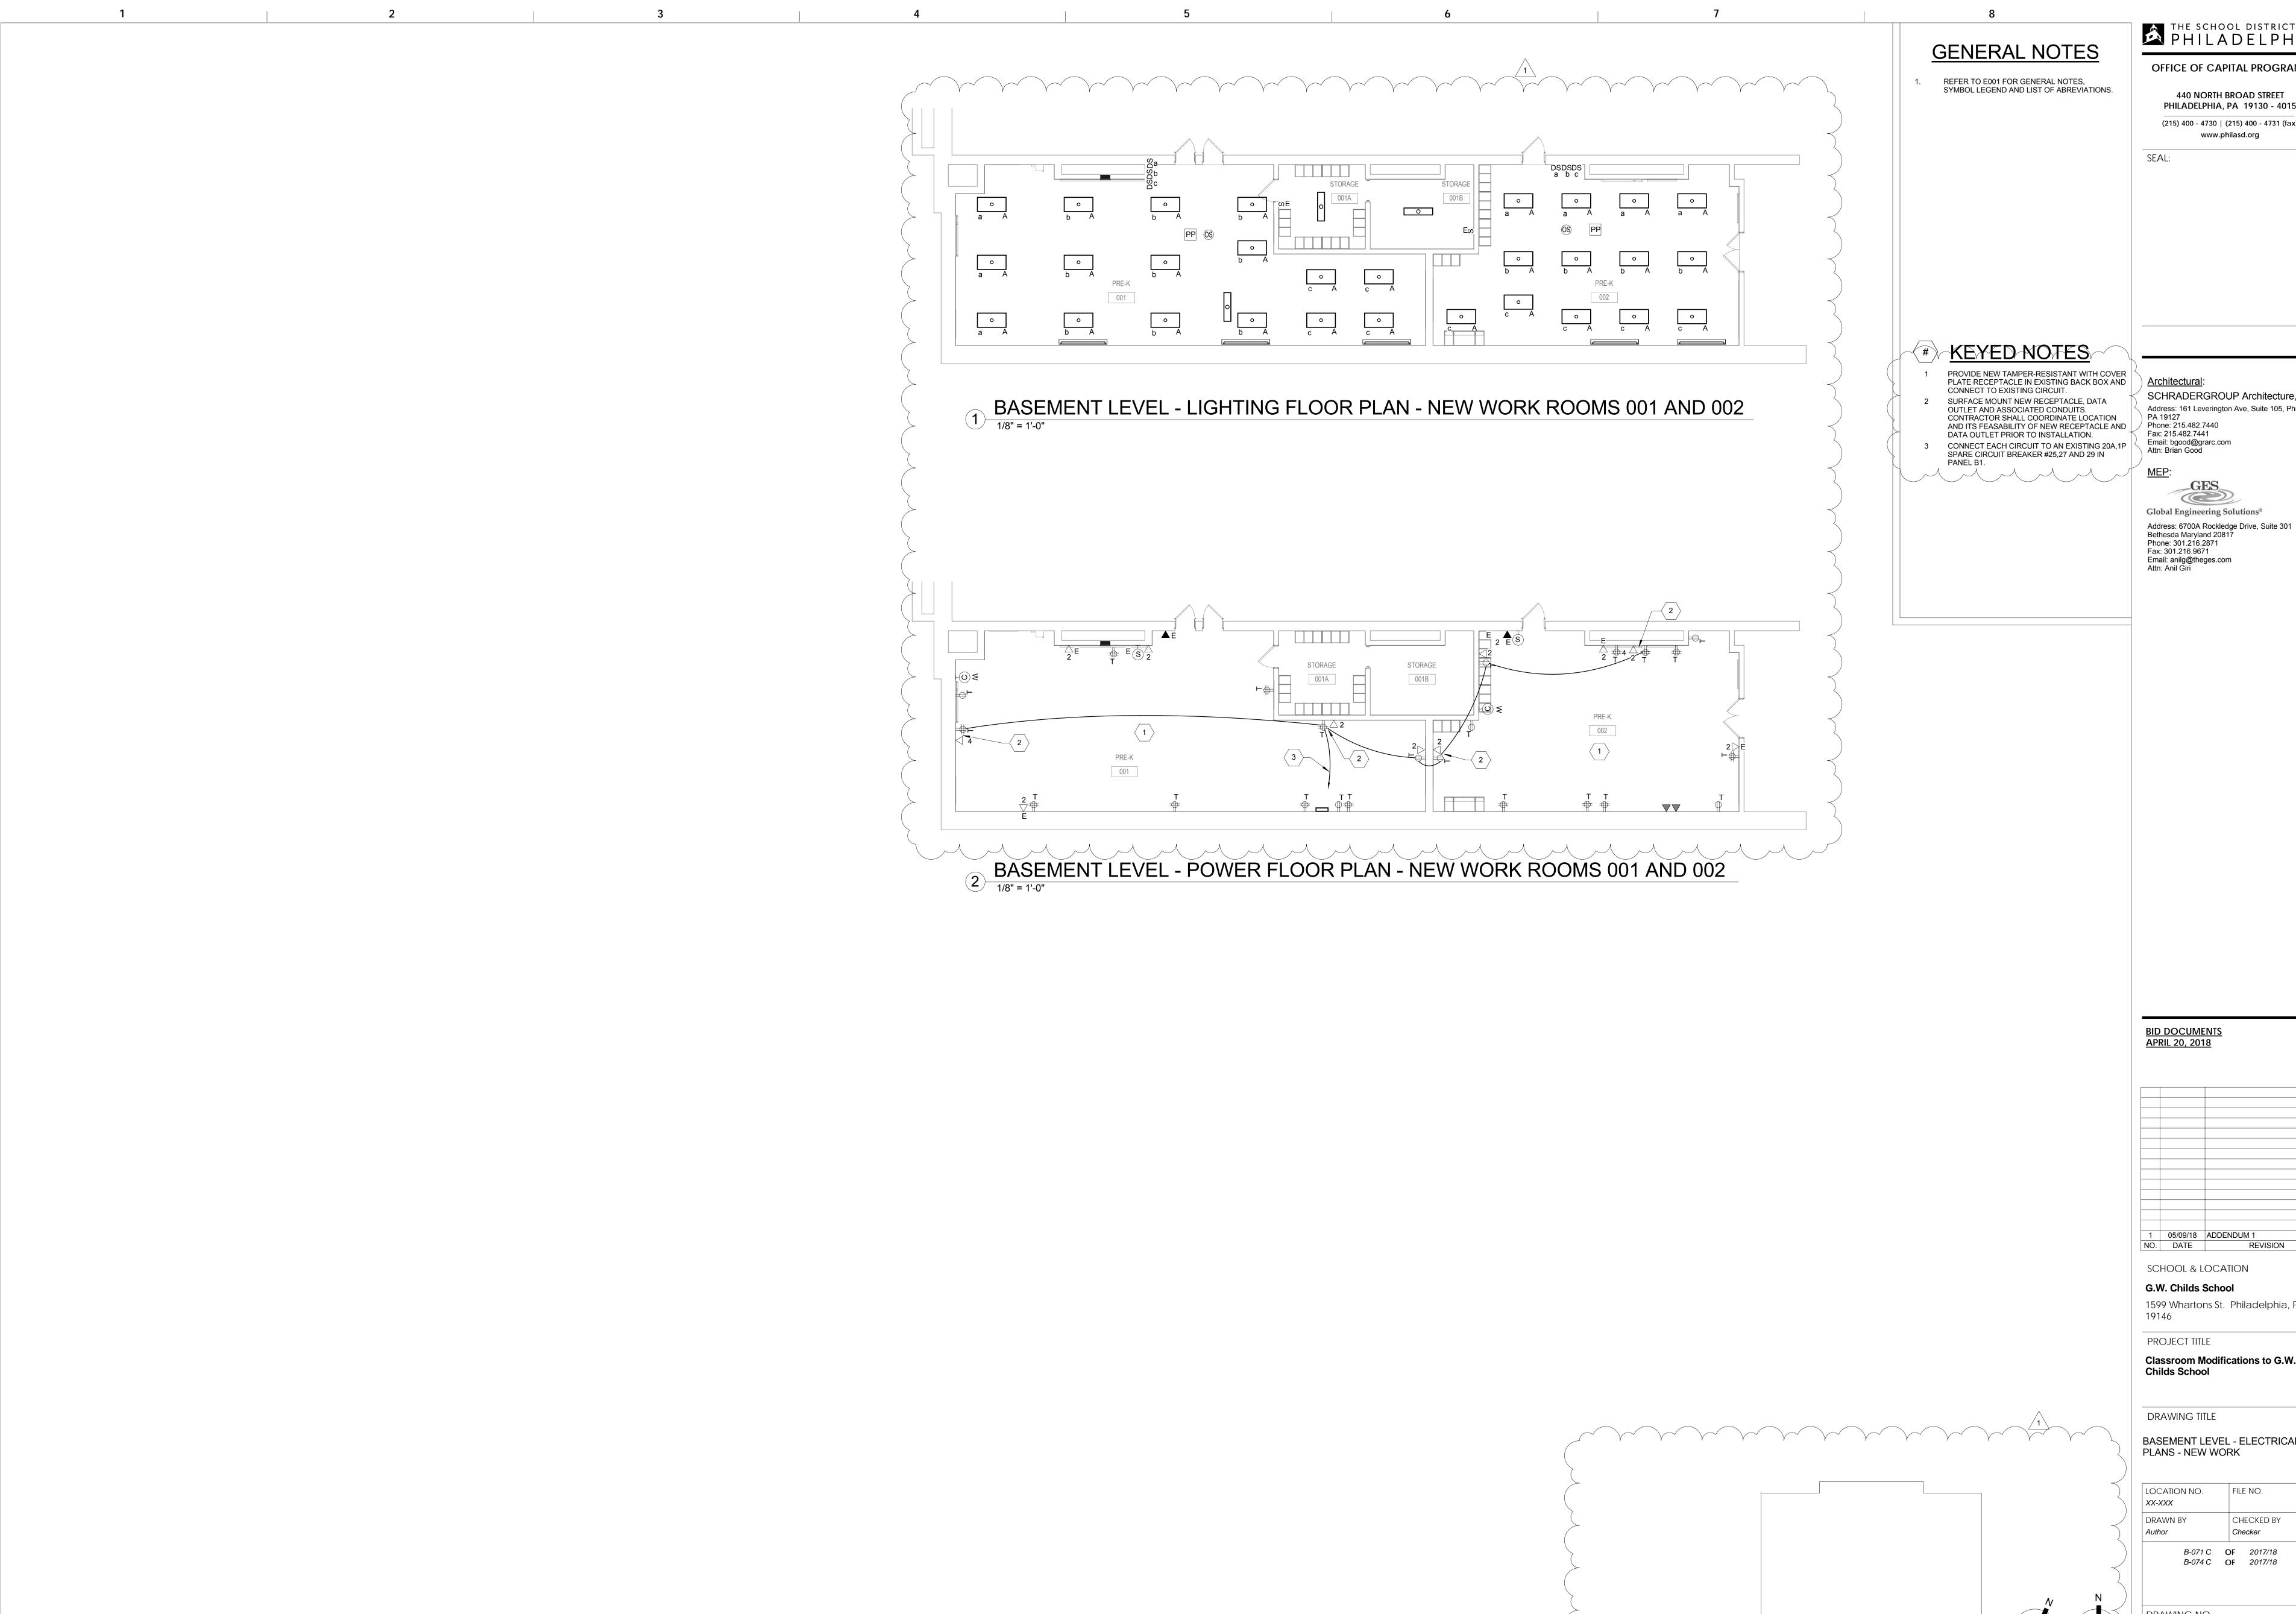FILE NO. CHECKED BY

B-071 C OF 2017/18 B-074 C OF 2017/18

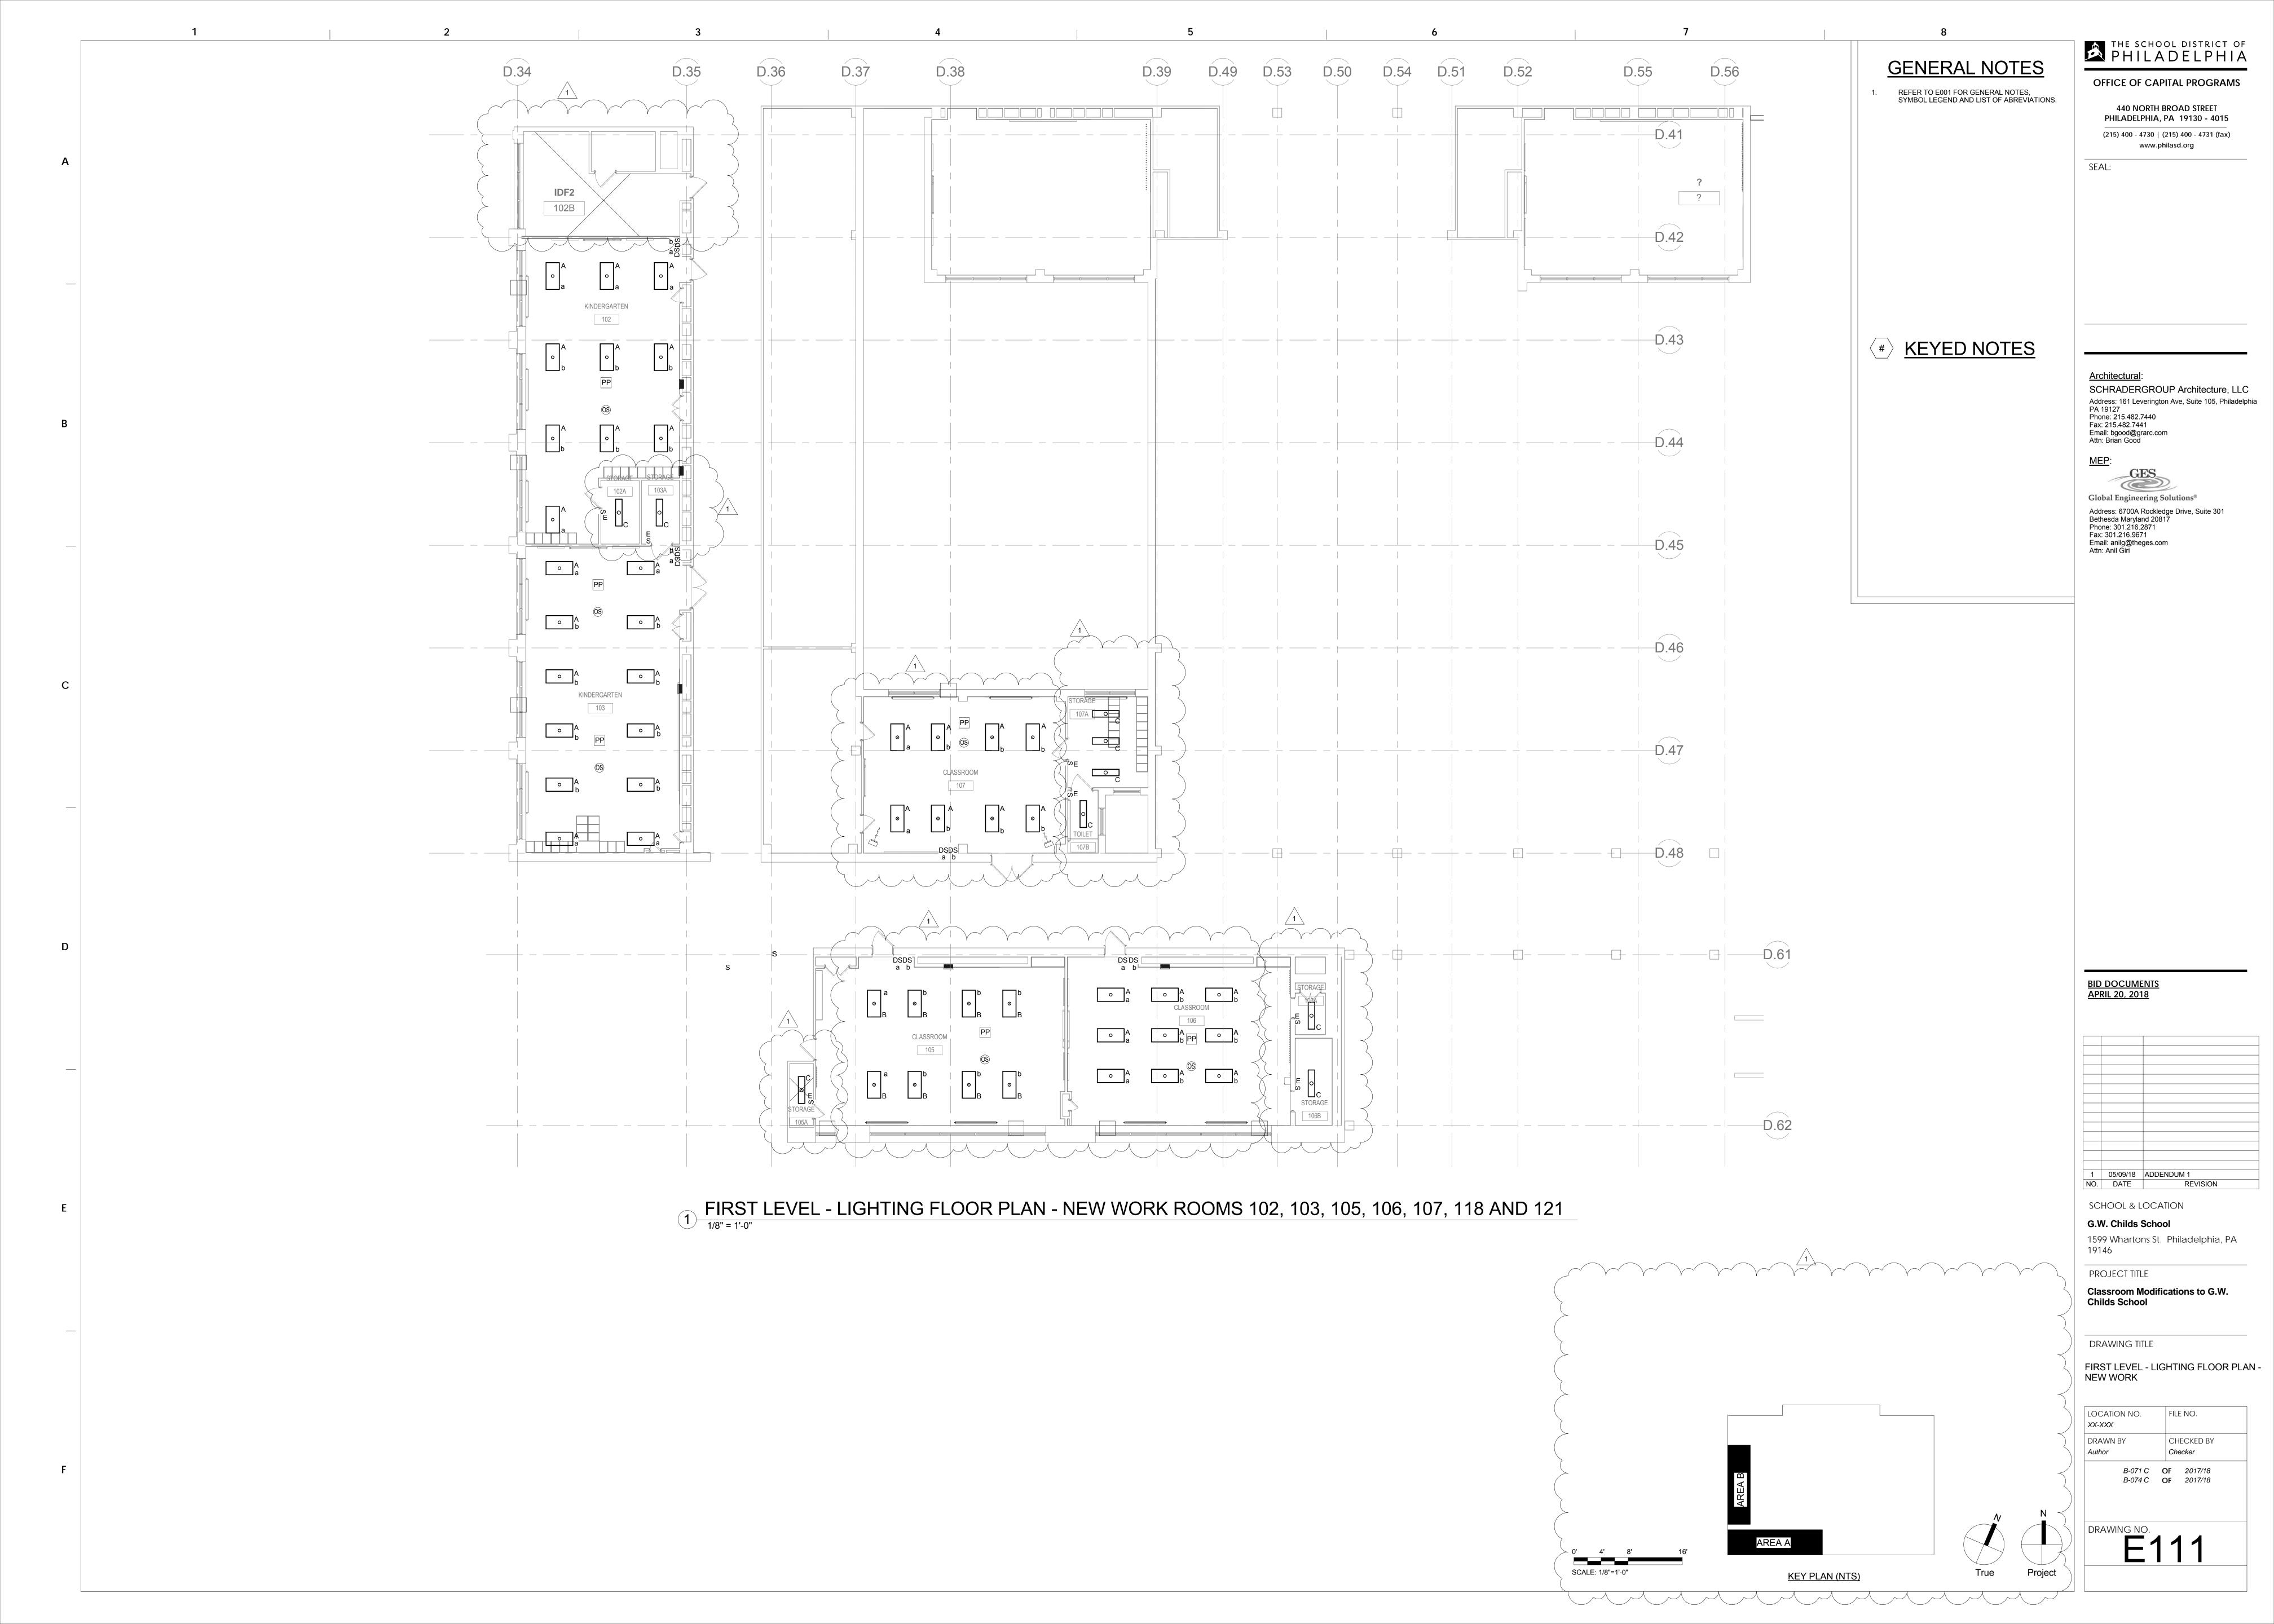

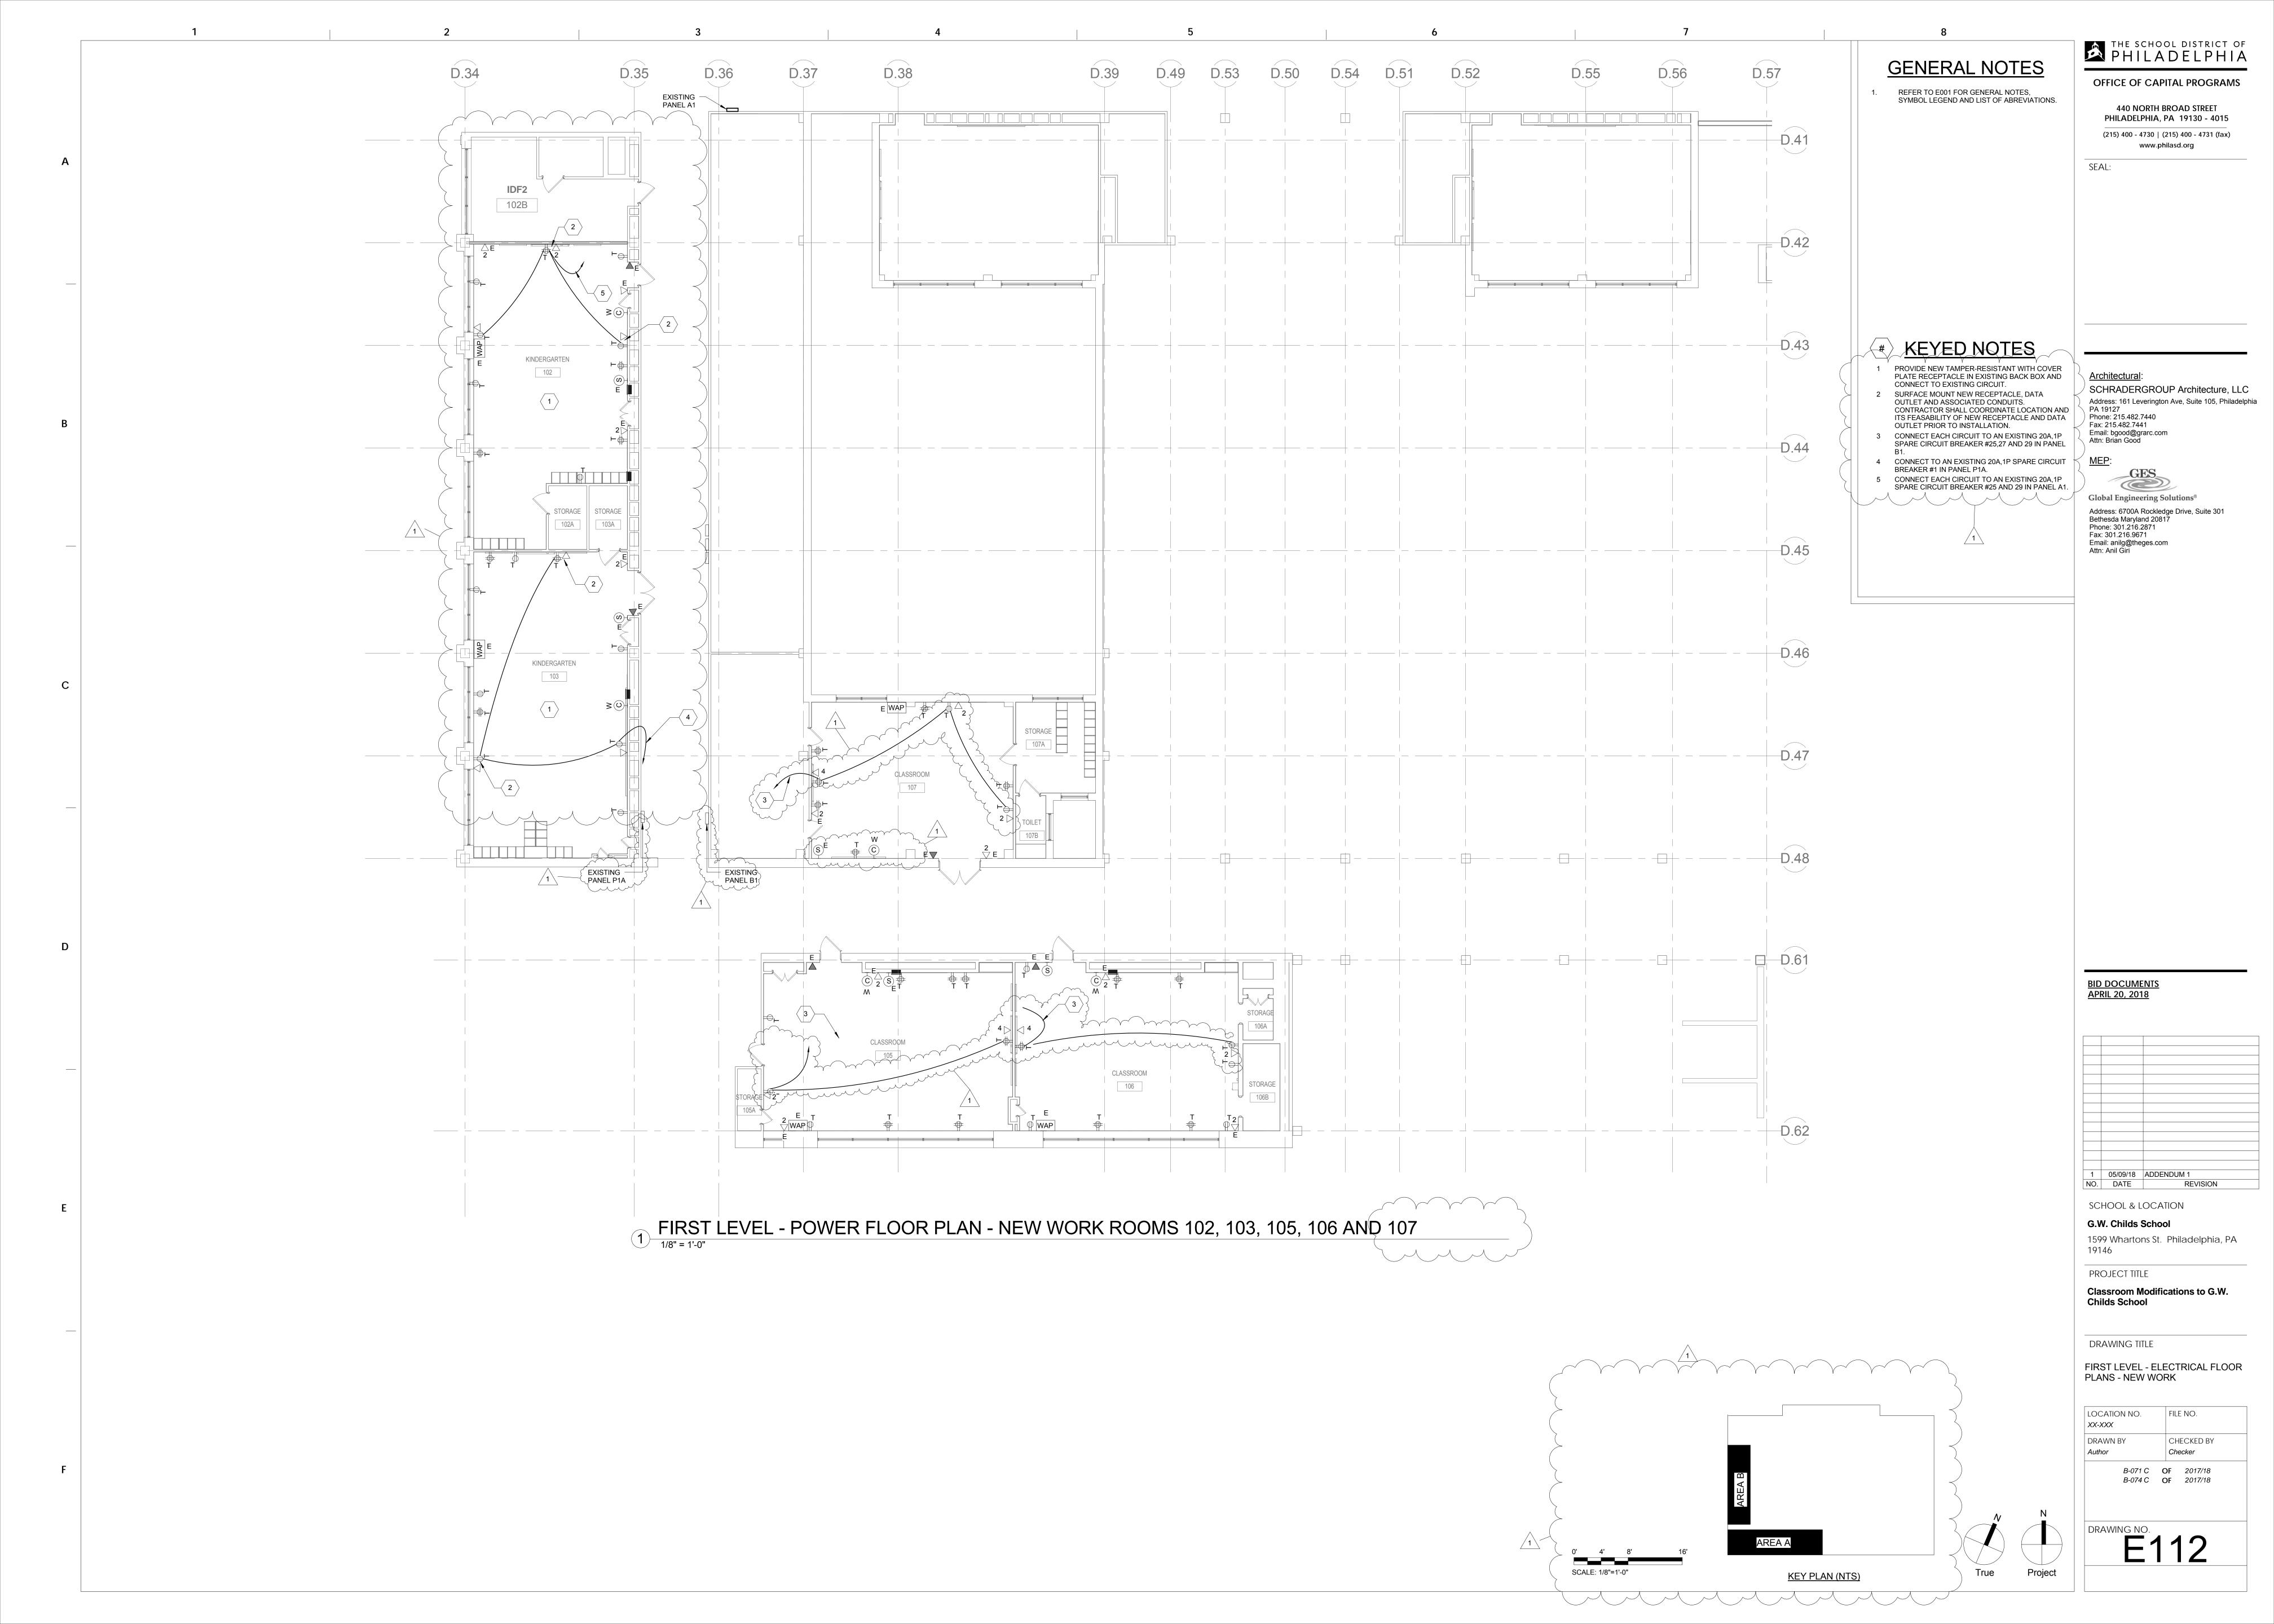





BROWN W/ WHITE GREEN BLUE W/ WHITE BLUE GREEN W/ WHITE ORANGE ORANGE W/ WHITE 1. ALL RJ45 TERMINATION POINTS SHALL BE CONFIGURED TO THE EIA/TIA 568B STANDARD UNLESS SPECIFICALLY DIRECTED OTHERWISE BY SDP AUTHORIZED REPRESENTATIVE. 4 RJ45 TERMINATION DETAIL NTS


BOX LOCATED AT CCLASSROOM CEILING (TYP.) PLENUM RATED CAT6 PLENUM RATED CAT6 IN 3/4" EMT C (TYPICAL FOR TWO DROPS) IN 2" EMT C, TERMINATE CAT6 CABLES IN NEW PATCH PANEL (TYP.) PLENUM RATED CAT6 IN 1" EMT C (TYPICAL FOR FOUR DROPS) PROVIDE NEW PATCH PANEL TO MATCH EXISTING AND COORDINATE WITH OWNER PRIOR TO INSTALLATION. EXISTING DATA TERMINATE EACH CABLE AT THE NEW PATCH PANEL RACK IN SERVER ROOM LOCATED IN ROOMS MDF 004 AND IDF ROOMS 102A, 202A, 222A NEW WIRELESS MASTER CLOCK 1. ELECTRICAL CONTRACTOR IS TO TEST EACH INDIVIDUAL DATA DROP HEADEND EQUIPMENT COORDIATE EXACT LOCATION WITH AFTER TERMINATION AND PROVIDE A REPORT OF ALL DROPS TO SDP SDP IT DEPARTEMENT -IT DEPARTMENT. SDP IT DEPARTMENT WILL BE RESPONSIBLE FOR FINAL CONNECTION AND ACTIVATION. 2. FOR EXACT NUMBER AND LOCATION OF DATA OUTLETS SEE POWER

FLOOR PLANS NEW WORK.

 FOR ALL COMMUNICATION REQUIREMENT SEE SPECIFICATION 271300 (COMMUNICATION SYSTEM).

- 4"x4"x4" JUNCTION

DATA RISER DIAGRAM

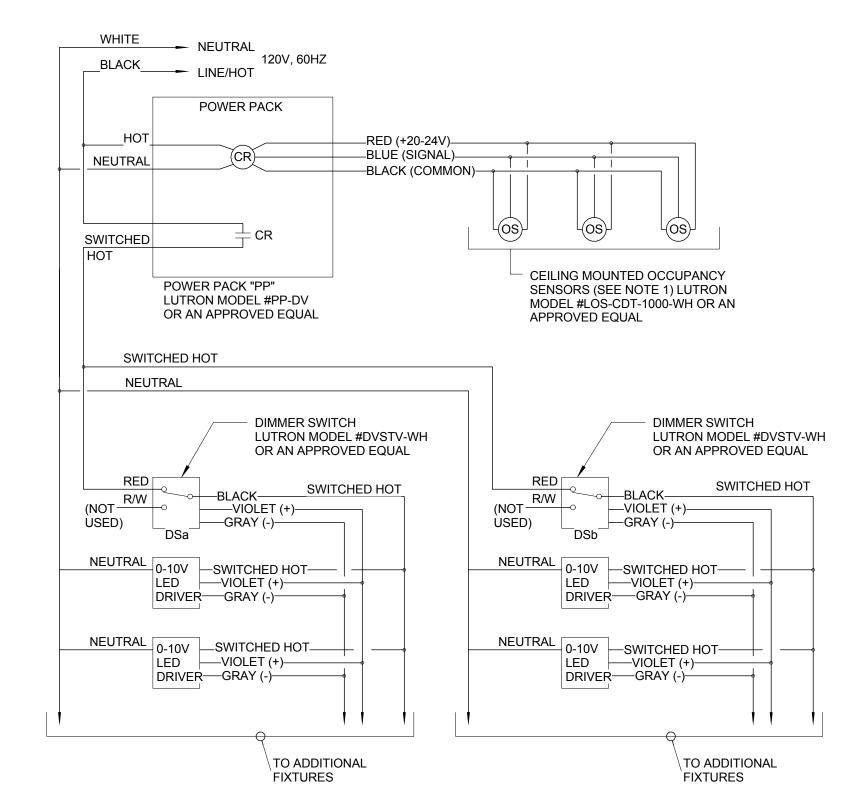

<u>NOTES</u>

- MAXIMUM COMBINATION OF THREE OCCUPANCY SENSORS AND/OR RELAY UNITS PER CONTROL UNIT.
- 2. CONTRACTOR SHALL VERIFY CONTROLS COMPATIBILITY OF ALL DEVICE AND FIXTURE WITH MANUFACTURERS PRIOR TO PURCHASE.
- 3. DIAGRAM IS SCHEMATIC AND TO SHOW DESIGN INTENT AND IT IS BASED ON LUTRON PRODUCTS; CONTRACTOR SHALL VERIFY EXACT WIRING CONFIGURATION AND REQUIREMENTS PRIOR TO CONSTRUCTION.

TYPICAL CLASSROOM LED LIGHTING CONTROL SCHEMATIC CEILING OCCUPANCY SENSOR WITH TWO

2 DIMMER SWITCHES NTS

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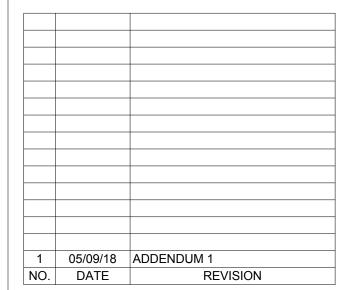
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BID DOCUMENTS APRIL 20, 2018



SCHOOL & LOCATION

G.W. Childs School1599 Whartons St. Philadelphia, PA

PROJECT TITLE

Classroom Modifications to G.W.

DRAWING TITLE

ELECTRICAL DETAILS

Childs School

19146

LOCATION NO. FILE NO.

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Author

CHECKED BY

Checker

B-071 C OF 2017/18

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ING NO

GENERAL PIPING ABBREVIATIONS GENERAL NOTES DOUBLE LINE DUCTWORK ASSOCIATED AIR BALANCE POUNDS PER HOUR **GENERAL** AUTOMATIC AIR VENT AUTOMATIC AIR VENT LOCKED ROTOR AMP 90° ELBOW, RECTANGULAR WITHOUT RECTANGULAR DUCT (FIRST FIGURE IS **DEMOLITION** LEAVING WATER TEMPERATURE . THE INTENT OF THESE DRAWINGS IS TO PROVIDE COMPLETE AND PROPERLY DIRECTION OF PIPE PITCH √ FOR SIDE SHOWN, SECOND FIGURE IS TURING VANES AIR CONDITIONING UNIT FUNCTIONING HVAC SYSTEMS. PROVIDE ALL LABOR AND MATERIAL NECESSARY TO ANY DISCOVERED DISCREPANCY BETWEEN THE CONTRACT DOCUMENTS AND ACTUAL FOR SIDE NOT SHOWN) ACOUSTICAL CEILING TILE MOTORIZED DAMPER ACHIEVE SUCH ENDS. CONTRACTOR IS OBLIGATED TO EXAMINE PLANS. ANY OBSERVED SITE CONDITIONS MAY BE BROUGHT TO THE ARCHITECT/ENGINEER'S ATTENTION PRIOR FLOOR DRAIN 45° ELBOW, RECTANGULAR ACCESS DOOR MIXED AIR FAULTS OR AMBIGUITY IN THESE PLANS SHALL BE CALLED TO THE ATTENTION OF THE TO BID FOR CLARIFICATION. AFTER A CONTRACT IS EXECUTED CONTRACTOR SHALL 300 ROUND DUCT OWNER'S REPRESENTATIVE IMMEDIATELY, SO THAT THE MATTER MAY BE RESOLVED ADDT'L ADDITIONAL MAT MIXED AIR TEMPERATURE SUBMIT A REQUEST FOR INFORMATION. FLOW DIRECTION PRIOR TO SUBMISSION OF BIDS. BY SUBMISSION OF BID, THE CONTRACTOR SHALL MAXIMUM 90° ELBOW, ROUND OR FLAT OVAL ACKNOWLEDGE ACCEPTANCE OF THESE PLANS AS AN ADEQUATE DEFINITION OF THE THE REQUIRED DEMOLITION SHALL NOT BE LIMITED TO THAT PORTION SHOWN ON THE FLAT OVAL DUCT (FIRST FIGURE IS FOR AFC ABOVE FINISHED CEILING MBH ONE THOUSAND BTUH SCOPE OF WORK AND EXTRA COST CLAIMS BASED ON INADEQUACY OF PLANS WILL MANUAL AIR VENT 300x150 ↔ 〈 SIDE SHOWN, SECOND FIGURE IS FOR (SMOOTH OR 5 PIECE ELBOWS) PLANS ALONE, BUT SHALL INCLUDE ALL NECESSARY WORK COINCIDENTAL THERETO AIR FLOW CONTROL PANEL MECHANICAL CONTRACTOR AFCP NOT BE CONSIDERED. AND/OR WORK INDICATED ELSEWHERE ON THE DRAWINGS OR IN THE SPECIFICATIONS. SIDE NOT SHOWN) ABOVE FINISHED FLOOR MOTOR CONTROL CENTER MCC AFF PIPE CONTINUES AIR FLOW MEASURING STATION MANUAL DAMPER MD 2. ALL WORK ON THIS PROJECT SHALL BE INSTALLED IN ACCORDANCE WITH THE LATEST CONTRACTOR SHALL NOT VIOLATE THE PHYSICAL SECURITY OF THE BUILDING DURING MITERED 90° ELBOW, ROUND OR FLAT OVAL FLOW DIRECTION ARROW AIR HANDLING UNIT MECH MECHANICAL APPLICABLE CODES AND REGULATIONS. DEMOLITION OR ASSOCIATED OPERATIONS. SECURITY SHALL BE CLOSELY COORDINATED BOILER FEEDWATER ------ BFW ------ALUMINUM MECHANICAL EQUIPMENT ROOM WITH THE OWNER'S REPRESENTATIVE. 3. THESE DRAWINGS ARE DIAGRAMMATIC AND INTENDED TO DEPICT THE GENERAL AMRIENT MFGR MANUFACTURER COMPRESSED AIR AMT LOCATION OF HVAC SYSTEM COMPONENTS. CONSULT THE ARCHITECTURAL PLANS FOR AMOUNT MIN MINIMUM CONTRACTOR SHALL SCHEDULE ALL WORK, INCLUDING INTERRUPTION OF EXISTING FLEX DUCT CONNECTION PROPER DIMENSIONS AND LOCATION OF EQUIPMENT. 90° ELBOW. RECTANGULAR WITH APD AIR PRESSURE DROP MUA MAKE-UP AIR UTILITIES, WITH THE OWNER, PRIOR TO STARTING WORK. CONTRACTOR SHALL NOTE CONDENSATE DRAIN TURING VANES MAKE-UP AIR UNIT ARCH **ARCHITECT** MUAU THAT THE BUILDING SHALL BE OCCUPIED AND IN USE DURING THE PERIOD OF TIME THIS 4. THE CONTRACTOR SHALL COORDINATE THE INSTALLATION OF HVAC WORK WITH CONTRACT IS BEING PERFORMED. AMERICAN REFRIGERATION EXISTING CONDITIONS AND THE WORK OF OTHER TRADES. MINOR DEVIATIONS FROM CHILLED WATER RETURN AIR SEPARATOR NOT APPLICABLE THE PLANS MAY BE MADE TO AVOID MINOR CONFLICTS. WHEN MAJOR CONFLICTS ARE 45° ELBOW, ROUND OR FLAT OVAL DEMOLITION SHALL GENERALLY BE ARRANGED TO AGREE WITH THE ACCOMPLISHMENT VOLUME DAMPER AMERICAN SOCIETY OF NORMALLY CLOSED/NOISE CRITERIA ASHRAF APPARENT, THE ARCHITECT SHALL BE ADVISED IMMEDIATELY, AND AFFECTED WORK CHILLED WATER SUPPLY OF WORK UNDER THE VARIOUS PHASES AND IN COORDINATION WITH THE REQUIRED (SMOOTH OR 3 PIECE ELBOWS) AIR CONDITIONING ENGINEERS NATIONAL ELECTRICAL CODE NEC SHALL NOT BE INSTALLED UNTIL THE CONFLICT HAS BEEN RESOLVED. MODIFICATIONS. AMERICAN SOCIETY FOR TESTING NATURAL GAS CONDENSER WATER RETURN NUMBER/NORMALLY OPEN AND MATERIALS 5. THE CONTRACTOR SHALL OBTAIN AND PAY FOR PERMITS AND ARRANGE FOR 6. DO NOT ALTER THE EXISTING SYSTEMS WHICH ARE LOCATED IN AREAS NOT IN SCOPE OF MOTORIZED DAMPER AIR TERMINAL UNIT NOT TO SCALE INSPECTIONS BY LOCAL AUTHORITIES HAVING JURISDICTION. DIVIDED FLOW FITTING WORK UNLESS SPECIFICALLY INDICATED. PROTECT EXISTING SYSTEMS WITHIN THE CONDENSER WATER SUPPLY AUTO AUTOMATIC LIMITS OF WORK WHICH ARE TO BE RETAINED. ANY DAMAGE TO THE EXISTING SYSTEMS 6. ALL NECESSARY ALLOWANCES AND PROVISIONS SHALL BE MADE BY THIS OUTSIDE AIR DUE TO CONTRACTOR NEGLIGENCE SHALL BE REPAIRED AND/OR REPLACED TO ITS CONTRACTOR FOR BEAMS, COLUMNS OR OTHER OBSTRUCTIONS OF THE BUILDING OR ORIGINAL CONDITION TO THE COMPLETE SATISFACTION OF THE OWNER, AND AT NO COST BACK DRAFT DAMPER BOILER OAF **OUTSIDE AIR FAN** TAP-IN BRANCH, RECTANGULAR THE WORK OF OTHER CONTRACTORS, WHETHER OR NOT SAME IS INDICATED. WHERE BALANCE/ING **OUTSIDE AIR LOUVER** OAL NECESSARY TO AVOID OBSTRUCTIONS THE DUCTS SHALL BE TRANSFORMED, DIVIDED, BUILDING CONTROL UNIT OPPOSED BLADE DAMPER OFFSET, RAISED OR LOWERED WITH THE REQUIRED FREE AREA BEING MAINTAINED UNLESS OTHERWISE INDICATED, ALL FIXTURES, EQUIPMENT, PIPING, AND ACCESSORIES BOILER HORSEPOWER/BRAKE ON CENTERPOWER DUAL TEMPERATURE RETURN FIRE DAMPER WHILE MAINTAINING DESIGNED CEILING HEIGHTS. WHICH HAVE TO BE REMOVED SHALL BECOME THE PROPERTY OF THE CONTRACTOR AND BOP BOTTOM OF PIPE OCC OCCUPIED BRANCH DUCT, CONICAL SHALL BE REMOVED FROM THE PROJECT SITE AS SOON AS POSSIBLE. BLDG **OVERFLOW** BUILDING 7. INSTALL ALL EQUIPMENT IN ACCORDANCE WITH THE MANUFACTURER'S LATERAL FITTING. DUAL TEMPERATURE SUPPLY BLW OPP OPPOSITE RECOMMENDATIONS. ROUND OR FLAT OVAL 8. "CONCEALED LOCATION" IS DEFINED AS BEING ABOVE FINISHED CEILING, BELOW COMBINATION FIRE/SMOKE DAMPER BOTTOM OF STEEL ORIGINAL FINISHED FLOOR, OR WITHIN FINISHED WALL OR PARTITION. SEE ARCHITECTURAL PLANS - - - FOR -FUEL OIL RETURN BRANCH DUCT, CONICAL TEE 8. MECHANICAL CONTRACTOR SHALL THOROUGHLY CLEAN HIS WORK AREA DAILY. OPERATION AND MAINTENANCE BACK PRESSURE DAMPER FOR FINISH INFORMATION. MECHANICAL CONTRACTOR SHALL ALSO REMOVE ALL TRASH AFTER WORK FITTING. ROUND BRITISH THERMAL UNIT PER HOUR BTUH FUEL OIL SUPPLY OR FLAT OVAL COMPLETION SMOKE DAMPER BRANCH DUCT, "Y" FITTING, PLUMBING CONTRACTOR CA COMBUSTION AIR PC **FUEL OIL VENT** 9. WHERE EXISTING FIELD CONDITIONS ARE DIFFERENT THAN SHOWN, THE CONTRACTOR ROUND OR FLAT CEILING AIR DIFFUSER PRESSURE DROP PD SHALL ADVISE THE ENGINEER OF DISCREPANCIES WHICH WILL AFFECT THE PROPOSED DUCT TRANSITION, ROUND OR PRESSURE DIFFERENTIAL CONTROL COMBUSTION AIR LOUVER PDCV - - - HPR - - - -HIGH PRESSURE CONDENSATE RETURN WORK PRIOR TO BEGINNING WORK. FLAT OVAL TO RECTANGULAR CAP CAPACITY 90° ELBOW TURNED UP, CONSTANT AIR VOLUME PRESSURE REDUCING VALVE CAV PRV 10. SYMBOLS SHOWN ON SCHEDULES DEFINE TYPE OF EQUIPMENT ONLY, CONTRACTOR IS HIGH PRESSURE STEAM SUPPLY DUCT TRANSITION. RECTANGULAR [SUPPLY] CC COOLING COIL POUNDS PER HOUR RESPONSIBLE FOR RESEARCHING DRAWINGS FOR EXACT QUANTITIES REQUIRED OF RECTANGULAR TO ROUND 90° ELBOW TURNED DOWN, CENTRIFUGAL FAN **PRESS** PRESSURE - — — - HWR-OR FLAT OVAL HOT WATER RETURN RECTANGULAR [SUPPLY] CUBIC FEET PER MINUTE POUNDS PER SQUARE INCH DUCT TRANSITION, 11. PRIOR TO INSTALLATION OF NEW WORK, CONTRACTOR SHALL VERIFY THAT ALL POUNDS PER SQUARE INCH GAUGE CLG CEILING HOT WATER SUPPLY RECTANGULAR, ROUND, OR DUCTWORK, EQUIPMENT, PIPING, ETC., SHALL BE FREE FROM INTERFERENCE WITH 90° ELBOW TURNED UP. CO CLEAN OUT PVC POLYVINYL CHLORIDE FLAT OVAL EXISTING CONDITIONS. WHERE CONFLICTS OCCUR, CONTRACTOR SHALL IMMEDIATELY RECTANGULAR RETURN CONC CONCRETE – – – LPR – – – CONTACT THE OWNER. WHERE THE WORK OF VARIOUS TRADES WILL BE INSTALLED IN LOW PRESSURE CONDENSATE RETURN INCLINED RISE W/RESPECT TO COND CONDITIONING QTY QUANTITY **¼** | R→ CLOSE PROXIMITY TO ONE ANOTHER. OR WHERE THERE IS EVIDENCE THAT THE WORK 90° ELBOW TURNED DOWN, AIR FLOW, RECTANGULAR CONN CONNECT/CONNECTION OF ONE TRADE WILL INTERFERE WITH WORK OF OTHER TRADES, THE CONTRACTOR RECTANGULAR RETURN CONT CONTINUATION RETURN AIR LOW PRESSURE STEAM SUPPLY SHALL ASSIST IN WORKING OUT SPACE CONDITIONS TO MAKE A SATISFACTORY RETURN AIR GRILLE CIRCULATING PUMP ADJUSTMENT. IF THE CONTRACTOR ALLOWS ONE TRADE TO INSTALL HIS WORK BEFORE INCLINED DROP W/ RESPECT 90° ELBOW TURNED UP, - - - - MPR - - -MEDIUM PRESSURE CONDENSATE RETURN CEILING SUPPLY REGISTER RETURN AIR REGISTER CSR COORDINATING WITH WORK OF OTHER TRADES. THE CONTRACTOR SHALL MAKE TO AIR FLOW, RECTANGULAR RECTANGULAR EXHAUST CONDENSING UNIT MEDIUM PRESSURE STEAM SUPPLY CONTROL VALVE REGISTER INCLINED RISE W/RESPECT TO AIR 90° ELBOW TURNED DOWN, 12. ALL WORK TO BE GUARANTEED FOR TWO YEAR AGAINST LABOR AND MATERIALS. ANY COLD WATER RETURN/RELIEF FAN RECTANGULAR EXHAUST DEFECTIVE MATERIALS OR WORKMANSHIP, AS WELL AS DAMAGE TO THE WORK OF ALL - - - - PCR - - - -PUMPED CONDENSATE RETURN RATED LOAD AMP TRADES RESULTING FROM SAME, SHALL BE REPLACED OR REPAIRED AS DIRECTED 90° ELBOW TURNED UP ROUND, FLAT OVAL INCLINED DROP W/RESPECT TO AIR FLOW, RETURN LINEAR AIR DIFFUSER DRY BULB RLAD) -- D)| FOR THE DURATION OF THE GUARANTEE PERIOD. TIME FOR THIS GUARANTEE SHALL SIMILAR SUPPLY / RETURN / EXHAUST ROUND OR FLAT OVAL ----RL----REFRIGERANT LIQUID DECIBEL BEGIN FROM THE DATE OF ACCEPTANCE OF THE COMPLETE WORK BY THE OWNER OR 90° ELBOW TURNED DOWN ROUND, FLAT DIRECT DIGITAL CONTROL REVOLUTIONS PER MINUTE DDC RPM HIS APPOINTED REPRESENTATIVE. NOTE: THESE GUARANTEES SHALL BE SUBMITTED OVAL SIMILAR SUPPLY / RETURN / EXHAUST REFRIGERANT SUCTION PRESSURE DROP TO THE TENANT AND/OR BUILDING OWNER FOR RECORD PURPOSES. STATIC PRESSURE SENSOR DIA DIAMETER SUPPLY AIR 13. AS USED IN DRAWINGS AND SPECIFICATIONS FOR MECHANICAL WORK, CERTAIN NON-SUPPLY AIR GRILLE DIFFERENCE CEILING DIFFUSER (CD) OR GRILLE DISC SW DISCONNECT SWITCH SANITARY TECHNICAL WORDS SHALL BE UNDERSTOOD TO HAVE SPECIFIC MEANINGS AS FOLLOWS REGARDLESS OF INDICATIONS TO THE CONTRARY IN THE GENERAL HUMIDIFIER SUPPLY AIR REGISTER CONDITION OR OTHER DOCUMENTS GOVERNING THE MECHANICAL WORK. DEW POINT SHADING COEFFICIENT CEILING REGISTER (CR) OR GRILLE DETAIL SMOKE DAMPER/SPLITTER DAMPER (CG) [RETURN OR EXHAUST] "FURNISH" - PURCHASE AND DELIVER TO THE PROJECT SITE COMPLETE WITH EVERY SOUND DIGITAL CONTROLLER SDC DRAWING NECESSARY APPURTENANCE AND SUPPORT, ALL AS PART OF THE MECHANICAL WORK. ACCESS DOOR IN DUCT DX DIRECT EXPANSION SEER SEASONAL ENERGY EFFICIENCY PURCHASING SHALL INCLUDE PAYMENT OF ALL SALES TAXES AND OTHER CEILING DIFFUSER (ARROWS INDICATE SUPPLY FAN SURCHARGES AS MAY BE REQUIRED TO ASSURE THAT PURCHASED ITEMS ARE FREE THROW DIRECTIONS) EΑ EXHAUST AIR/EACH OF ALL LIENS, CLAIMS OR ENCUMBRANCES. EAL EXHAUST AIR LOUVER SLOT LINEAR AIR DIFFUSER CEILING DIFFUSER (ARROWS INDICATE EXHAUST AIR REGISTER SHEET METAL AND AIR "INSTALL" - UNLOAD AT THE DELIVERY POINT AT THE SITE AND PERFORM EVERY SMACNA THROW DIRECTIONS) ENTERING AIR TEMPERATURE SCREENED OPENING OPERATION NECESSARY TO ESTABLISH SECURE MOUNTING AND CORRECT OPERATION AT THE PROPER LOCATION IN THE PROJECT, ALL AS PART OF THE MECHANICAL WORK. ELECTRICAL CONTRACTOR STATIC PRESSURE **ECONOMIZER** SPECIFICATION PIPE FITTINGS/VALVES **ECON SYMBOLS ACCESSORIES** "PROVIDE" - "FURNISH" AND "INSTALL". **ENERGY EFFICIENCY RATIO** SQUARE FEET EXHAUST FAN SQUARE INCHES "NEW" - MANUFACTURED WITHIN THE PAST TWO YEARS AND NEVER BEFORE USED. STEAM RELIEF VENT FFF **EFFICIENCY** SRV **ELEVATION** STAINLESS STEEL ELEV BDD BACKDRAFT DAMPER 14. ALL MATERIAL, EQUIPMENT AND ACCESSORIES, FURNISHED AND INSTALLED SHALL BE EXISTING TO REMAIN FLANGE CONNECTION ELL **ELBOW** STL STEEL NEW AND EQUAL TO OR SURPASS THE QUALITY OF SIMILAR MATERIALS AS **ENTERING** STN SECTION VOLUME DAMPER SCHEDULES. ALL MATERIALS, EQUIPMENT AND METHODS SHALL BE AS SPECIFIED IN FLEXIBLE CONNECTOR EXISTING TO BE REMOVED EQUIP **EQUIPMENT** SUSP SUSPENSION THE BASE BUILDING CONTRACT DOCUMENTS UNLESS NOTED OTHERWISE. EQUIV EQUIVALENT SWR SIDE WALL REGISTER PIPE CONNECTION - BOTTOM FIRE DAMPER ESP EXTERNAL STATIC PRESSURE SYMBOL **NEW WORK** EST ESTIMATED ELECTRIC WALL HEATER THERMOSTAT PIPE CONNECTION - TOP FIRE/SMOKE DAMPER POINT OF CONNECTION NEW EWT ENTERING WATER TCC TEMPERATURE CONTROLIPERATURE TO EXISTING **EXHAUST** TEMPERATURE DIFFERENCE PIPE DOWN SMOKE DAMPER **EXIST** EXISTING TEMP TEMPERATURE TRANSFER GRILLE LIMIT OF DEMOLITION PIPE END CAP MOTORIZED DAMPER MOTORIZED DEGREES FAHRENHEIT TOS TOP OF STEEL FLEXIBLE CONNECTION PIPE REDUCER - CONCENTRIC (CO2) CARBON DIOXIDE SENSOR (MOUNT 48" AFF) FIRE DAMPER TSP TOTAL STATIC PRESSURE FFE FINISHED FLOOR ELEVATION TURNING VANE PIPE REDUCER - ECCENTRIC FLA FULL LOAD AMP THERMAL EXPANSION VALVE (CO) CARBON MONOXIDE SENSOR FLEX FLEXIBLE TYPICAL PIPE UP FLG FLANGE UNION CONNECTION FLR FLOOR UNDERCUT (H) HUMIDISTAT (MOUNT 48" AFF) FM FACTORY MUTUAL UNDERGROUND FPM UNDERWRITERS LABORATORY FEET PER MINUTE BALL VALVE (T) THERMOSTAT (MOUNT 48" AFF) **EQUIPMENT** UNOCC UNOCCUPIED FT WG FEET OF WATER GAUGE **BUTTERFLY VALVE** <ŚĎ> SMOKE DETECTOR GΑ VARIABLE AIR VOLUME GAUGE CHECK VALVE **VOLUME DAMPER** GAL GALLONS VAV TERMINAL UNIT WITH REHEAT COIL GENERAL CONTRACTOR VANED RETURN REGISTER VDR DETAIL DETAIL GLOBE VALVE GPM GALLONS PER MINUTE VFD VARIABLE FREQUENCY DRIVE VAV TERMINAL UNIT - COOLING ONLY VOL VOLUME SHUT-OFF VALVE VTR VENT THROUGH ROOF FPT TERMINAL UNIT WITH REHEAT HEAD HD PRESSURE REDUCING VALVE HORSEPOWER ELECTRICAL VAV TERMINAL UNIT HEATING, VENTILATION & AIR **HVAC** (WITH ANNOTATOR OPTIONAL) SECTION HZ WET BULB WB RELIEF VALVE WATER GAUGE SUPPLY DIFFUSER WATER PRESSURE DROP WPD INCHES INSULATE/INSULATION WITHOUT W/O SOLENOID VALVE INCHES WATER GAUGE RETURN GRILLE IWG KILOWATT EXHAUST REGISTER VALVE IN RISER SHEET NUMBERING LEGEND LEAVING AIR TEMPERATURE Y STRAINER LB LBG LINEAR BAR GRILLE Y STRAINER (WITH VALVE) - M111A - SECTOR "MD" DEMO "M" NEW WORK 2-WAY AUTOMATIC CONTROL VALVE FLOOR LEVEL PLAN TYPE "0" LOWEST FLOOR "1" FLOOR PLAN 3-WAY AUTOMATIC CONTROL VALVE "1" NEXT FLOOR "2" FNI ARGED LEVEL ETC. FLOOR ETC. PRESSURE GAUGE WITH GAUGE COCK SYSTEM TYPE "1" FOR DUCT THERMOMETER "2" FOR PIPING MOISTURE SEPARATOR


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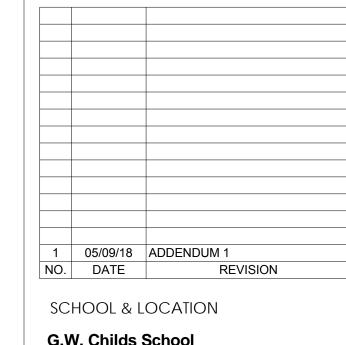
Attn: Anil Giri

Attn: Brian Good

Global Engineering Solutions® Address: 6700A Rockledge Drive, Suite 301

BID DOCUMENTS

APRIL 20, 20108

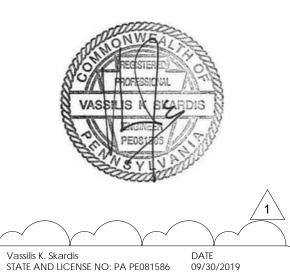

G.W. Childs School 1599 Whartons St. Philadelphia, PA

19146 PROJECT TITLE

Classroom Modifications to G.W. Childs School

DRAWING TITLE


MECHANICAL COVER SHEET

FILE NO. LOCATION NO. XX-XXX DRAWN BY CHECKED BY

> B-071 C OF 2017/18 *B-074* C **OF** 2017/18

THE SCHOOL DISTRICT OF PHILADELPHIA **GENERAL NOTES** OFFICE OF CAPITAL PROGRAMS REFER TO M001 FOR GENERAL NOTES, SYMBOL LEGEND AND LIST OF ABBREVIATIONS. 440 NORTH BROAD STREET PHILADELPHIA, PA 19130 - 4015 (215) 400 - 4730 | (215) 400 - 4731 (fax) www.philasd.org SEAL: Vassilis K. Skardis DATE
STATE AND LICENSE NO: PA PE081586 09/30/2019 # KEYED NOTES EXISTING STEAM RADIATOR WITH COVER TO BE REFURBISHED. 2 DEMOLISH SUPPLY AIR GRILLE. SCHRADERGROUP Architecture, LLC Address: 161 Leverington Ave, Suite 105, Philadelphia PA 19127
Phone: 215.482.7440
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Phone: 301.216.2871
Fax: 301.216.9671
Email: anilg@theges.com
Attn: Anil Giri 001 BID DOCUMENTS APRIL 20, 20108 BASEMENT LEVEL - MECHANICAL FLOOR PLAN - DEMOLITION

1/8" = 1'-0" 1 05/09/18 ADDENDUM 1 NO. DATE RE SCHOOL & LOCATION G.W. Childs School 1599 Whartons St. Philadelphia, PA PROJECT TITLE Classroom Modifications to G.W. Childs School DRAWING TITLE

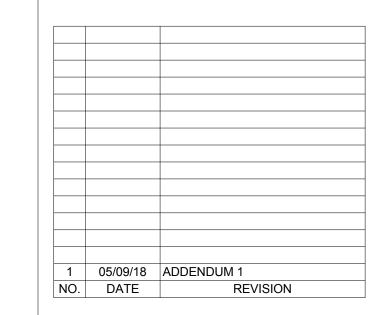


BASEMENT - MECHANICAL FLOOR PLAN - DEMOLITION

LOCATION NO. XX-XXX	FILE NO.
DRAWN BY Author	CHECKED BY Checker
	OF 2017/18 OF 2017/18

0' 4' 8' SCALE: 1/8"=1'-0"

KEY PLAN (NTS)

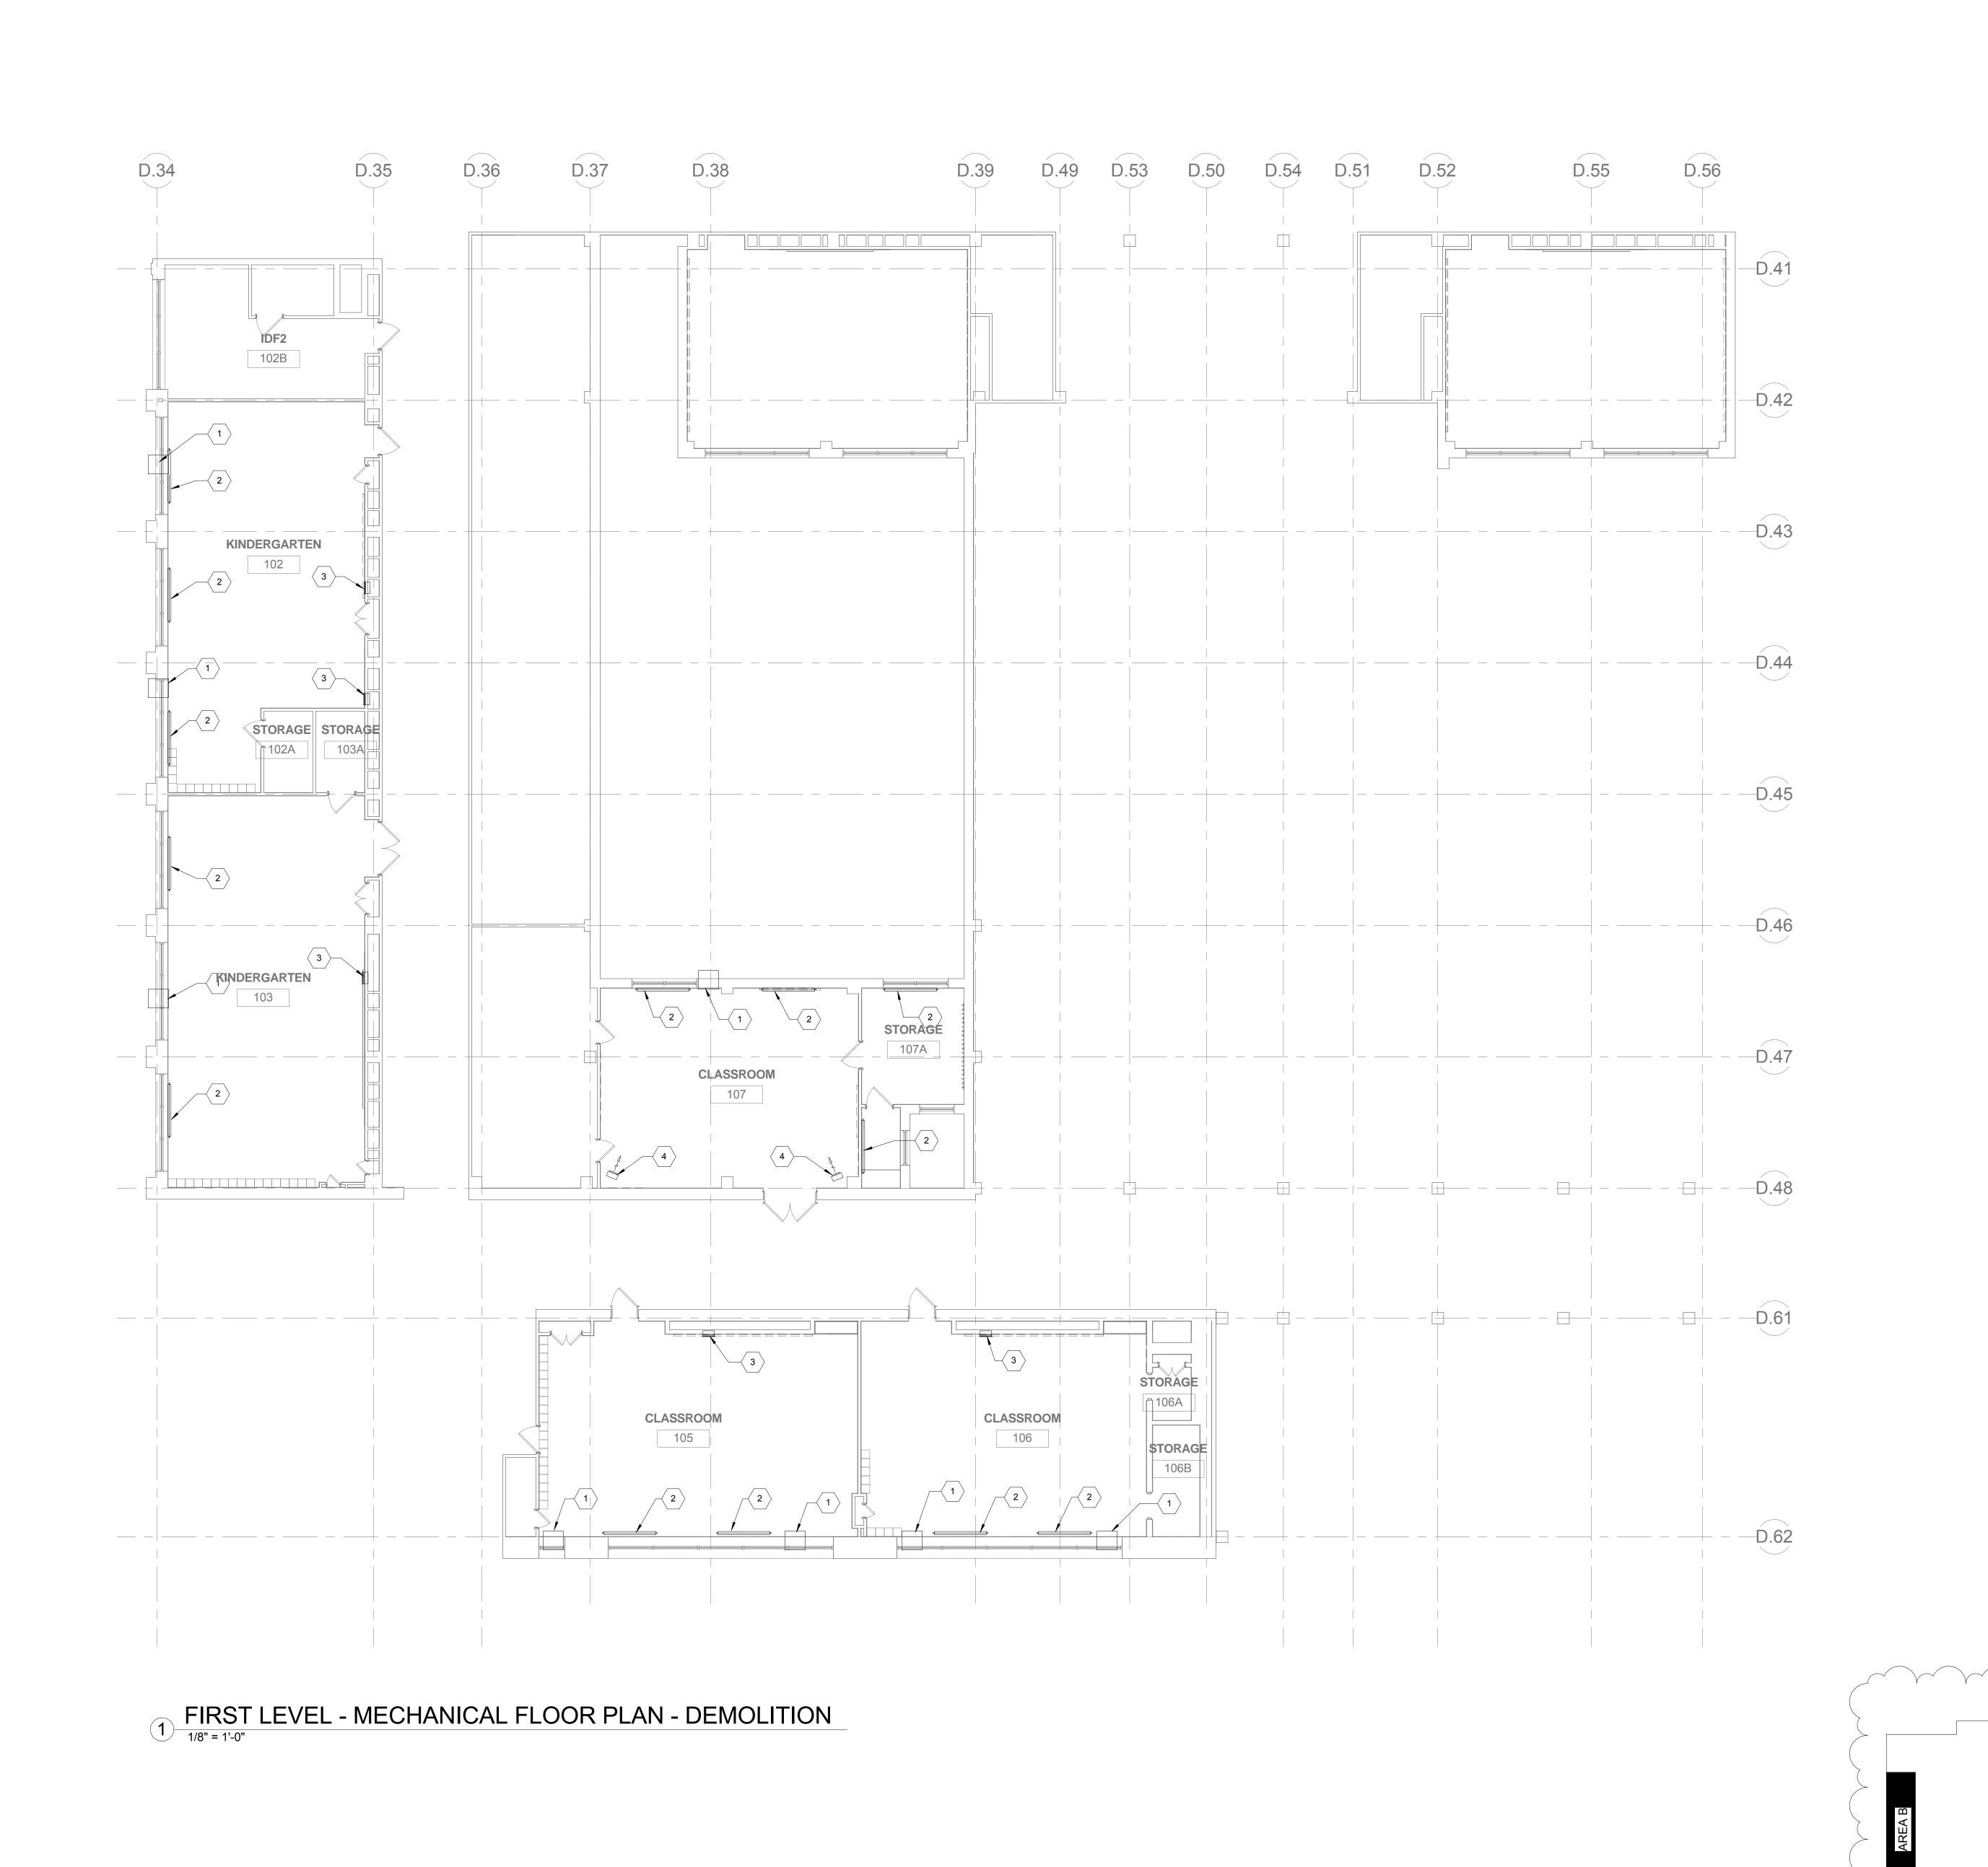

GENERAL NOTES

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SEAL:



KEYED NOTES

DEMOLISH WINDOW TYPE AC UNIT. EXISTING STEAM RADIATOR WITH COVER TO BE REFURBISHED. DEMOLISH SUPPLY AIR GRILLE. EXISTING UNIT HEATER TO REMAIN TO BE REFURBISHED.


Vassilis K. Skardis DATE STATE AND LICENSE NO: PA PE081586 09/30/2019

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Attn: Anil Giri

BID DOCUMENTS APRIL 20, 20108



SCHOOL & LOCATION G.W. Childs School

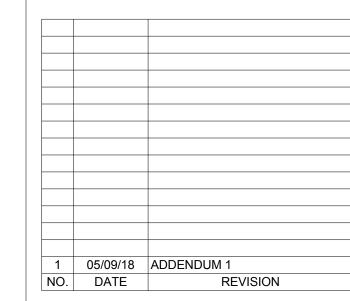1599 Whartons St. Philadelphia, PA

PROJECT TITLE

Classroom Modifications to G.W. Childs School

DRAWING TITLE


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KEY PLAN (NTS)

FIRST LEVEL - MECHANICAL FLOOR PLAN - DEMOLITION

LOCATION NO.	FIL	E NO.	
DRAWN BY Author	•	HECKED BY ecker	
B-071 C B-074 C	OF OF	2017/18 2017/18	

MD112

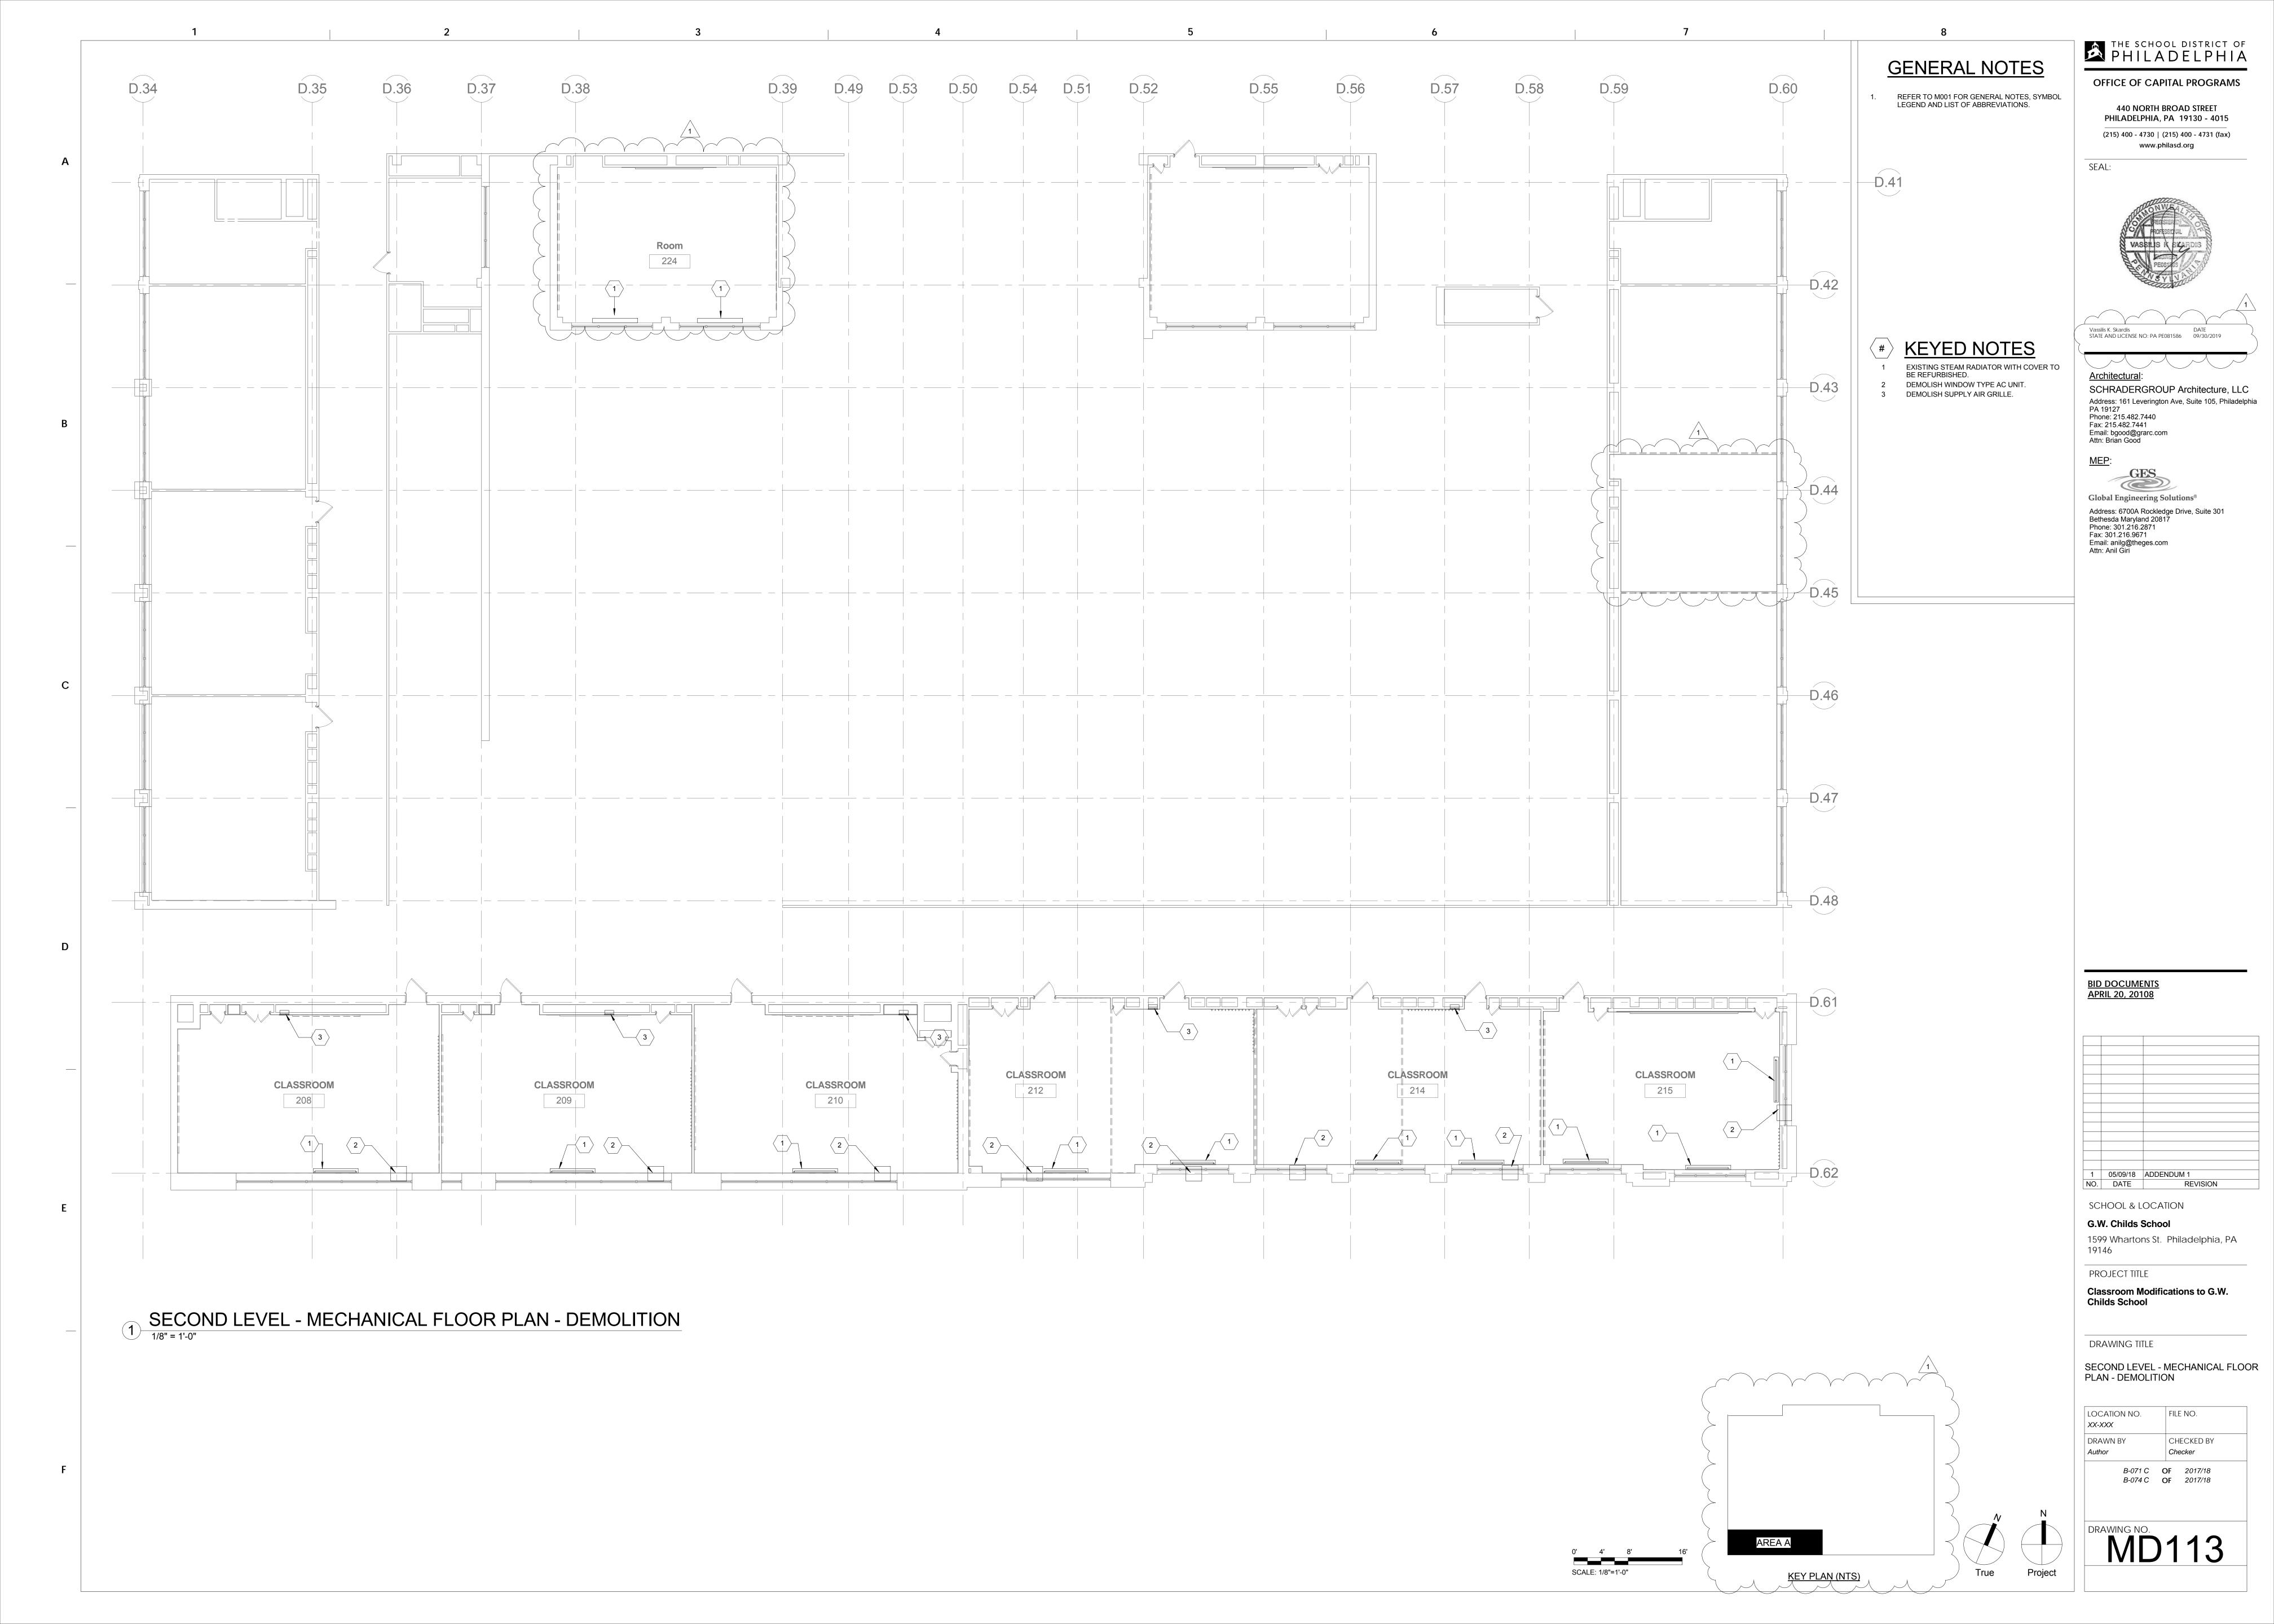

THE SCHOOL DISTRICT OF PHILADELPHIA **GENERAL NOTES** REFER TO M001 FOR GENERAL NOTES, SYMBOL LEGEND AND LIST OF ABBREVIATIONS. www.philasd.org SEAL: Vassilis K. Skardis DATE STATE AND LICENSE NO: PA PE081586 09/30/2019 **KEYED NOTES** PROVIDE SUPPLY AIR GRILLE WITH THE SAME SIZE AS EXISTING, TITUS MODEL 301FL OR APPROVED EQUAL. REFURBISH STEAM RADIATOR: CLEAN AND REMOVE DUST FROM THE RADIATOR SURFACE AND COVER. DISCONNECT RADIATOR, REMOVE SEDIMENT CLOGS FROM THE COIL AND RECONNECT. Fax: 215.482.7441 Email: bgood@grarc.com Attn: Brian Good 001A ____ BID DOCUMENTS APRIL 20, 20108 BASEMENT LEVEL - MECHANICAL FLOOR PLAN - NEW WORK DRAWING TITLE

OFFICE OF CAPITAL PROGRAMS


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SCHOOL & LOCATION

G.W. Childs School 1599 Whartons St. Philadelphia, PA

PROJECT TITLE Classroom Modifications to G.W.

Childs School

BASEMENT - MECHANICAL FLOOR PLAN - NEW WORK

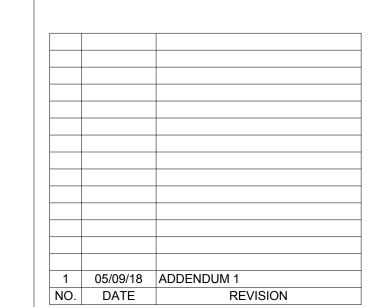LOCATION NO. XX-XXX	FIL	E NO.
DRAWN BY	CH	HECKED BY
Author	Ch	ecker
B-071 C	OF	2017/18
B-074 C	OF	2017/18

SCALE: 1/8"=1'-0"

KEY PLAN (NTS)



