

THE SCHOOL DISTRICT OF PHILADELPHIA
Office of Capital Programs
440 North Broad Street, 3rd Floor – Suite 371
Philadelphia, PA 19130

TELEPHONE: (215) 400-4730

Addendum No. 001

Subject: Edward T. Steel School – Classroom Modifications
SDP Contract Nos. B-0673C, B-070C of 2017/18

Location: Edward T. Steel School
4301 Wayne Avenue
Philadelphia, Pennsylvania 19140

This Addendum, dated May 9, 2018, shall modify and become part of the Contract Documents for the work of this project. Any items not mentioned herein, or affected by, shall be performed strictly in accordance with the original documents.

The following items, clarifications and/or revisions are to be included in the Contract Documents:

DRAWINGS

Drawing: A001

Revisions:

- a. General Notes: Add note 38 to read as follows:
 38. PROVIDE AN ALLOWANCE OF 100 SQUARE FEET OF NEW GLASS/WOOD TRIM REPLACEMENT IN EXISTING CLASSROOM DOORS AND SIDELIGHTS. AREAS REQUIRING REPLACEMENT WILL BE DETERMINED AND COORDINATED IN THE FIELD WITH THE SCHOOL DISTRICT CONSTRUCTION REPRESENTATIVE.

Drawing: A101

Revisions:

- a. Renovation Notes: Revise note A34 to read as follows (typical for all drawings):
 - A34 INSTALL NEW COAT HOOKS (30 HOOKS) AND PLASTIC LAMINATE SHELVES WHERE INDICATED.

Drawing: A101.2

Revisions:

- a. Interior Elevation 3/A101.2: Add the dimension 3'-3" from the new markerboard/tackboard to the adjacent wall on the right side.
- b. Interior Elevation 4/A101.2: Revise the new tackboard to be 36" wide instead of 48" wide.

Drawing: A102

Revisions:

- a. Partial Second Floor Demolition Plan Area B, 1/A102: Add demolition tag D07 to Classroom 202, Classroom 204 and Classroom 206.
- b. Partial Second Floor Plan Area B, 2/A102: Remove the A02 tag in the Classroom 202 storage alcove and change it to an A12 tag.
- c. Partial Second Floor Plan Area B, 2/A102: The A12 tag should also extend to all three walls in the corridor alcove area outside the classrooms.

- d. Partial Second Reflected Ceiling Plan Area B, 4/A102: See attached revised drawing A102 for revised ceiling grid layout.

Drawing: A102.1

Revisions:

- a. Interior Elevation 4/A102.1: Change the 2'-0" dimension for the tackboard to 1'-0".

Drawing: A103

Revisions:

- a. Second Floor Plan Area C, 2/A103: The A12 tag should also extend to all three walls in the corridor alcove area outside the classrooms.
- b. Second Reflected Ceiling Plan Area C, 3/A103: See attached revised drawing A103 for revised ceiling grid layout.

Drawing: A103.1

Revisions:

- a. Interior Elevation 3/A103.1: Change the 2'-0" dimension for the tackboard to 1'-0".
- b. Interior Elevation 16/A103.1: Change the 2'-0" dimension for the tackboard to 1'-0".

Drawing: A501

Revisions:

- a. Typical Locker Section Detail 2/A501: See attached revised drawing A501 for revised detail.
- b. New Partition Detail 4/A501: Add the following note to the wall detail: PROVIDE FRAMING SUPPORT FOR INSTRUCTIONAL BOARDS.

Drawing: A601

Revisions:

- a. Door and Frame Schedule: See attached revised drawing A601 for added "Hardware Type" column.

Drawing: All Mechanical Drawings

Revisions:

- a. ADD key plan and seal information on all mechanical sheets.

Drawing: All Mechanical and Electrical Drawings

Revisions:

- a. Revised B-numbers on titleblock
- b. Revised Project title on titleblock

Drawing: **E001**

Revisions:

- a. Added Light fixture type B to lighting fixture schedule.

Drawing: **ED111**

Revisions:

- a. Added existing lighting in toilets and storage rooms and key plan.

Drawing: **ED112:**

Revisions:

- a. Added Key plan.

Drawing: **ED121**

Revisions:

- a. Added Key plan

Drawing: **ED122**

Revisions:

- a. Added Key plan.

Drawing: **E111**

Revisions:

- a. Added switch control designation on lighting floor plan.
- b. Added Key plan and graphic scale.

Drawing: **E112**

Revisions:

- a. Added switch control designation on lighting floor plan.
- b. Added Key plan and graphic scale.

Drawing: **E121**

Revisions:

- a. Added receptacles in classrooms 105, 107, 109, 111 and 113.
- b. Revised and added key notes.
- c. Added wiring schedule.
- d. Added Key plan and graphic scale.

Drawing: **E122**

Revisions:

- a. Added receptacles and completed wiring in classrooms 201, 202, 203, 204, 205, 206, 207, 209 and 211.
- b. Revised and added key notes.
- c. Added wiring schedule.
- d. Added Key plan and graphic scale.

BIDDER'S QUESTIONS

1. **Question:** Due to the scope of work for all projects, the substantial completion date is unachievable. Along with lost time for moving of furniture and equipment before start of project. Can the date for substantial completion be extended?

Response: No

2. **Question:** Visual Display Surfaces - in spec there is a note if new boards are not installed in time, to use temporary boards as necessary, how many temporary boards are we to provide per classroom?

Response: Temporary boards do not need to be provided.

3. **Question:** Do we need to provide temporary window shades, if new ones are not installed before start of school?

Response: No. Existing shades are to be removed and salvaged/protected and reinstalled until new shades can be installed.

4. **Question:** Wood Floor Refinishing- some projects call for 2 coats of stain, can we forgo the stain and just use 2 coats of sealer and 2 coats of finish for all projects. You are adding on time to an already accelerated schedule.

Response: Sand, seal, and finish the wood floors in accordance with the specifications. Omit staining of the floor.

5. **Question:** Have you checks on the choices of accent colors for the VCT tile? The colors may be a stock color, but do they have enough on hand, if not they may not be readily available for the substantial completion date.

Response: Armstrong has been made aware of this project and its approximate square footage needs. Contractor to provide updated information on each color's availability immediately after NTP.

6. **Question:** Can you please include and spec for electrostatic painting.


Response: See Electrostatic Paint spec in Addendum #2.

ATTACHMENTS

Drawing A102
Drawing A103
Drawing A501
Drawing A601
Drawing E001
Drawing ED111
Drawing ED112
Drawing ED121
Drawing ED122
Drawing E111
Drawing E112
Drawing E121
Drawing E122
Drawing E401
Drawing E501
Drawing M001
Drawing MD111
Drawing MD112
Drawing M111
Drawing M112

End of Addendum No. 001

SEAL:

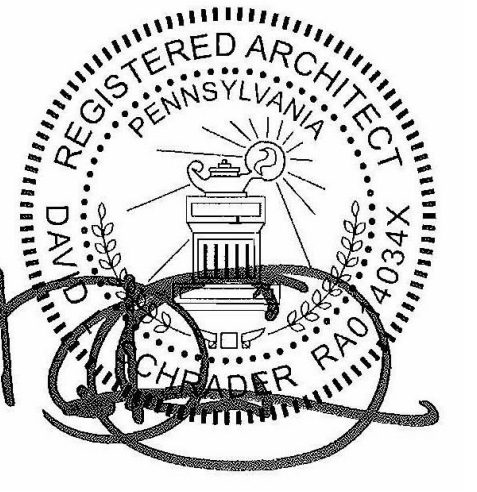

NAME (LICENSED PROFESSIONAL) DATE
STATE AND LICENSE NO. XX/XX/20XX

Architectural:


SCHRADERGROUP Architecture, LLC
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MEP:


Global Engineering Solutions
Address: 6700A Rockledge Drive, Suite #301, Bethesda, MD 20817
Phone: 301.216.2871
Fax: 301.216.9671
Email: aui@gesinc.com
Attn: Ani Giri

DEMOLITION NOTES	
Key Value	Keynote Text
D01	REMOVE EXISTING VCT FLOORING.
D03	REMOVE EXISTING CHALKBOARD/MARKERBOARD/TACKBOARD/TACKS TRIP/CHALKBOARD, INCLUDING ALL ASSOCIATED ACCESSORIES AND MASTIC/ADHESIVE. PATCH AND REPAIR EXISTING WALL AS REQUIRED TO MATCH ADJACENT EXPOSED SURFACES AND/OR TO ACCEPT NEW SPECIFIED DISPLAY SURFACE OR EQUIPMENT. REFER TO ENVIRONMENTAL COORDINATION SPECIFICATION.
D06	REMOVE EXISTING PROJECTION SCREEN AND BRACKETS. SALVAGE PROJECTION SCREEN AND DELIVER TO OWNER. CONTRACTOR TO DISPOSE OF MOUNTING BRACKETS.
D07	REMOVE EXISTING PAPER TOWEL DISPENSER/TOILET PAPER DISPENSER/SOAP DISPENSER/HAND SANITIZER DISPENSER. SALVAGE FOR REINSTALLATION AS PART OF NEW WORK.
D09	REMOVE EXISTING COAT HOOKS AND WOOD MOUNTING BRACKET.
D10	REMOVE EXISTING BASE CABINETS/TALL CABINETS/WALL CABINETS/COUNTER TOPS/BACKSPLASH/SHELVES, INCLUDING ALL ASSOCIATED ACCESSORIES, MOUNTING BRACKETS AND EXPOSED BLOCKING. PATCH AND REPAIR EXISTING WALL AS REQUIRED TO MATCH ADJACENT SURFACES AND/OR TO ACCEPT NEW SPECIFIED DISPLAY SURFACE OR EQUIPMENT. REFER TO ENVIRONMENTAL COORDINATION SPECIFICATION. WHERE THE CASEWORK IS MOUNTED ON EXISTING STRUCTURAL GLAZED BLOCK BASE, THE STRUCTURAL GLAZED BLOCK BASE SHALL REMAIN AND BE PREPARED FOR NEW CASEWORK.
D11	REMOVE EXISTING FOLDING PARTITION, TRACK AND ASSOCIATED HARDWARE. PATCH AND REPAIR EXISTING WALL TRIM AS REQUIRED TO MATCH ADJACENT SURFACES AND TO ACCEPT NEW FINISHES.
D13	REMOVE EXISTING DOOR KNOB, LATCH SET AND DOOR CLOSER. DOOR TO REMAIN.
D15	REMOVE EXISTING WINDOW TREATMENT AND ASSOCIATED HARDWARE FROM ALL WINDOWS. PATCH AND REPAIR EXISTING WALL TRIM AS REQUIRED TO MATCH ADJACENT SURFACES AND TO ACCEPT NEW SPECIFIED WINDOW TREATMENT.
D16	REMOVE EXISTING ACOUSTICAL CEILING TILE AND GRID.
D19	REMOVE EXISTING FREE-STANDING WOOD CUBBIES. COORDINATE WITH THE OWNER IF THE CUBBIES SHOULD BE DISPOSED OF OR SALVAGED AND DELIVERED TO THEM.
D28	REMOVE EXISTING KITCHENETTE UNIT IN ITS ENTIRETY, INCLUDING ALL ASSOCIATED APPLIANCES ACCESSORIES, MOUNTING BRACKETS AND EXPOSED BLOCKING. PATCH AND REPAIR EXISTING WALL AS REQUIRED TO MATCH ADJACENT SURFACES AND/OR TO ACCEPT NEW FINISH AND/OR EQUIPMENT. REFER TO ENVIRONMENTAL COORDINATION SPECIFICATION.


RENOVATION NOTES	
Key Value	Keynote Text
A01	INSTALL NEW VCT FLOORING. CLEAN, FLASH PATCH AND LEVEL FLOOR AS REQUIRED. PREP FLOOR TO RECEIVE NEW FINISH. REFER TO ENVIRONMENTAL COORDINATIONS SPECIFICATION.
A02	STRIP AND SAND, PATCH, CLEAN AND PREP EXISTING WOOD FLOORING AND PROVIDE A NEW CLEAR COAT FINISH. REPAIR ANY DAMAGED FLOORING AS REQUIRED. NEW FLOORING TO MATCH EXISTING ADJACENT FLOORING. COORDINATE LOCATIONS OF NEW FLOORING IN THE FIELD WITH THE OWNER.
A04	CLEAN EXISTING CERAMIC TILE FLOORING, BASE AND MARBLE THRESHOLD.
A06	INSTALL NEW RUBBER WALL BASE. CLEAN AND PREP EXISTING SURFACE FOR NEW FINISH.
A07	CLEAN EXISTING STRUCTURAL GLAZED BLOCK WALL BASE.
A12	PAINT EXISTING CMU/PLASTER/GWB AND EXPOSED PIPES. SCRAPE EXISTING LOOSE PAINT, SAND (INCLUDING THE REMOVAL OF ALL STAPLES, ETC.) CLEAN AND PREP SURFACE FOR NEW FINISH.
A14	INSTALL NEW 2'x4' SUSPENDED ACOUSTICAL TILE CEILING AND GRID.
A16	INSTALL NEW INTERIOR WINDOW SHADES AS SPECIFIED ON ALL EXTERIOR WINDOW UNITS IN CLASSROOM.
A17	INSTALL NEW HARDWARE AS SCHEDULED ON EXISTING DOOR.
A20	PATCH, LIGHTLY SAND, CLEAN (INCLUDING THE REMOVAL OF ALL STAPLES, ETC.) AND PREP EXISTING WOOD DOOR AND PROVIDE NEW CLEAR COAT FINISH. REPAIR DAMAGED AREAS TO MATCH ADJACENT PROFILE, INCLUDING WOOD GRILLES AND GLASS WHERE OCCURS. DAMAGED WOOD AND GLAZING AREAS SHOULD BE REVIEWED WITH THE OWNER IN THE FIELD.
A22	PAINT EXISTING HOLLOW METAL DOOR FRAME. LIGHTLY SAND, CLEAN AND PREP SURFACE FOR NEW FINISH. PAINT ENTIRE FRAME (BOTH SIDES). CORRIDOR SIDE COLOR TO MATCH OTHER EXISTING CORRIDOR DOOR FRAMES.
A24	INSTALL NEW MARKERBOARD AS SCHEDULED.
A25	INSTALL NEW TACKBOARD AS SCHEDULED.
A28	INSTALL NEW STUD/GW WALL AS SCHEDULED IN EXISTING FOLDING PARTITION OPENING. FINISH/PAINT AS SCHEDULED (BOTH SIDES).
A29	PATCH, LIGHTLY SAND, CLEAN (INCLUDING THE REMOVAL OF ALL STAPLES, ETC.) AND PREP EXISTING WOOD CASEWORK/COUNTER TOPS/SHELVES AND PROVIDE NEW CLEAR COAT FINISH. REPAIR DAMAGED AREAS/HARDWARE TO MATCH EXISTING ADJACENT.
A30	INSTALL NEW PLASTIC LAMINATE CASEWORK AS SCHEDULED.
A34	INSTALL NEW COAT HOOKS (30 HOOKS).
A35	RE-INSTALL SALVAGED PAPER TOWEL DISPENSER/TOILET PAPER DISPENSER/SOAP DISPENSER/HAND SANITIZER DISPENSER.
A42	PAINT EXISTING METAL LOUVER (BOTH SIDES). LIGHTLY SAND, CLEAN AND PREP SURFACE FOR NEW FINISH. MATCH DOOR FRAME COLOR.
A43	PATCH, LIGHTLY SAND, CLEAN (INCLUDING THE REMOVAL OF ALL STAPLES, ETC.) AND PREP EXISTING WOOD TRANSOM PANEL AND PROVIDE NEW CLEAR COAT FINISH. REPAIR DAMAGED AREAS TO MATCH ADJACENT PROFILE.

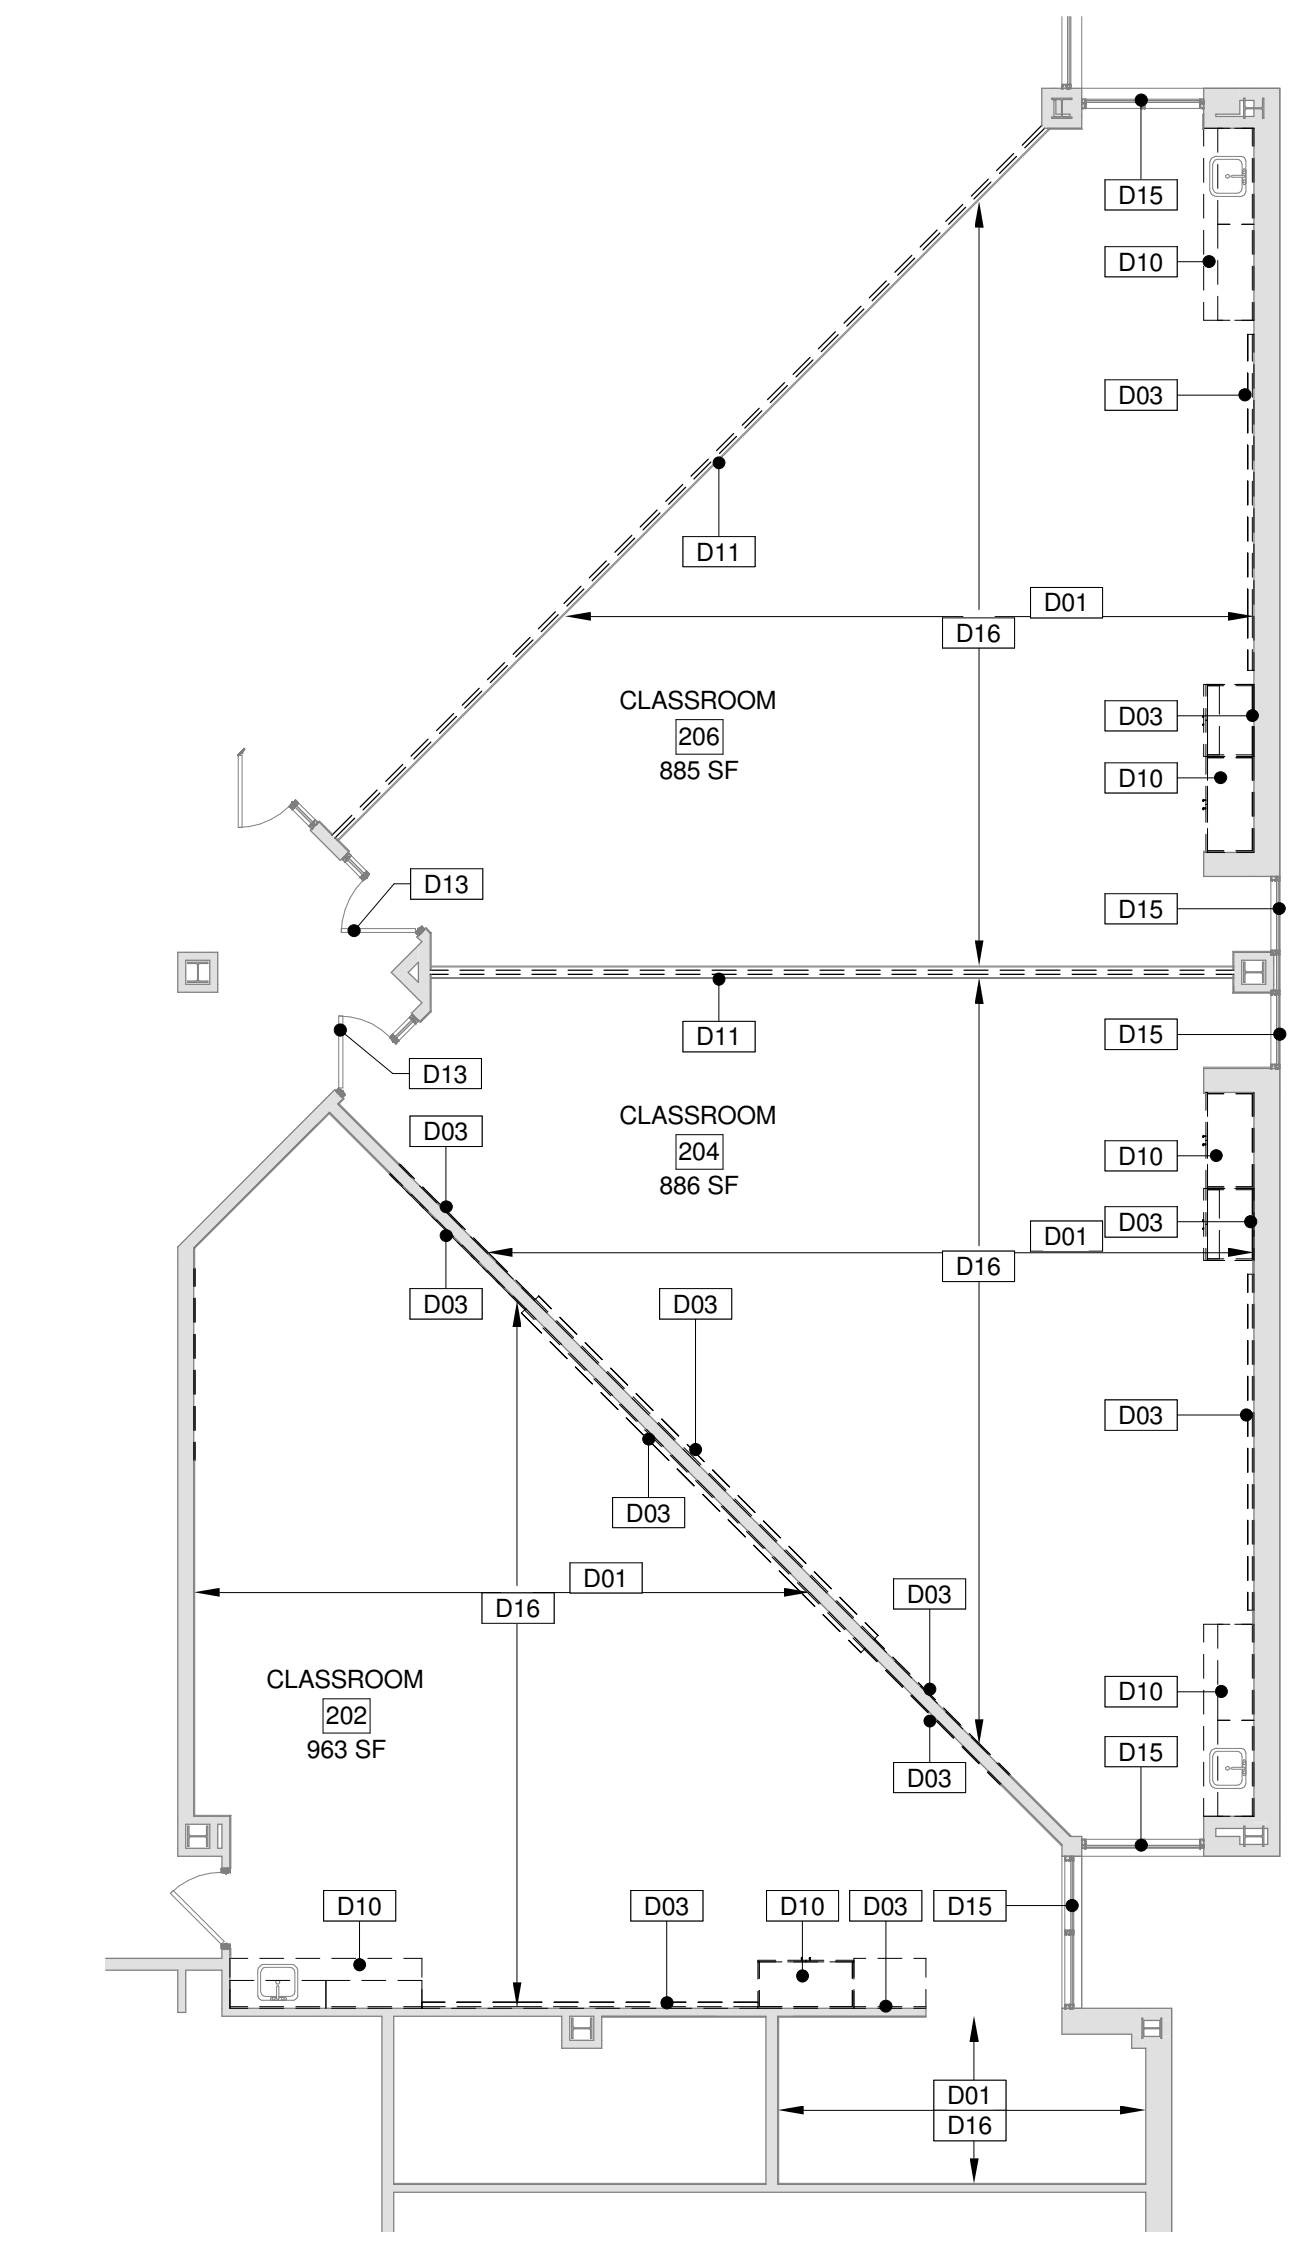


1 PARTIAL SECOND FLOOR DEMOLITION PLAN AREA B
A102 SCALE: 1/8" = 1'-0"

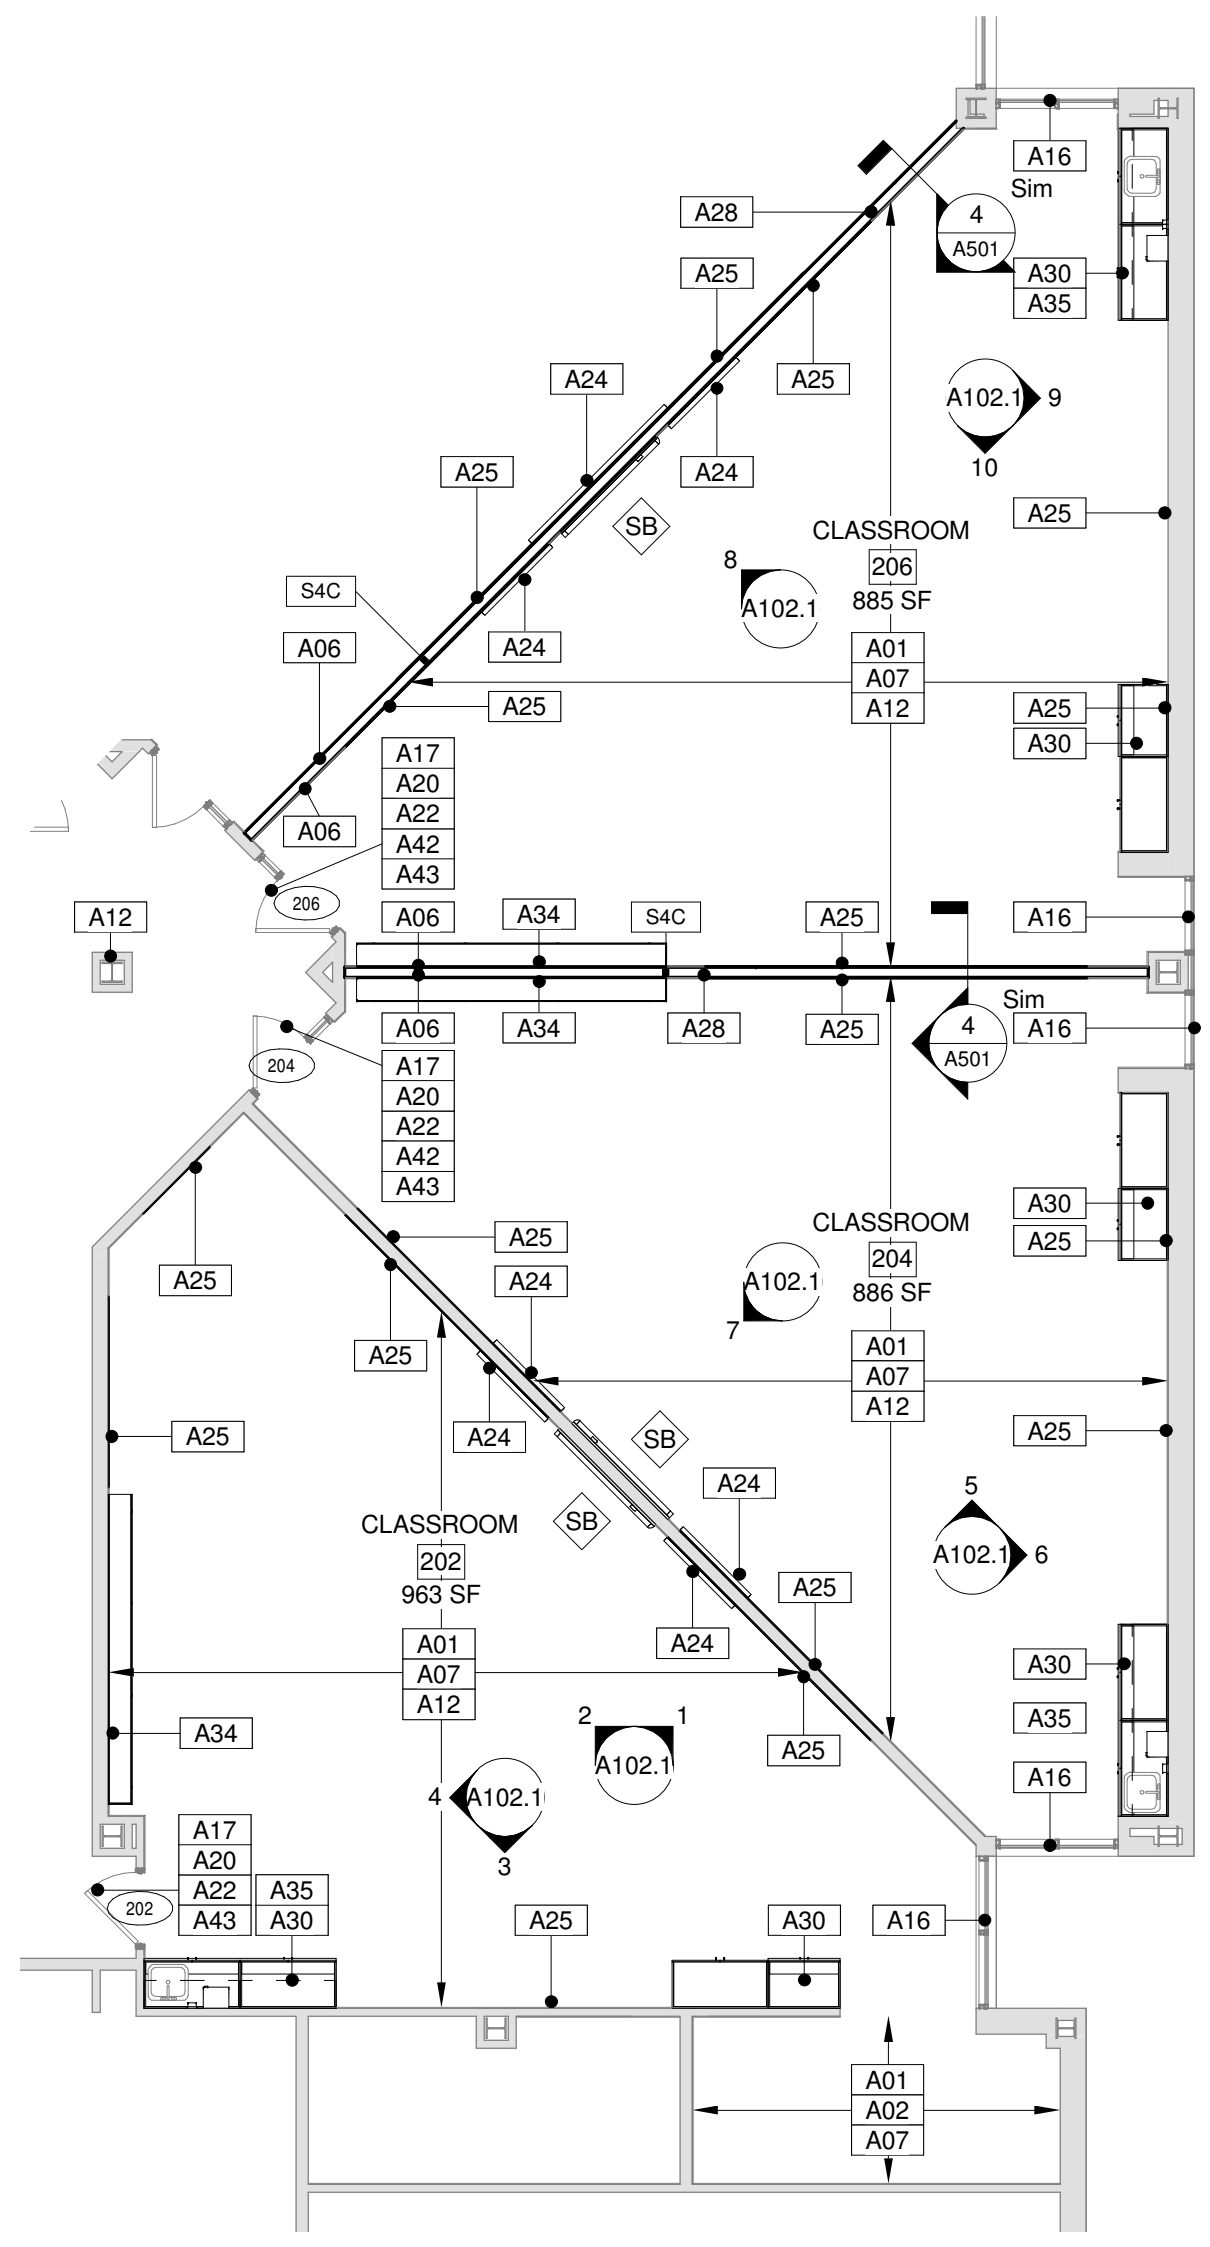

2 PARTIAL SECOND FLOOR PLAN AREA B
A102 SCALE: 1/8" = 1'-0"

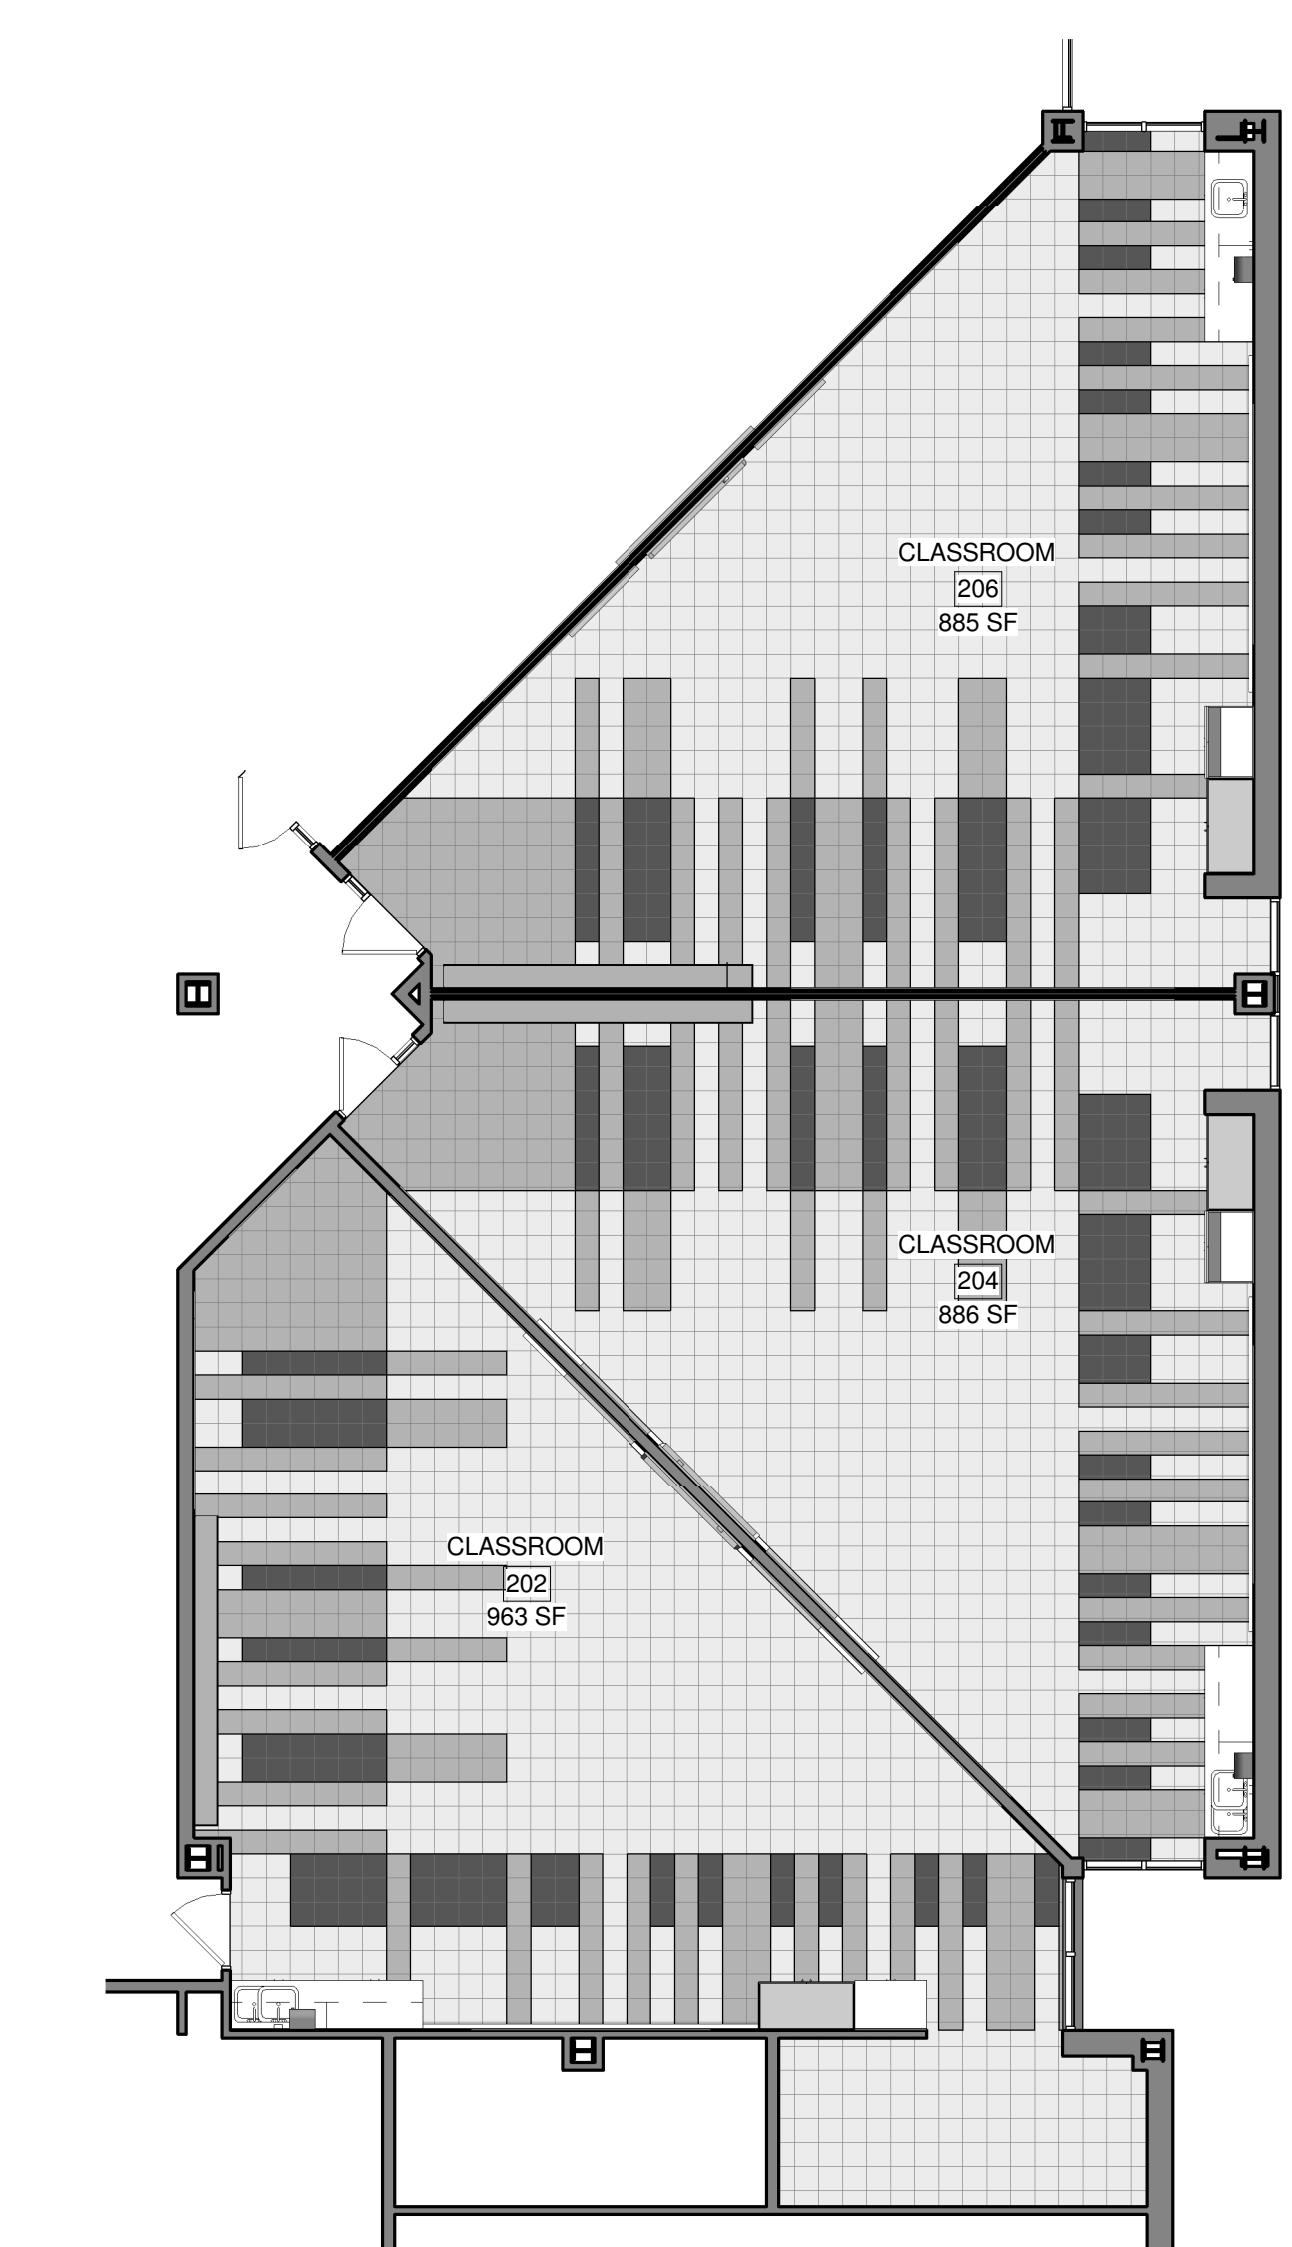

3 PARTIAL SECOND FLOOR PLAN AREA B
A102 SCALE: 1/8" = 1'-0"

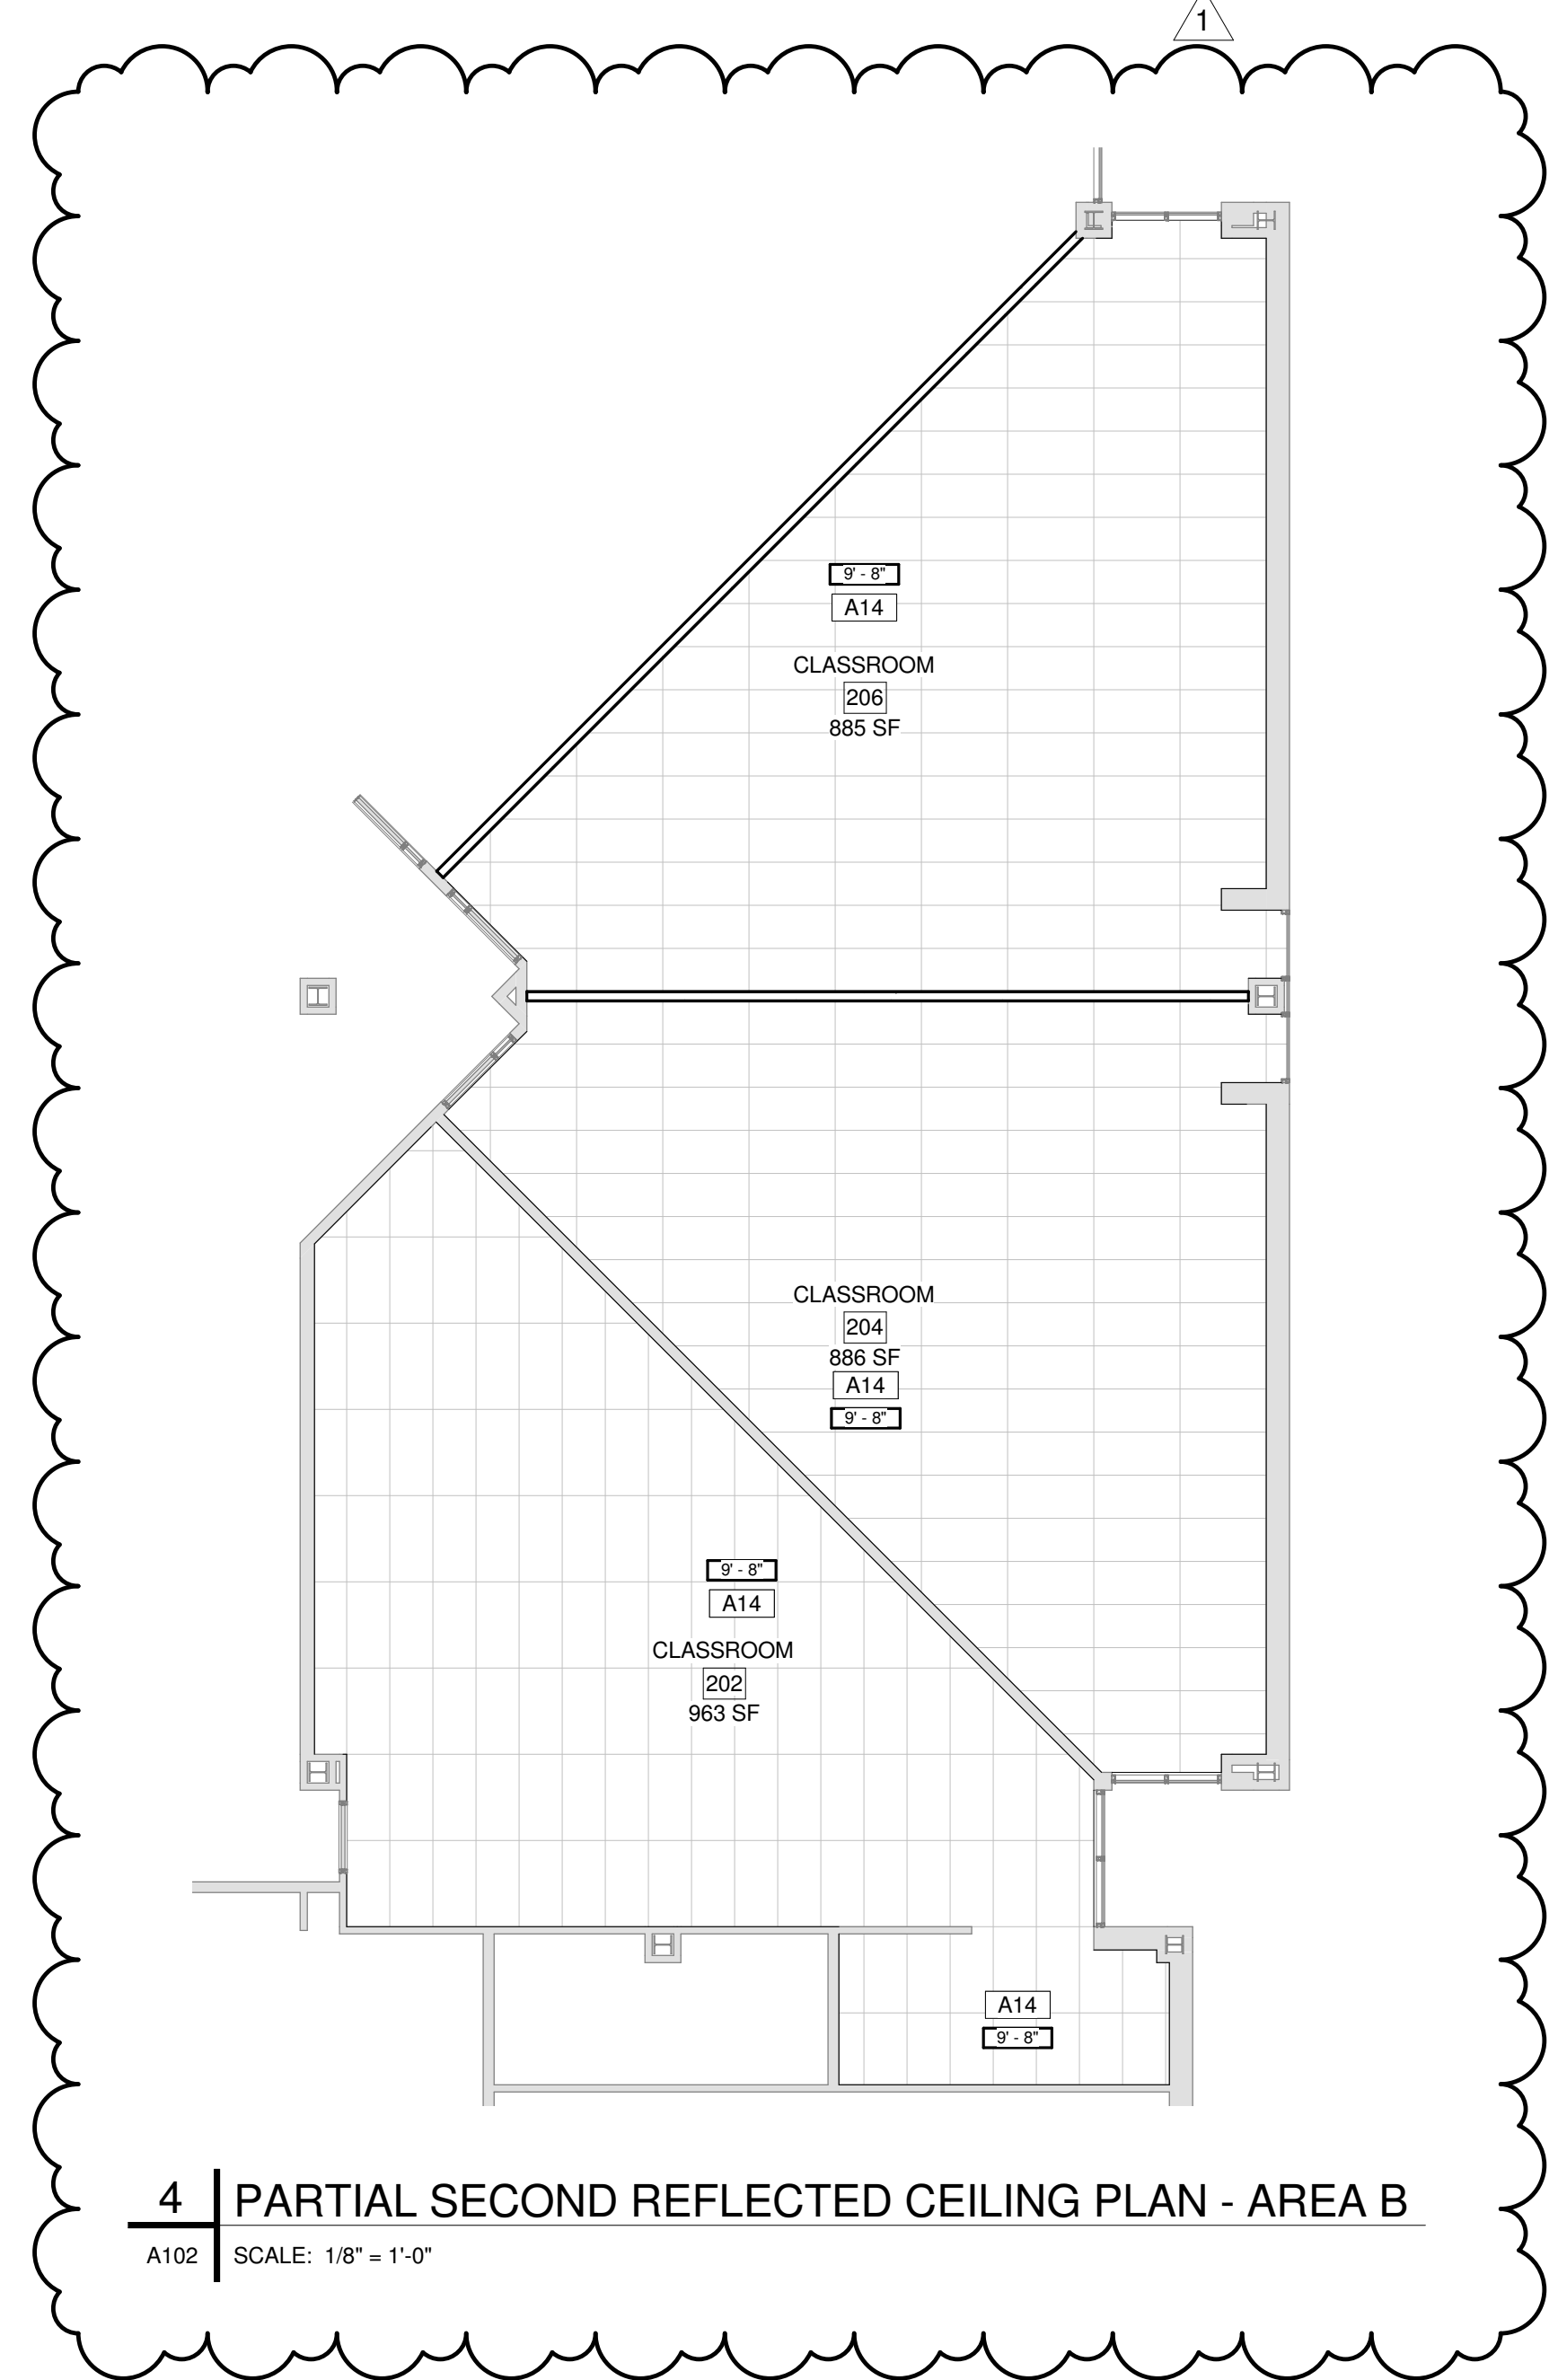

4 PARTIAL SECOND FLOOR REFLECTED CEILING PLAN - AREA B
A102 SCALE: 1/8" = 1'-0"

BID DOCUMENTS
APRIL 20, 2018

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1	5/9/18 ADDENDUM #1
NO. DATE	REVISION

SCHOOL & LOCATION

Edward T. Steel Elementary School
4301 Wayne Avenue, Philadelphia PA 19140

PROJECT TITLE

Classroom Modifications to Edward T. Steel Elementary School


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SECOND FLOOR PARTIAL PLAN AREA B


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B-070 C	OF 2017/18

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A102



SEAL:

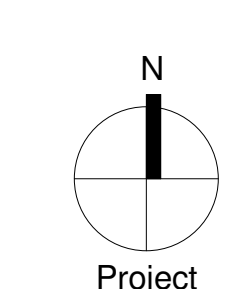

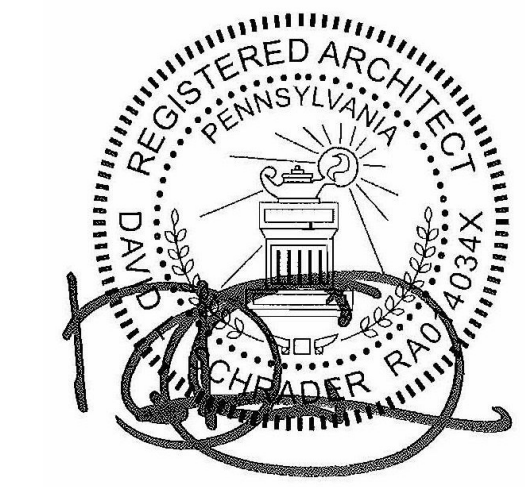NAME (LICENSED PROFESSIONAL) DATE
STATE AND LICENSE NO. XX/XX/20XX

Architectural:

SCHRADERGROUP Architecture, LLC
Address: 161 Leverington Ave, Suite 105, Philadelphia, PA 19127
Phone: 215-482-7440
Fax: 215-482-7441
Email: bgoood@sgarc.com
Attn: Brian Good

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Attn: Ani Giri

Floor Finish Area	
VCT-1	ROOMS 202, 204, 206, 207, 209, 211
VCT-2	ROOMS 202, 204, 206, 207, 209, 211
VCT-3	ROOMS 202, 204, 206, 207, 209, 211
VCT-4	ROOMS 105, 105A, 107, 107B, 109, 111, 111B, 113, 201, 203, 205
VCT-5	ROOMS 105, 107, 109, 111, 113, 201, 203, 205
VCT-6	ROOMS 105, 107, 109, 111, 113, 201, 203, 205

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BID DOCUMENTS
APRIL 20, 2018

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1	5/9/18	ADDENDUM #1
NO.	DATE	REVISION

SCHOOL & LOCATION

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1301 Wayne Avenue, Philadelphia PA 19140

PROJECT TITLE

Classroom Modifications to Edward T. Steel Elementary School



DRAWING TITLE

SECOND PARTIAL FLOOR PLAN AREA C

LOCATION NO.	FILE NO.
XX-XXX	
DRAWN BY	CHECKED BY
Author	Checker
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B-070 C	OF 2017/18


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A103

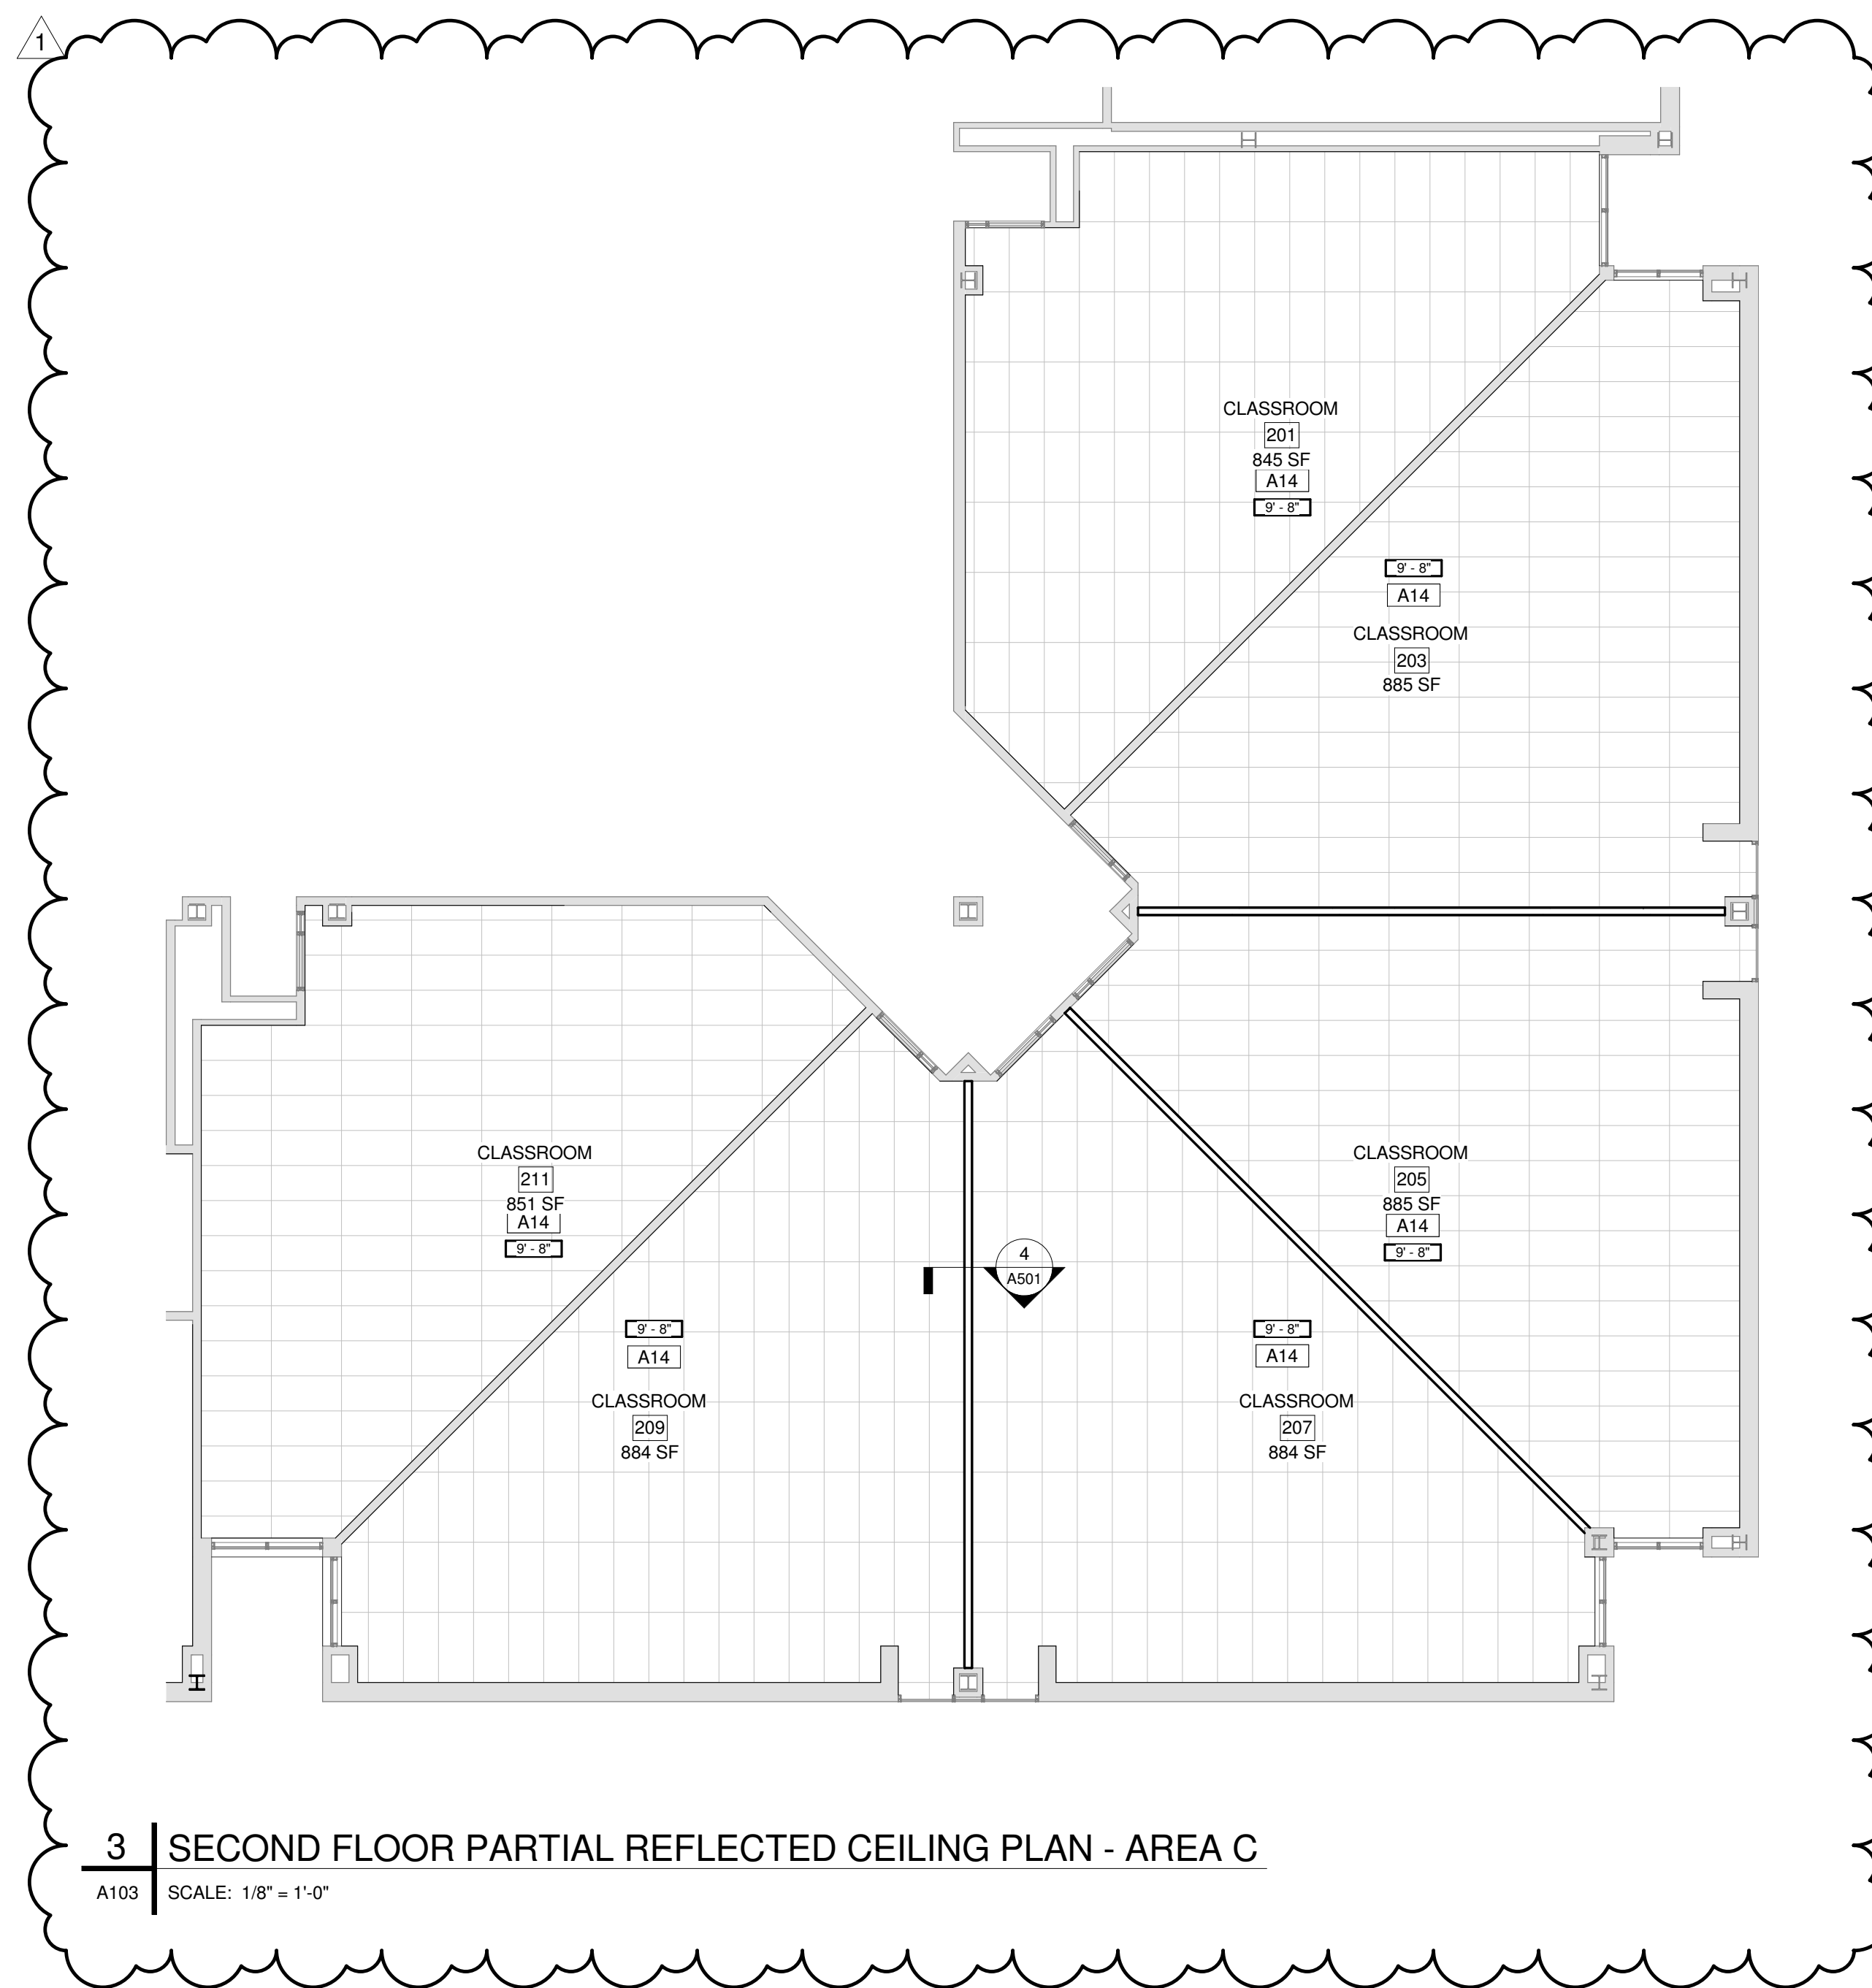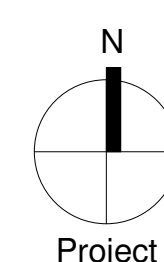


3 SECOND FLOOR PARTIAL REFLECTED CEILING PLAN - AREA C

A103 SCALE: 1/8" = 1'-0"

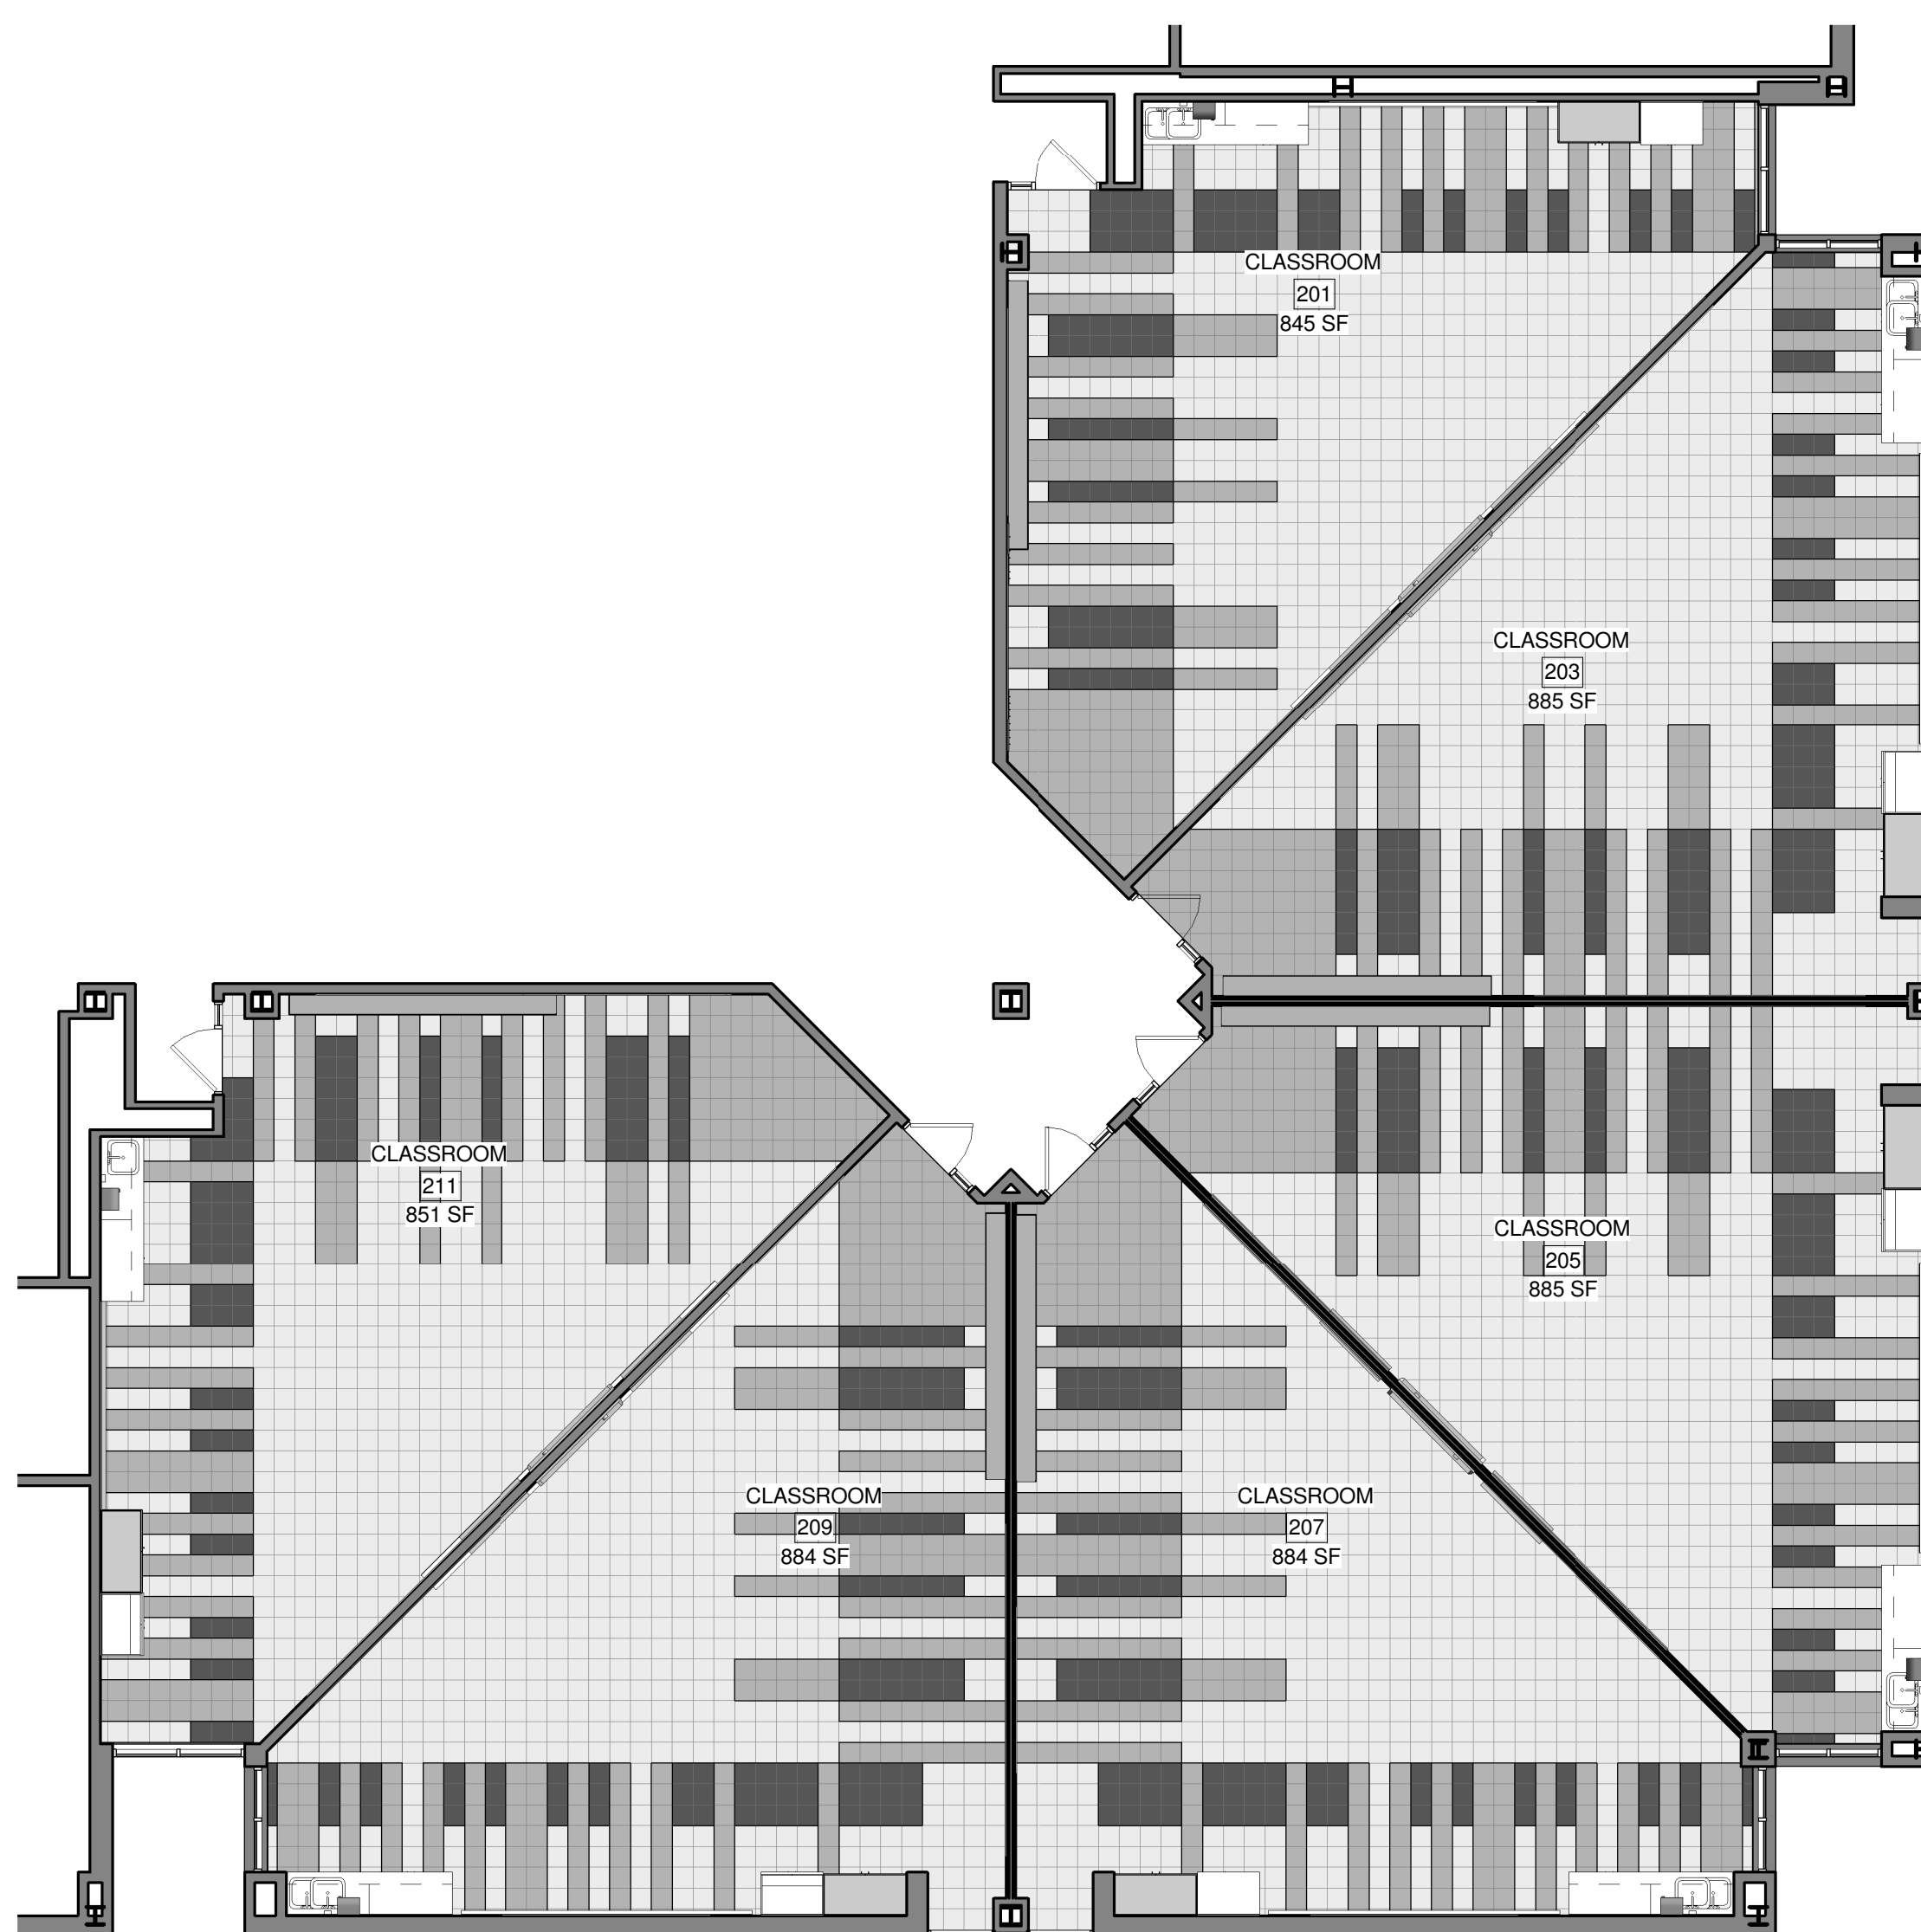


4 SECOND FLOOR PARTIAL FINISH PLAN AREA C

A103 SCALE: 1/8" = 1'-0"

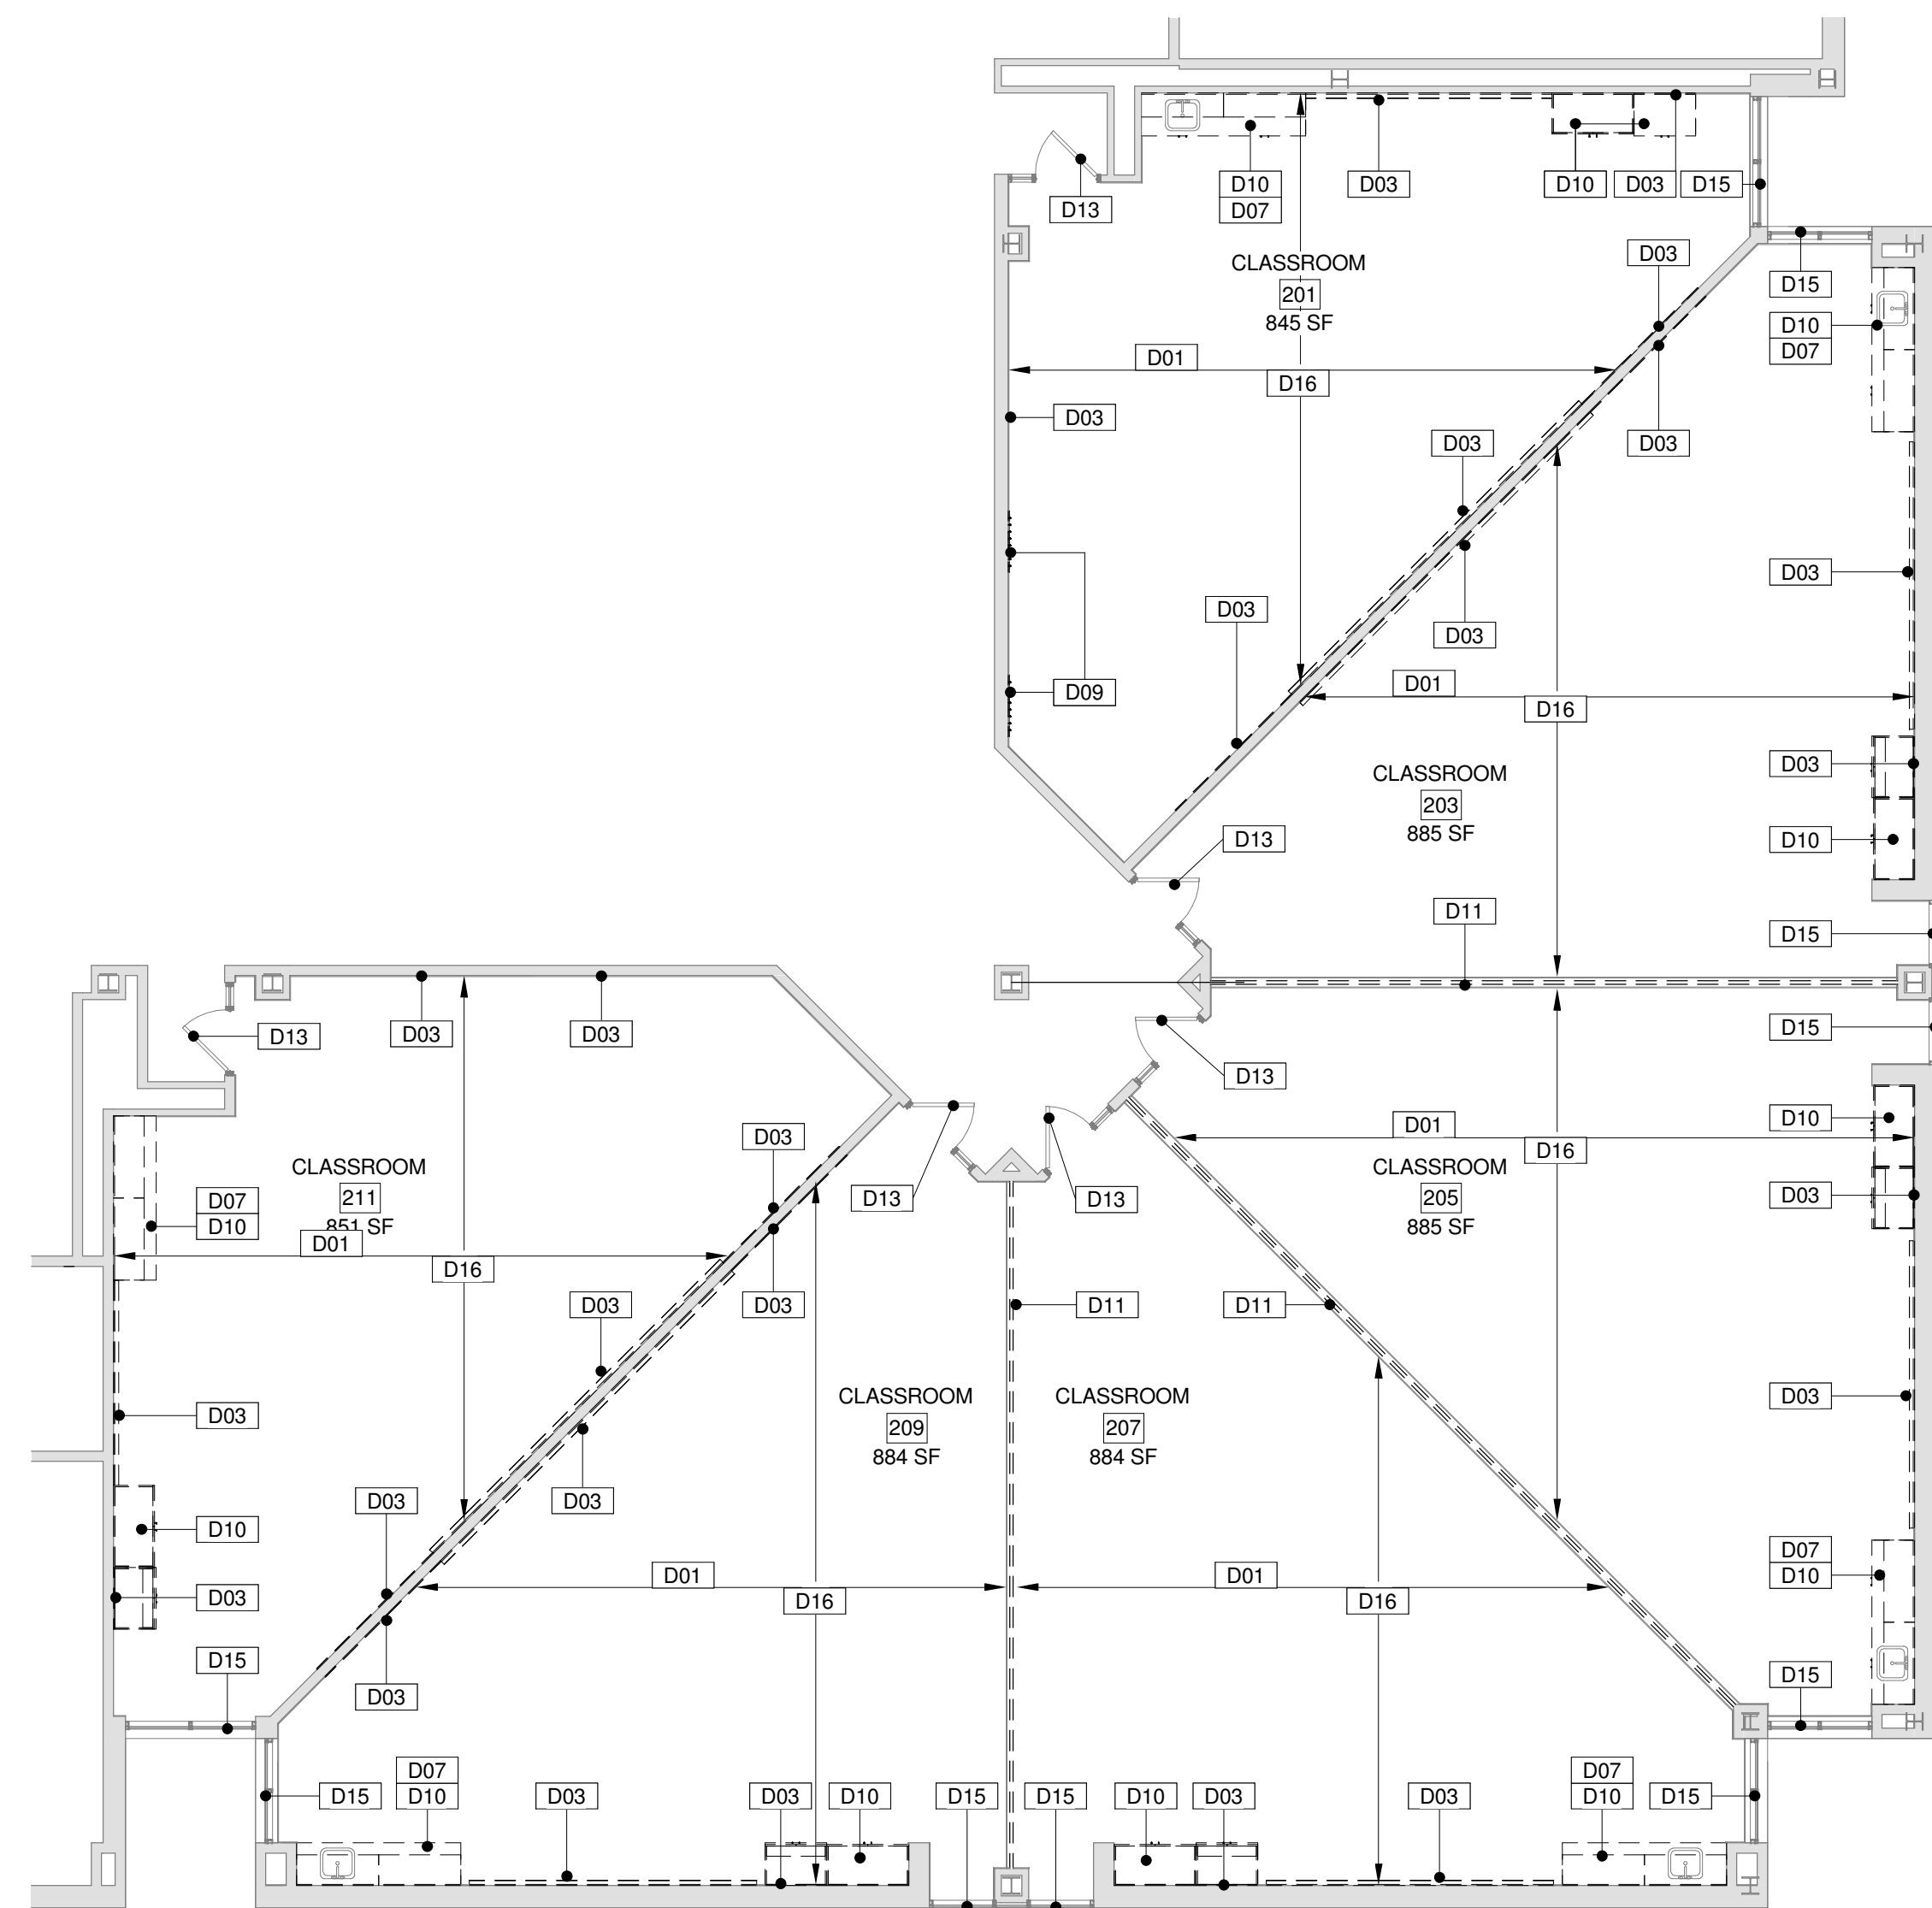

1 SECOND FLOOR PARTIAL DEMOLITION PLAN AREA C


A103 SCALE: 1/8" = 1'-0"

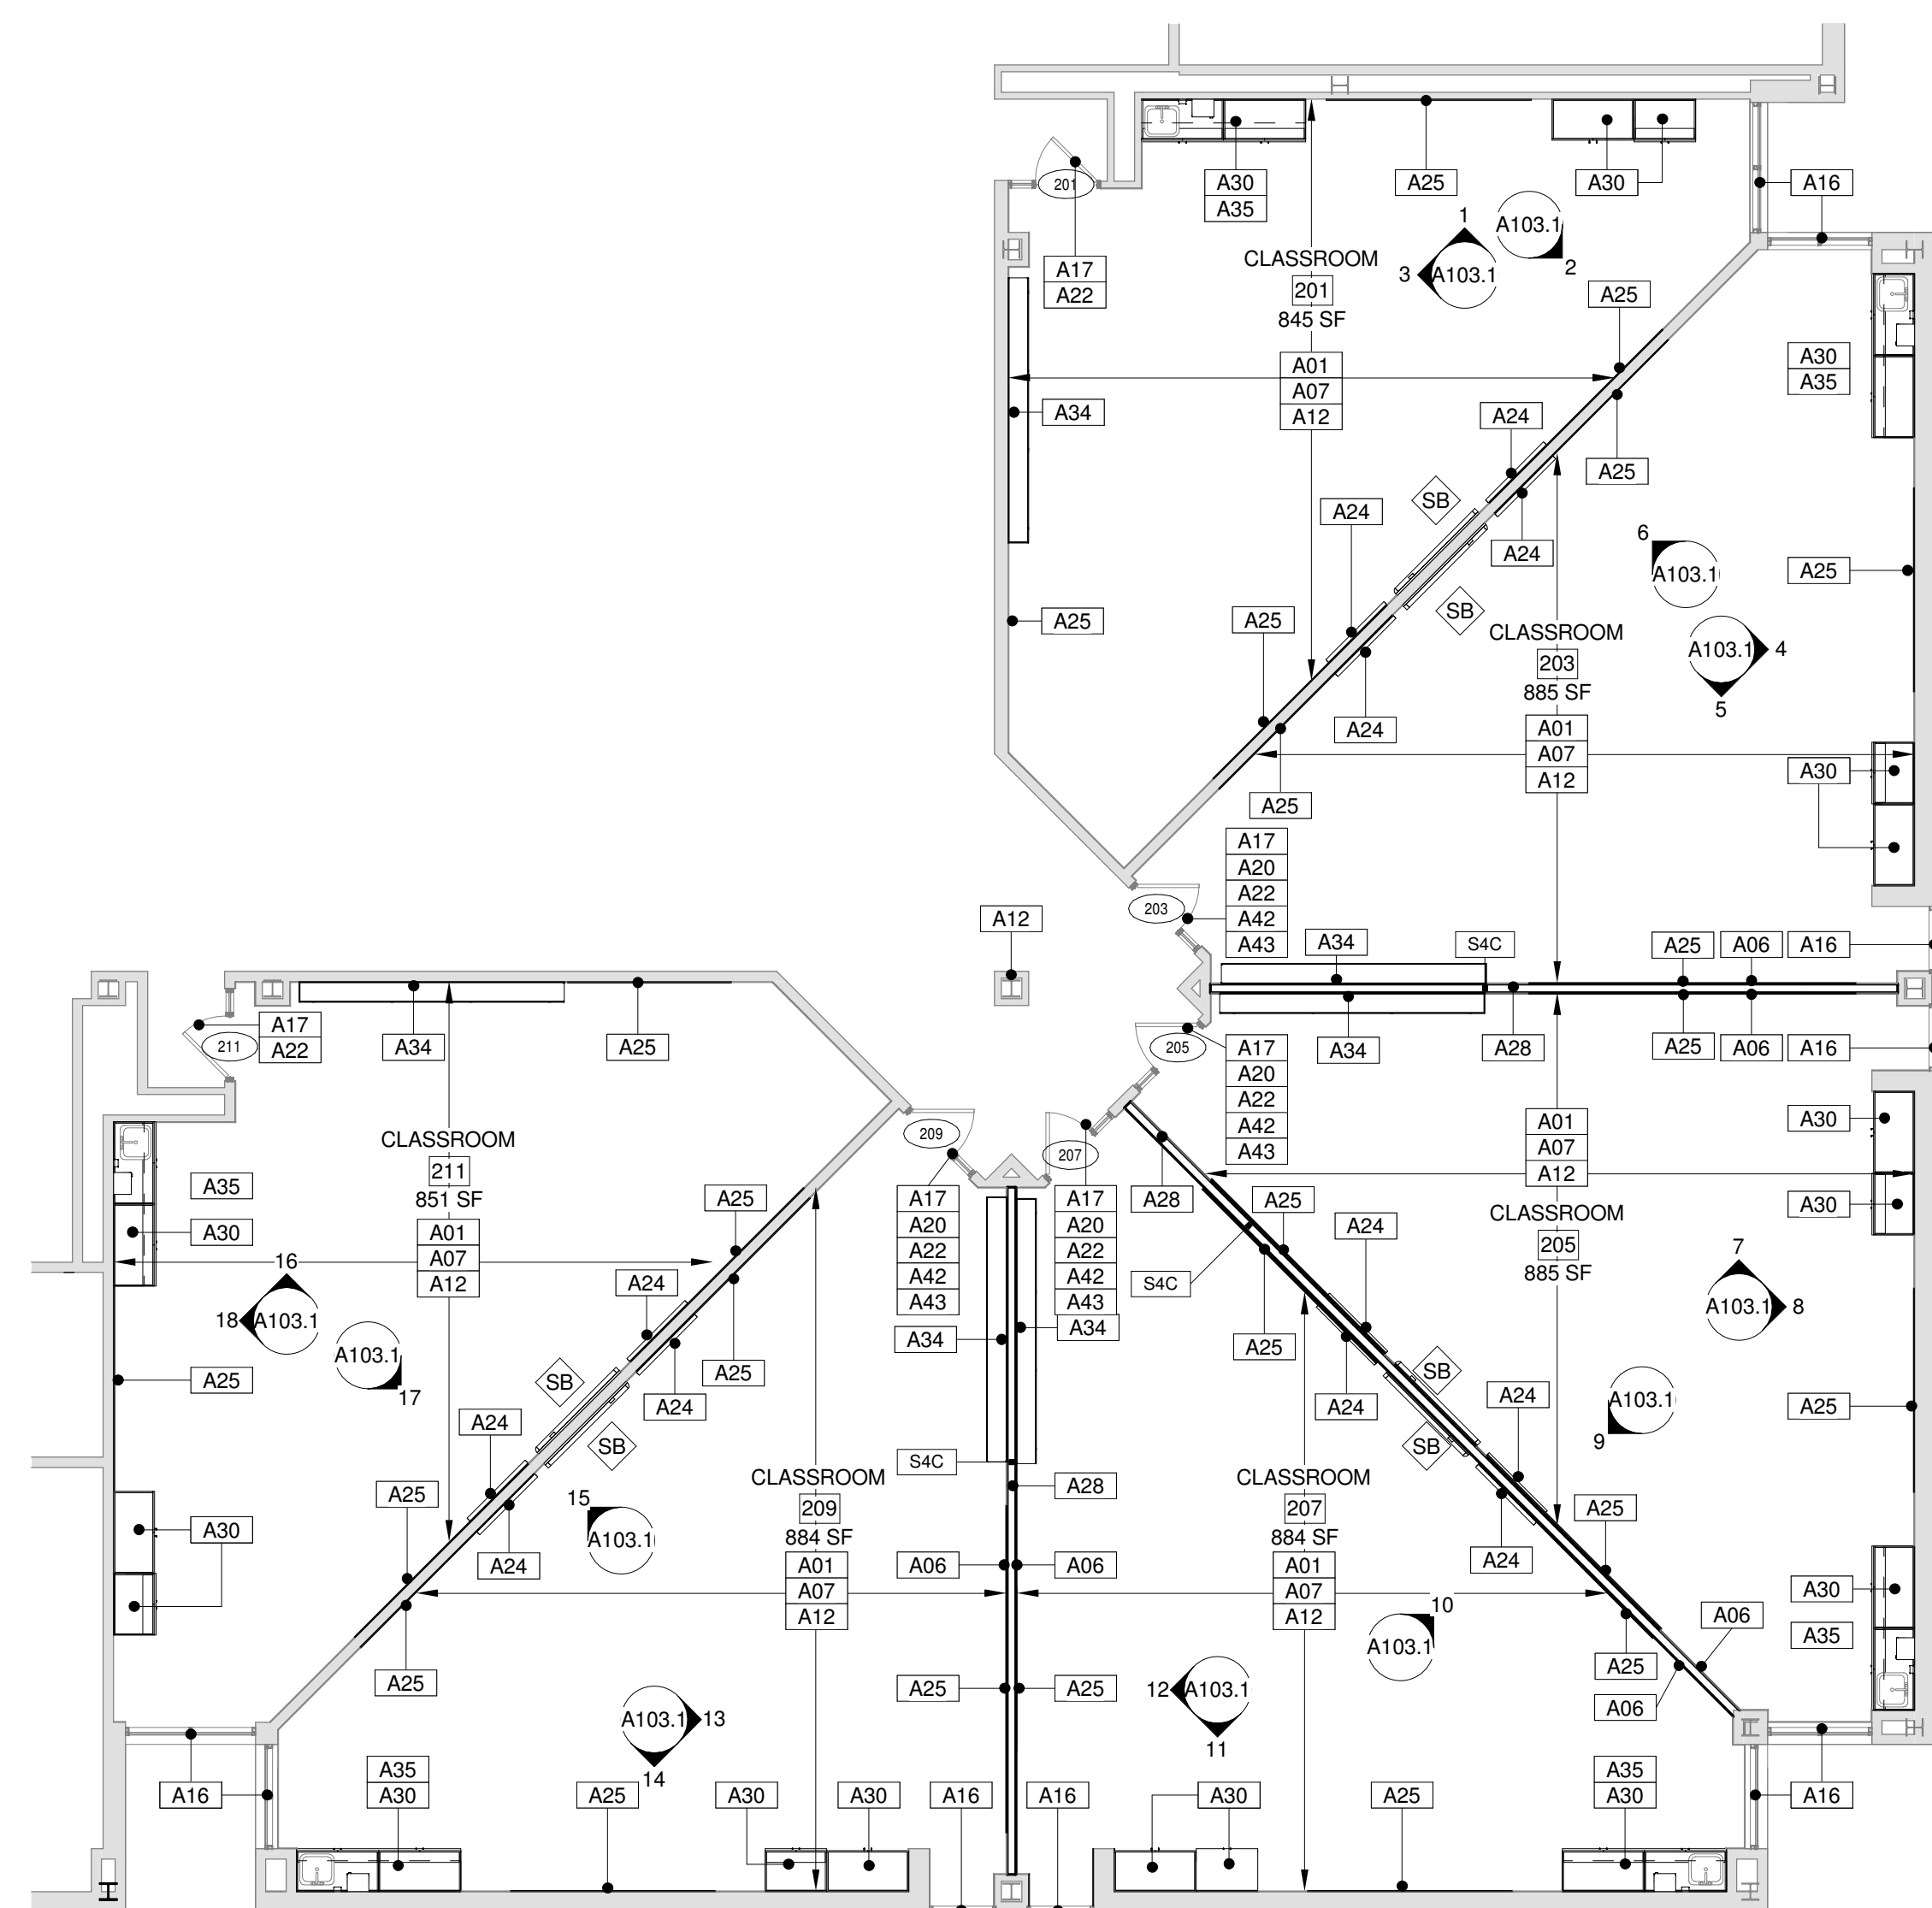

2 SECOND FLOOR PARTIAL PLAN AREA C

A103 SCALE: 1/8" = 1'-0"

SEAL:

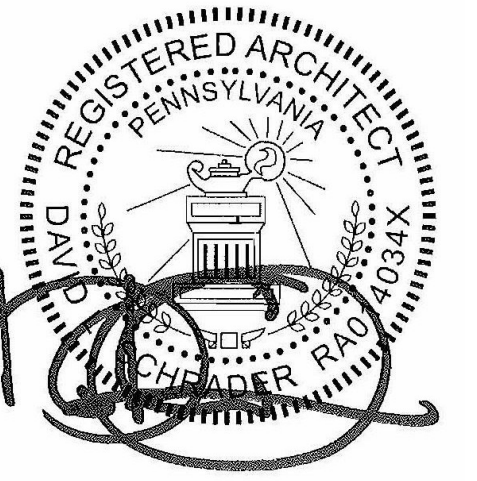


NAME (LICENSED PROFESSIONAL) STATE AND LICENSE NO. DATE
XX/XX/20XX

Architectural:

SCHRADERGROUP Architecture, LLC
Address: 161 Leverington Ave, Suite 105, Philadelphia, PA 19127
Phone: 215.482.7440
Fax: 215.482.7441
Email: bgood@sgarc.com
Attn: Brian Good

MEP:

Global Engineering Solutions
Address: 6700A Rockledge Drive, Suite #301, Bethesda, MD 20817
Phone: 301.216.2871
Fax: 301.216.9671
Email: AnilG@ges.com
Attn: Anil Giri

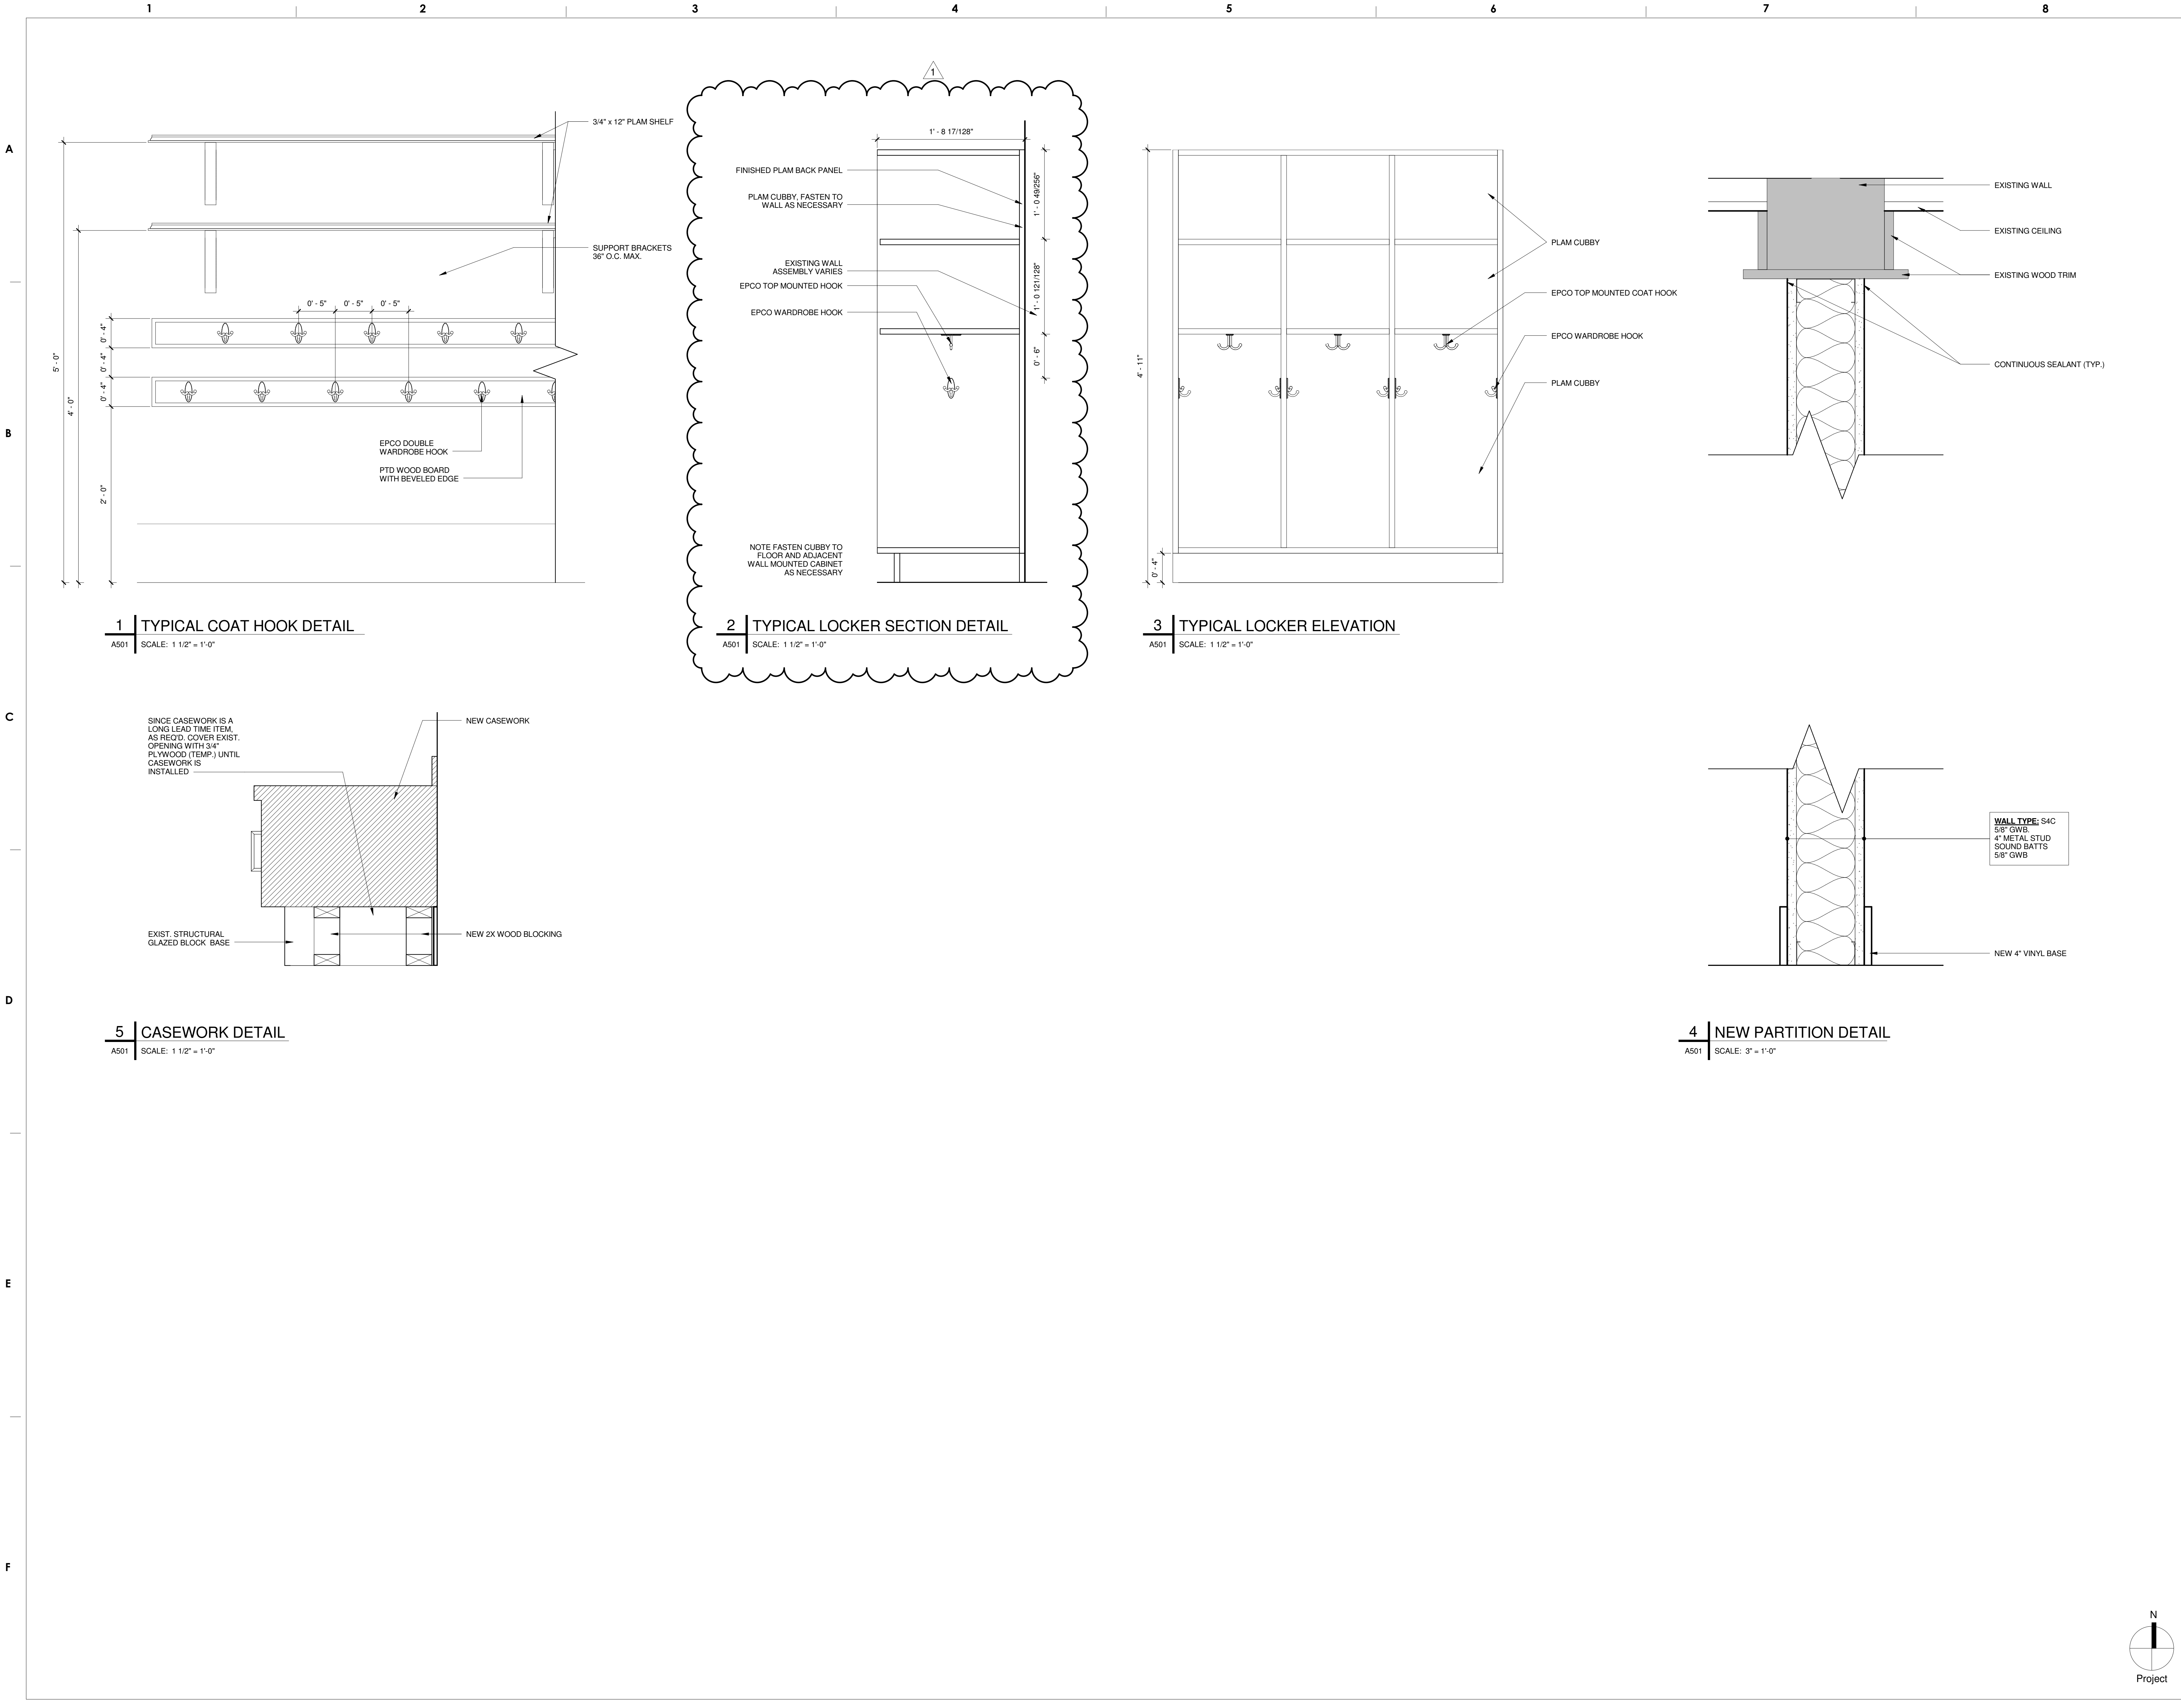

1 TYPICAL COAT HOOK DETAIL
A501 SCALE: 1 1/2" = 1'-0"

2 TYPICAL LOCKER SECTION DETAIL
A501 SCALE: 1 1/2" = 1'-0"

3 TYPICAL LOCKER ELEVATION
A501 SCALE: 1 1/2" = 1'-0"

4 NEW PARTITION DETAIL
A501 SCALE: 3" = 1'-0"

5 CASEWORK DETAIL
A501 SCALE: 1 1/2" = 1'-0"

BID DOCUMENTS
APRIL 20, 2018

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1	5/9/18	ADDENDUM #1
NO.	DATE	REVISION


SCHOOL & LOCATION
Edward T. Steel Elementary School
4301 Wayne Avenue, Philadelphia PA 19140

PROJECT TITLE
Classroom Modifications to Edward T. Steel Elementary School

DRAWING TITLE
DETAILS

LOCATION NO. XX-XXX	FILE NO.
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B-067 C OF 2017/18 B-070 C OF 2017/18	

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DOOR AND FRAME SCHEDULE

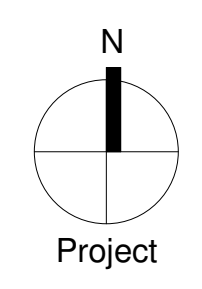
NO.	TYPE	DOOR				FRAME			GLAZING TYPE	FIRE RATING	HARDWARE SET	COMMENTS
		WIDTH	HEIGHT	THICKNESS	MATERIAL	FINISH	TYPE	MATERIAL				
105	EX	3'-0"	7'-0"	0'-1 3/4"	EX - Wood	EX	EX - HM	Paint	EX	-	PH-02 / NOTE 10	
105A	EX	6'-0"	7'-0"	0'-1 3/4"	EX - Wood	EX	EX - HM	Paint	EX	-	PH-03 / NOTE 10	
107	EX	3'-0"	7'-0"	0'-1 3/4"	EX - Wood	EX	EX - HM	Paint	EX	-	PH-02 / NOTE 10	
107A	EX	3'-0"	7'-0"	0'-1 3/4"	EX - Wood	EX	EX - HM	Paint	EX	-	PH-04 / NOTE 10	
107B	EX	3'-0"	7'-0"	0'-1 3/4"	EX - Wood	EX	EX - HM	Paint	EX	-	PH-03 / NOTE 10	
108	EX	3'-0"	7'-0"	0'-1 3/4"	EX - HM	EX	EX	EX	EX	-		
108A	EX	3'-0"	7'-0"	0'-1 3/4"	EX - Wood	EX	EX	EX	EX	-		
109	EX	3'-0"	7'-0"	0'-1 3/4"	EX - Wood	EX	EX - HM	Paint	EX	-	PH-02 / NOTE 10	
109A	EX	3'-0"	7'-0"	0'-1 3/4"	EX - Wood	EX	EX - HM	Paint	EX	-	PH-04 / NOTE 10	
111	EX	3'-0"	7'-0"	0'-1 3/4"	EX - Wood	EX	EX - HM	Paint	EX	-	PH-02 / NOTE 10	
111A	EX	3'-0"	7'-0"	0'-1 3/4"	EX - Wood	EX	EX - HM	Paint	EX	-	PH-04 / NOTE 10	
111B	EX	3'-0"	7'-0"	0'-1 3/4"	EX - Wood	EX	EX - HM	Paint	EX	-	PH-03 / NOTE 10	
113	EX	3'-0"	7'-0"	0'-1 3/4"	EX - Wood	EX	EX - HM	Paint	EX	-	PH-02 / NOTE 10	
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209	EX	3'-0"	7'-0"	0'-1 3/4"	EX - Wood	EX	EX - HM	Paint	EX	-	PH-02 / NOTE 10	
211	EX	3'-0"	7'-0"	0'-1 3/4"	EX - Wood	EX	EX - HM	Paint	EX	-	PH-02 / NOTE 10	

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DOOR NOTES

- ALL GLAZING IN FIRE RATED DOORS TO BE FIRE GLASS COMPLYING WITH ANSI IMPACT REQUIREMENTS.
- ALL CLOSERS TO HAVE CLOSING SPECS SET 90° - 120°, 5 SECONDS MIN.
- ALL DOOR LOCKS, LATCHES, PANIC HARDWARE AND PULLS TO BE SET 34"-48" AFF.
- ALL DOOR OPERATING DEVICES (OTHER THAN PANIC HARDWARE) TO BE LEVER OPERATED.
- ALL THRESHOLDS TO BE 1/2" MAX. HEIGHT, BEVELED TO 1:2 SLOPE.
- ALL GLASS IN DOORS AND WITHIN 24" OF A DOOR TO BE SAFETY TEMPERED GLASS (T).
- *SEE DOOR TYPES* DIMENSION NOTED IS FROM FINISHES FLOOR TO BOTTOM OF GLAZING.
- ALL DOOR HARDWARE TO BE MOUNTED A MINIMUM OF 34 INCHES ABOVE FINISHED FLOOR AND A MAXIMUM OF 48 INCHES ABOVE FINISHED FLOOR.
- ALL EXISTING DOOR/FRAME SIZED TO BE FIELD VERIFIED.
- EXISTING DOOR HINGES TO REMAIN.

SEAL:

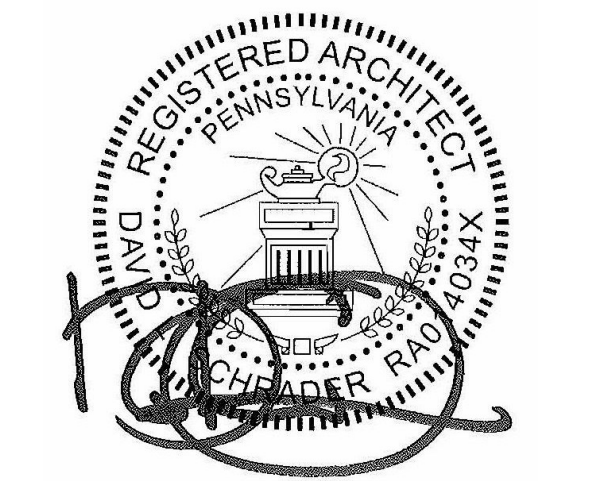

NAME (LICENSED PROFESSIONAL) DATE STATE AND LICENSE NO. XXXXX/20XX

Architectural:

SCHRADERGROUP Architecture, LLC Address: 161 Leverington Ave, Suite 105, Philadelphia, PA 19127 Phone: 215-482-7440 Fax: 215-482-7441 Email: bgood@sgarc.com Attn: Brian Good

MEP:

Global Engineering Solutions Address: 6700A Rockledge Drive, Suite #301, Bethesda, MD 20817 Phone: 301.216.2871 Fax: 301.216.9671 Email: anilg@ges.com Attn: Anil Giri

BID DOCUMENTS APRIL 20, 2018

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1	5/9/18	ADDENDUM #1
NO. DATE		REVISION

SCHOOL & LOCATION

Edward T. Steel Elementary School 4301 Wayne Avenue, Philadelphia PA 19140

PROJECT TITLE


Classroom Modifications to Edward T. Steel Elementary School

DRAWING TITLE

DOOR SCHEDULE

LOCATION NO. XX-XXX	FILE NO.
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B-067 C OF 2017/18	B-070 C OF 2017/18

DRAWING NO. A601

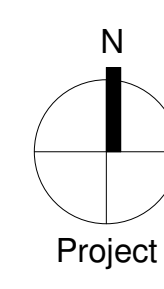

SEAL:

Architectural:
SCHRADERGROUP Architecture, LLC
Address: 161 Leverington Ave, Suite 105, Philadelphia PA 19127
Phone: 215.482.7440
Fax: 215.482.7441
Email: bgoode@sgarc.com
Attn: Brian Good

MEP:

GES
Global Engineering Solutions®
Address: 6700A Rockledge Drive, Suite 301
Bethesda Maryland 20817
Phone: 301.216.9271
Fax: 301.216.9671
Email: arnig@thesgs.com
Attn: Arni Gai

BID DOCUMENTS
APRIL 20, 2018

NO.	DATE	REVISION
1	05/09/18	ADDENDUM 1

SCHOOL & LOCATION

Edward T. Steel Elementary School
4301 Wayne Avenue, Philadelphia, PA 19140

PROJECT TITLE

Classroom Modifications to Edward T. Steel Elementary School

DRAWING TITLE

ELECTRICAL COVER SHEET


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B-070 C	OF 2017/18

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E001

ELECTRICAL LEGEND

SHEET NAMING LEGEND

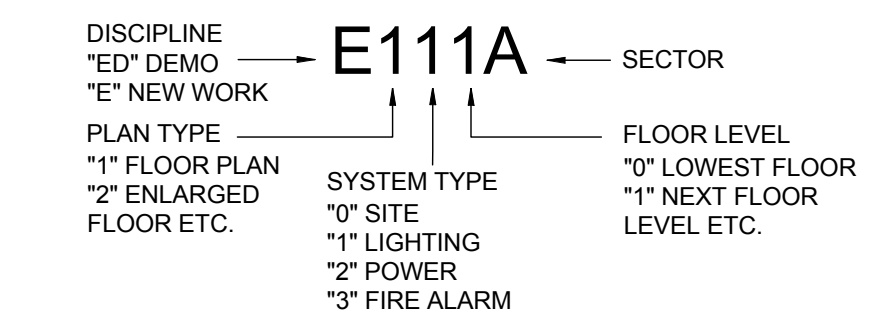

ELECTRICAL LEGEND

SPECIAL SYSTEMS

- # DATA OUTLET, #N INDICATES # OF DATA PORTS IF MORE THAN ONE PORT. PROVIDE PLENUM RATED CAT6 CABLE IN 3/4" EMT C, UNLESS OTHERWISE NOTED. REFER TO SPECIFICATION FOR ADDITIONAL INFORMATION.
- ▽ DATA OUTLET, PROVIDE PLENUM RATED CAT6 CABLE IN 3/4" EMT C, UNLESS OTHERWISE NOTED.
- ▽ TELEPHONE OUTLET.
- AV WALL MOUNTED AUDIO/VISUAL OUTLET.
- S CEILING MOUNTED SPEAKER.
- S WALL MOUNTED SPEAKER.
- W WIRELESS CLOCK BATTERY OPERATED, SEE SPECIFICATION 275313.
- C W WIRELESS CLOCK SYSTEM OUTLET.
- WAP WIRELESS ACCESS POINT.

ELECTRICAL LEGEND

LIGHTING

- NOTE: REFER TO LIGHTING FIXTURE SCHEDULE FOR FIXTURE TYPES.
- A: CAPITAL LETTER ADJACENT TO FIXTURE INDICATES TYPE.
 - a: LOWER CASE LETTER INDICATES SWITCHING.
 - NL: INDICATES NIGHT LIGHTING - UNSWITCHED FIXTURE.
 - SHADED CIRCLE INDICATES FIXTURE ON EMERGENCY CIRCUIT.
 - 2X4' FLUORESCENTLED LIGHT FIXTURE - SURFACE OR RECESSED.
 - 1X4' FLUORESCENTLED LIGHT FIXTURE - SURFACE/RECESSED/PENDANT.
 - SQUARE DOWNLIGHT FIXTURE - SURFACE OR RECESSED.
 - CIRCULAR DOWN LIGHT FIXTURE - RECESSED.
 - ⊕ EMERGENCY BATTERY PACK LIGHT FIXTURE.
 - ⊕ CEILING/WALL MOUNTED EXIT SIGN - SINGLE FACE, PROVIDE DIRECTIONAL ARROWS PER PLANS.
 - ⊕ CEILING/WALL MOUNTED EXIT SIGN - DOUBLE FACE, PROVIDE DIRECTIONAL ARROWS PER PLANS.
 - S 20A, 1P, 120/277V TOGGLE TYPE LIGHT SWITCH.
 - S₃ 20A, 3-WAY, 120/277V TOGGLE TYPE LIGHT SWITCH.
 - DS DIMMER SWITCH, NUMBER INDICATES WATTAGE.
 - OS CEILING MOUNTED DUAL TECHNOLOGY OCCUPANCY SENSOR, SIMILAR TO LUTRON MODEL # LOS-CDT-1000-WH OR APPROVED EQUAL.
 - PP POWER PACK SIMILAR TO LUTRON MODEL #PP-DV OR AN APPROVED EQUAL.

POWER

- NOTES: REFER TO ARCHITECTURAL DRAWINGS AND ELEVATIONS FOR EXACT LOCATION AND MOUNTING HEIGHTS.
- WP: WEATHER PROOF (NEMA 3R)
 - IG: ISOLATED GROUND.
 - GFI: GROUND FAULT INTERRUPTER.
 - GFCI: GROUND FAULT CIRCUIT INTERRUPTER.
 - ⊕ WALL MOUNTED 20A SINGLE RECEPTACLE (18" AFF UON).
 - ⊕ WALL MOUNTED 20A DUPLEX RECEPTACLE (18" AFF UON).
 - ⊕ WALL 20A QUADRUPLEX RECEPTACLE (18" AFF UON).
 - ⊕ WALL MOUNTED 20A SINGLE TAMPER RESISTANT RECEPTACLE (18" AFF UON).
 - ⊕ WALL MOUNTED 20A DUPLEX TAMPER RESITANT RECEPTACLE (18" AFF UON).
 - ⊕ WALL 20A QUADRUPLEX TAMPER RESISTANT RECEPTACLE (18" AFF UON).
 - ⊕ FLOOR MOUNTED 20A DUPLEX TAMPER RESISTANT RECEPTACLE.
 - ⊕ CEILING MOUNTED 20A SIMPLEX RECEPTACLE.
 - ⊕ CEILING MOUNTED 20A DUPLEX RECEPTACLE.
 - ⊕ CEILING MOUNTED QUADRUPLEX RECEPTACLE.
 - ⊕ FLOOR MOUNTED 20A SIMPLEX RECEPTACLE.
 - ⊕ FLOOR MOUNTED 20A DUPLEX RECEPTACLE.
 - ⊕ FLOOR MOUNTED 20A QUADRUPLEX RECEPTACLE.
 - ⊕ CEILING MOUNTED JUNCTION BOX.
 - ⊕ WALL MOUNTED JUNCTION BOX.
 - DISCONNECT SWITCH - NON-FUSED.
 - SURFACE MOUNTED PANEL.
 - RECESSED PANEL.

ELECTRICAL LEGEND

DEMOLITION

- NOTE: REFER TO DEMOLITION DRAWINGS & NOTES FOR REQUIREMENTS.
- R: EXISTING TO BE REMOVED.
 - E: EXISTING TO REMAIN.
 - ER: EXISTING TO BE RELOCATED.
 - RE: RELOCATED EXISTING DEVICE IN NEW LOCATION.
 - ITEMS SHOWN DASHED INDICATE EXISTING TO BE REMOVED.
 - LIGHT LINES INDICATE EXISTING TO REMAIN.

ABBREVIATIONS

A, AMP AMPERES	G, GND GROUND
AB ABOVE	GC GENERAL CONTRACTOR
AC ALTERNATE CURRENT	GFI GROUND FAULT INTERRUPTER
AFF ABOVE FINISHED FLOOR	IG ISOLATED GROUND
ARCH ARCHITECTURAL, ARCHITECT	INCAND INCANDESCENT
BEL BELOW	KAIC KILOAMP INTERRUPTING CURRENT
BKR BREAKER	KVA KILOVOLT AMPERES
C CONDUIT	KW KILOWATTS
CEIL CEILING	L(T)S LIGHT(S)
CKT CIRCUIT	M METER
CM CENTIMETER	MECH MECHANICAL
DC DIRECT CURRENT	MH MOUNTING HEIGHT
D/S DISCONNECT SWITCH	MLO MAIN LUGS ONLY
DISC DISCONNECT SWITCH	MM MILLIMETER
DWG DRAWING	MTD MOUNTED
EC ELECTRICAL CONTRACTOR	NEC NATIONAL ELECTRICAL CODE
EF EXHAUST FAN	NO.# NUMBER
ELEC ELECTRICAL	NTS NOT TO SCALE
EM EMERGENCY	P POLE
EQUIP EQUIPMENT	PH, ∅ PHASE
EXIST EXISTING	PNL PANEL
FA FIRE ALARM	RECEP RECEPTACLE
FACP FIRE ALARM CONTROL PANEL	RM ROOM
FAAP FIRE ALARM ANNUNCIATOR PANEL	TELE TELEPHONE
FXT FIXTURE	TYP TYPICAL
FLA FULL LOAD AMPERES	UON UNLESS OTHERWISE NOTED
FLOOR FLUORESCENT	V VOLTS
	W WATTS
	W/ WITH
	WP WEATHERPROOF

GENERAL

- ⊕ INDICATES PLAN NOTE.
- ⊕ INDICATES REVISION. CLOUDED AREA CONTAINS THE REVISION.
- # INDICATES ROOM NUMBER.
- BRANCH CIRCUIT HOMERUN
- CONDUIT UP
- CONDUIT DOWN
- GROUND

ELECTRICAL NOTES

DEMOLITION NOTES

- WHERE EXISTING FACILITIES ARE BEING ALTERED, DISCONNECT AND REMOVE OR RELOCATE AND EXTEND ALL EXISTING ELECTRICAL WORK THAT INTERFERES WITH OR IS NECESSARY DUE TO SCOPE OF RENOVATION AS SPECIFIED. SHOW OR REQUIRED CONTRACTOR TO RELOCATE ANY CONDUIT IN THE WAY OF NEW CONSTRUCTION.
- WHERE SPECIFIED OR REQUIRED, EXTEND EXISTING SYSTEMS OR TIE INTO SAME TO PROVIDE A COMPLETE COORDINATED ELECTRICAL SYSTEM TO SATISFACTION OF OWNER AND ENGINEER.
- ALL EXISTING WORK TO REMAIN ACTIVE, BUT DISTURBED OR DISCONNECT DUE TO ALTERATIONS PER THIS RENOVATION SHALL BE REPLACED AND PUT IN OPERATING CONDITION AS REQUIRED TO MAINTAIN CONTINUITY UNLESS INSTRUCTED OTHERWISE IN WRITING BY OWNER OR ENGINEER.
- ALL DISCONNECTED OR ABANDONED WIRE, CABLE AND SURFACE CONDUIT OR RACEWAYS WITHIN THIS CONTRACT SHALL BE REMOVED.
- ALL EXISTING BUILDING MATERIALS DAMAGED DURING RENOVATIONS SHALL BE REPAIRED AND REPLACED BY THE CONTRACTOR. THIS SHALL INCLUDE, BUT IS NOT LIMITED TO CEILING TILES, GRIDS, FLOORING, PARTITIONS AND SIMILAR BUILDING ELEMENTS. ALL DAMAGES TO EXISTING ELEMENTS SHALL BE REPAIRED TO A QUALITY AND FINISH LEVEL OF ADJACENT AREAS/SURFACES AND SUBJECT TO THE APPROVAL OF OWNER AND ENGINEER.
- PROVIDE PHYSICAL AND DUST PROTECTION OF OWNERS EQUIPMENT, FURNITURE AND FLOORING DURING RENOVATION. EQUIPMENT PROTECTION SHALL BE INSTALLED AND REMOVED ON A DAILY BASIS AS DIRECTED BY OWNER.
- ALL ELECTRICAL WORK DAMAGED DURING RENOVATION SHALL BE REPAIRED AND REPLACED BY THE CONTRACTOR. THIS SHALL INCLUDE, BUT NOT LIMITED TO, RACEWAYS, WIREWAYS, BACKBOXES, LIGHTING FIXTURES, LAMPS, WIRING DEVICES AND SIMILAR ELECTRICAL EQUIPMENT. ALL DAMAGE SHALL BE REPAIRED TO A QUALITY LEVEL SUBJECT TO APPLICABLE CODE AND APPROVAL OF OWNER AND ENGINEER.
- PROVIDE A FINISH GRADE COVERPLATE FOR ALL WALL AND FLOOR BOX DEVICES TO BE REMOVED.
- EXISTING CONDUIT WIREWAYS AND BACKBOXES (IF IT IS AT CODE APPROVED HEIGHT) MAY BE REUSED, WHERE NOTED THE CONTRACTOR SHALL FIELD VERIFY CONDUIT AND BOX SUITABILITY. PROVIDE NEW AS REQUIRED BY ACTUAL FIELD CONDITIONS.
- PROVIDE TOUCH-UP PAINT AND FINISH PAINTING AS REQUIRED IN AREAS AFFECTED BY REMOVAL OF EXISTING EQUIPMENT OR INSTALLATION OF NEW. FINISH AND QUALITY LEVEL SHALL MATCH ADJACENT AREAS AND BE SUBJECT TO APPROVAL OF OWNER AND ENGINEER.
- PERFORM ALTERATIONS AND CONNECTION TO EXISTING FACILITIES WITH A MINIMUM INTERRUPTION. WHERE INTERRUPTION IS REQUIRED, PREPARE A TIME SCHEDULE AND DURATION, COORDINATE AND OBTAIN WRITTEN APPROVAL FROM PRINCIPAL AND OWNER (SDP). PROVIDE AND PLACE NOTICES IN AFFECTED AREAS AND ON FIXTURES OR EQUIPMENT WHICH WILL BE TEMPORARILY OUT OF USE. REMOVE NOTICES WHEN INTERRUPTION IS COMPLETE.
- DISCONNECT AND REMOVE ALL EXISTING SWITCHES AND LIGHT FIXTURES. REMOVE EXISTING LIGHT FIXTURE CONTROL WIRING WITHIN THE ROOM. KEEP EXISTING LIGHTING CIRCUITS FOR REUSE AND CONNECTION FOR NEW LIGHTING FIXTURES WIRING.
- DURING RENOVATION PROVIDE ALL TEMPORARY LIGHTING AND POWER AS REQUIRED. COORDINATE WITH ALL OTHER TRADES FOR TEMPORARY POWER REQUIREMENTS.
- ALL DEMOLITION/REMOVAL SHALL BE PERFORMED IN A NEAT, WORKMANLIKE MANNER WITH GREAT EMPHASIS ON MINIMIZING COLLATERAL DAMAGE.
- THE CONTRACTOR SHALL BE RESPONSIBLE FOR THE REMOVAL OF ALL DEMOLISHED MATERIALS FROM THE SITE AND DISPOSAL THEREOF, UNLESS SPECIFICALLY NOTED OTHERWISE.
- IT IS INTENDED THAT ALL SURFACE BOXES, CONDUIT AND CABLES BE REMOVED. ALL WIRING TO BE REMOVED. BOXES AND CONDUIT EMBEDDED IN CONCRETE OR WALLS MAY REMAIN. CONDUIT TO BE CUT AT WALL BOUNDARY. BOXES TO BE COVERED WITH A STAINLESS STEEL BLANK COVER.

CODES

- PENNSYLVANIA UNIFORM CONSTRUCTION CODE (PA UCC)
- PHILADELPHIA EXISTING BUILDING CODE (2009)
- INTERNATIONAL BUILDING CODE (IBC 2003)
- PHILADELPHIA ENERGY CONSERVATION CODE
- PHILADELPHIA FIRE CODE
- PHILADELPHIA ELECTRICAL CODE
- PHILADELPHIA PERFORMANCE CODE
- PENNSYLVANIA DEPARTMENT OF EDUCATION REGULATION

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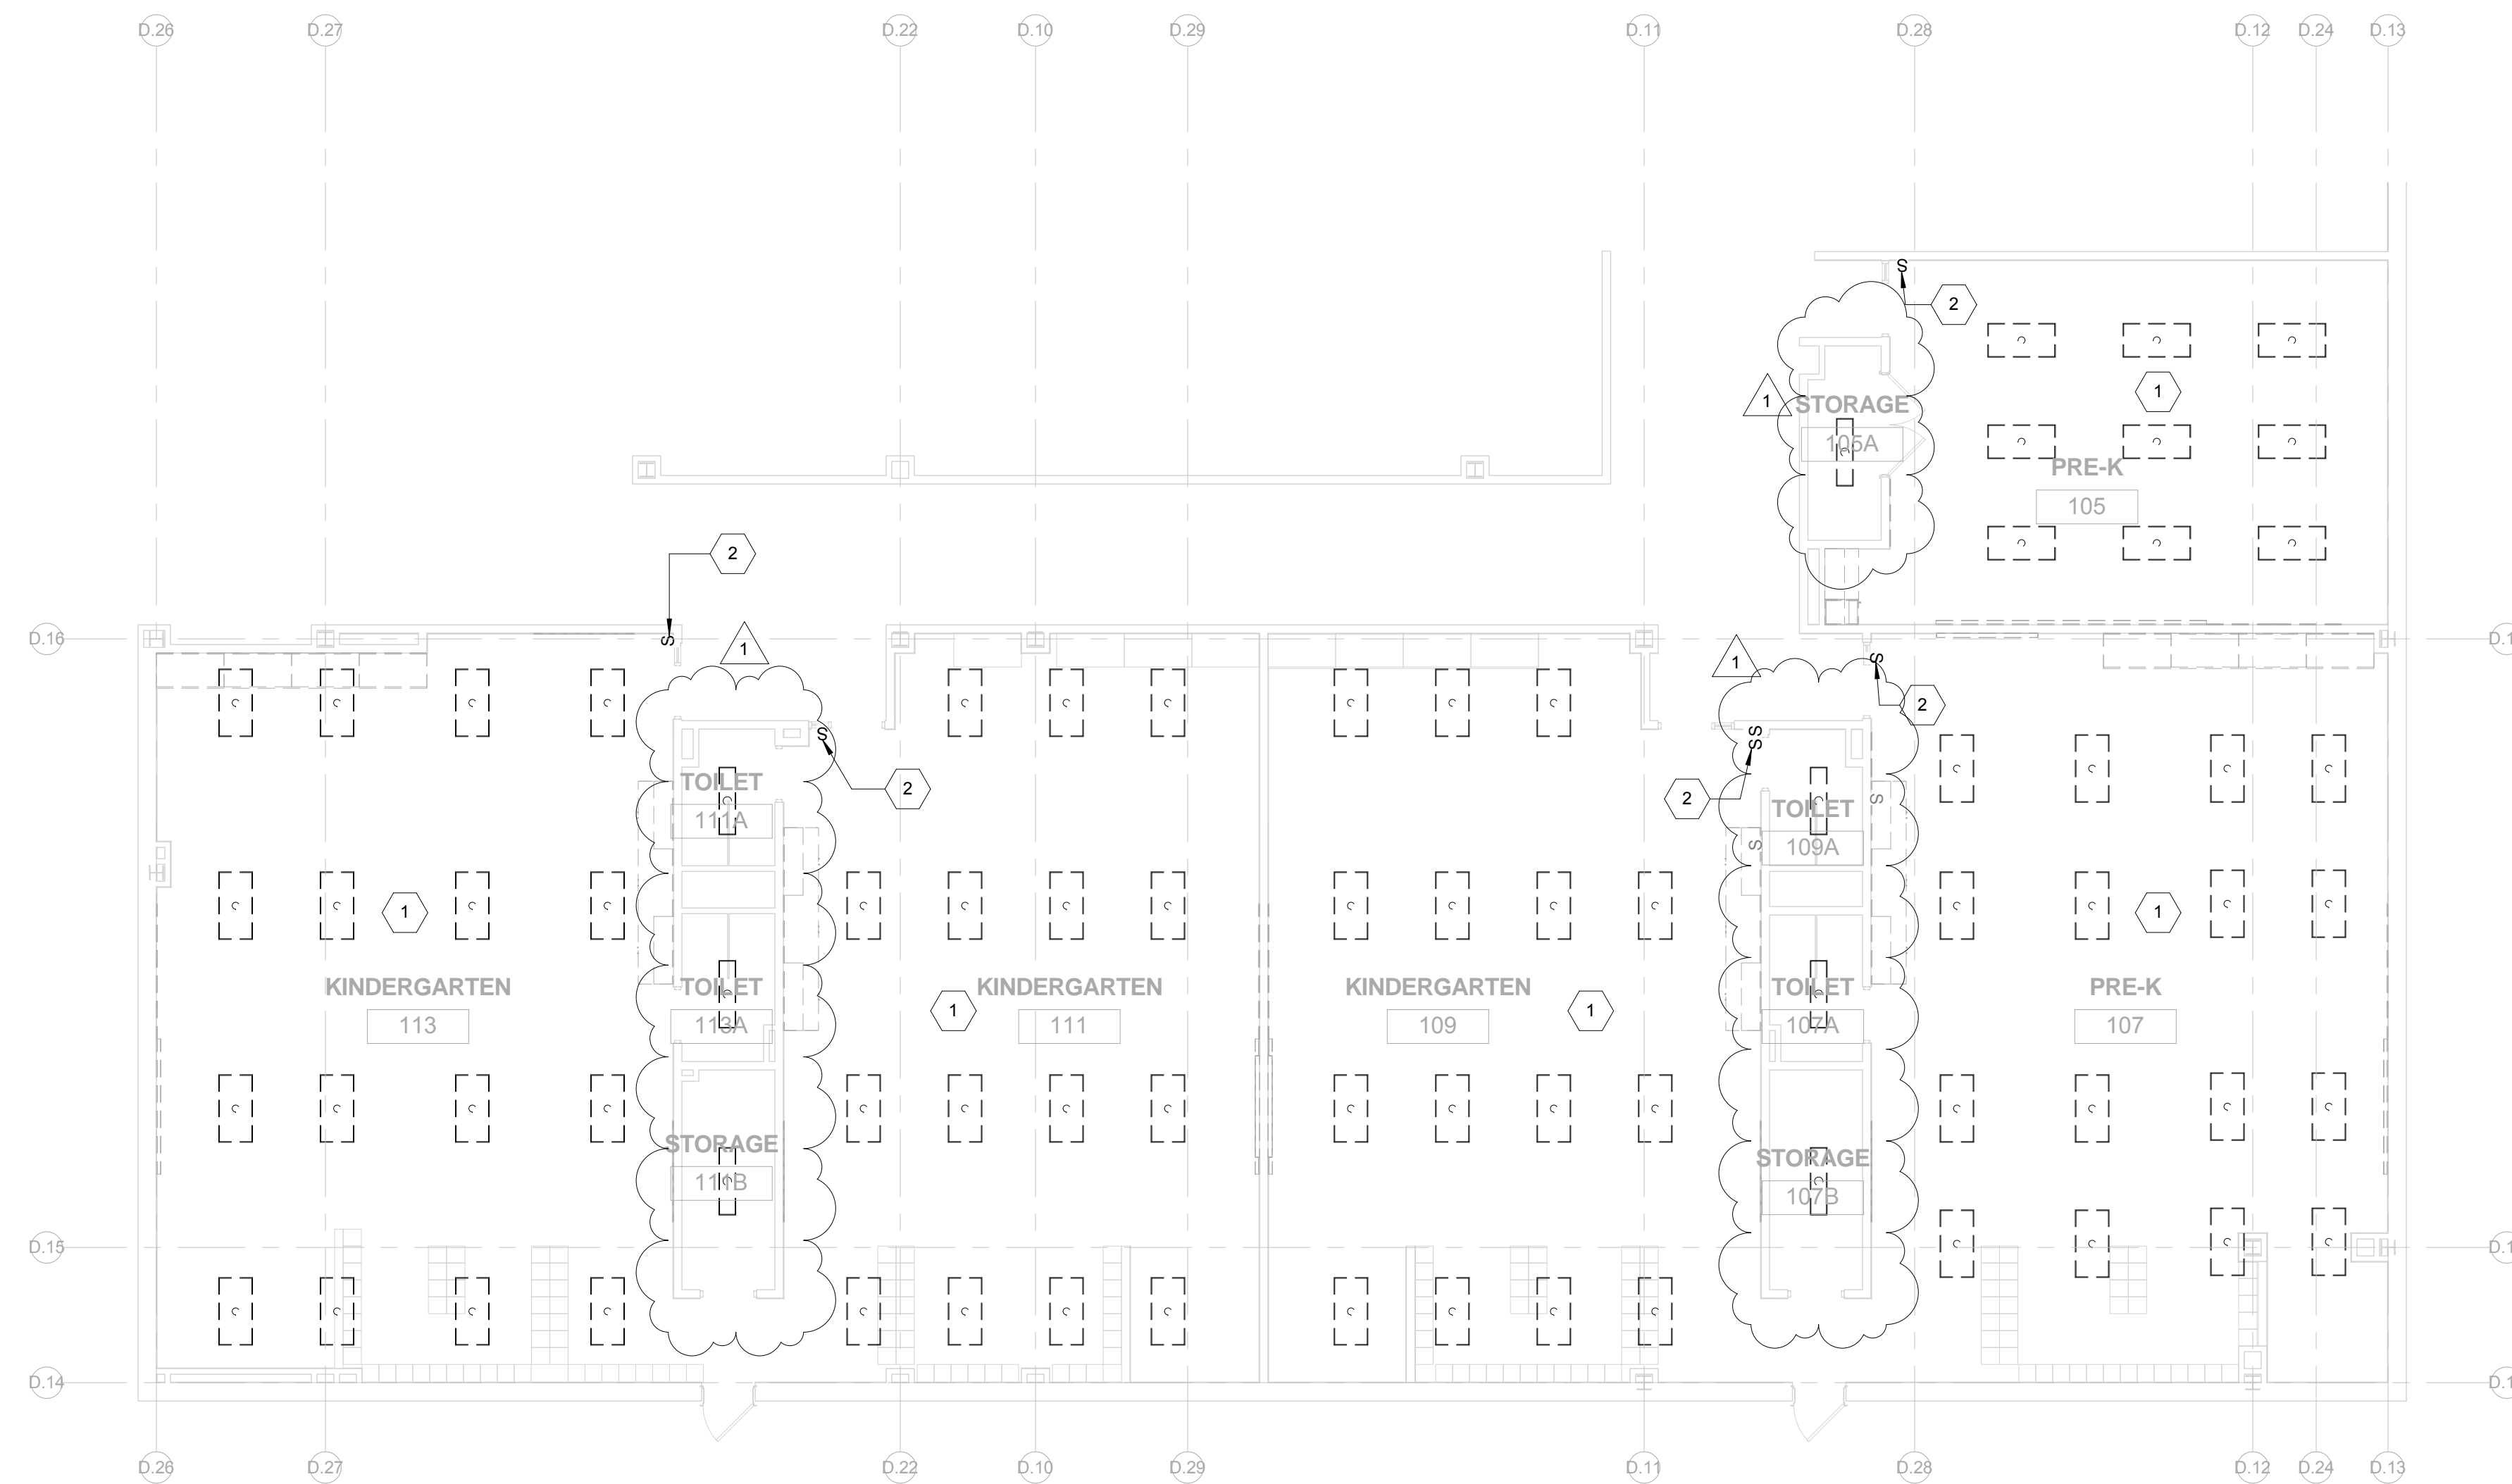
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FIRST LEVEL - LIGHTING FLOOR PLAN - DEMOLITION - CLASSROOMS 201, 202, 203, 204, 205, 206, 207, 209, AND 211
 1/8" = 1'-0"

GENERAL NOTES

1. REFER TO E001 FOR GENERAL NOTES, SYMBOL LEGEND AND LIST OF ABBREVIATIONS.

KEYED NOTES

- 1. DISCONNECT AND REMOVE ALL EXISTING LIGHT FIXTURE. EXISTING LIGHTING CIRCUIT TO REMAIN.
- 2. DISCONNECT AND REMOVE ALL EXISTING LIGHT SWITCH WITH COVER PLATE. EXISTING CIRCUIT TO REMAIN. PROVIDE NEW DIMMER SWITCHES IN ITS PLACE WITH COVER PLATE, AND RECONNECT TO EXISTING LIGHTING CIRCUIT.

SEAL:

Architectural:
 SCHRADERGROUP Architecture, LLC
 Address: 161 Leverington Ave, Suite 105, Philadelphia PA 19127
 Phone: 215.482.7440
 Fax: 215.482.7441
 Email: bgoo@grarc.com
 Attn: Brian Good

MEP:
 GES
 Global Engineering Solutions®
 Address: 6700A Rockledge Drive, Suite 301
 Bethesda Maryland 20817
 Phone: 301.216.2871
 Fax: 301.216.9671
 Email: amig@thejges.com
 Attn: Ami Gil

BID DOCUMENTS
 APRIL 20, 2018

NO.	DATE	REVISION
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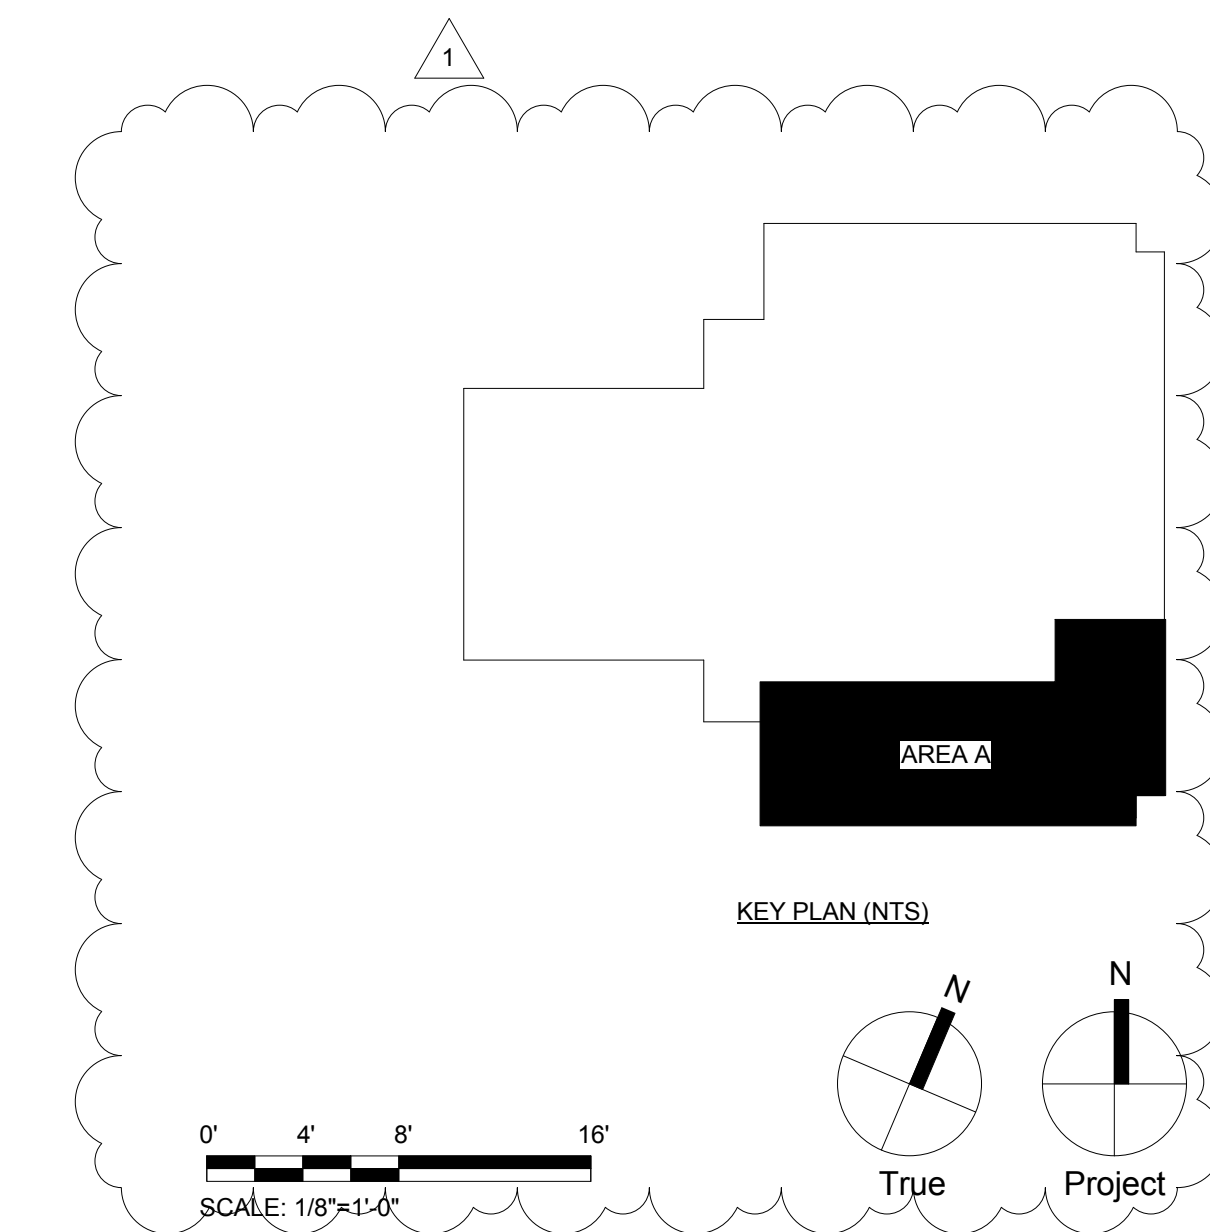
SCHOOL & LOCATION
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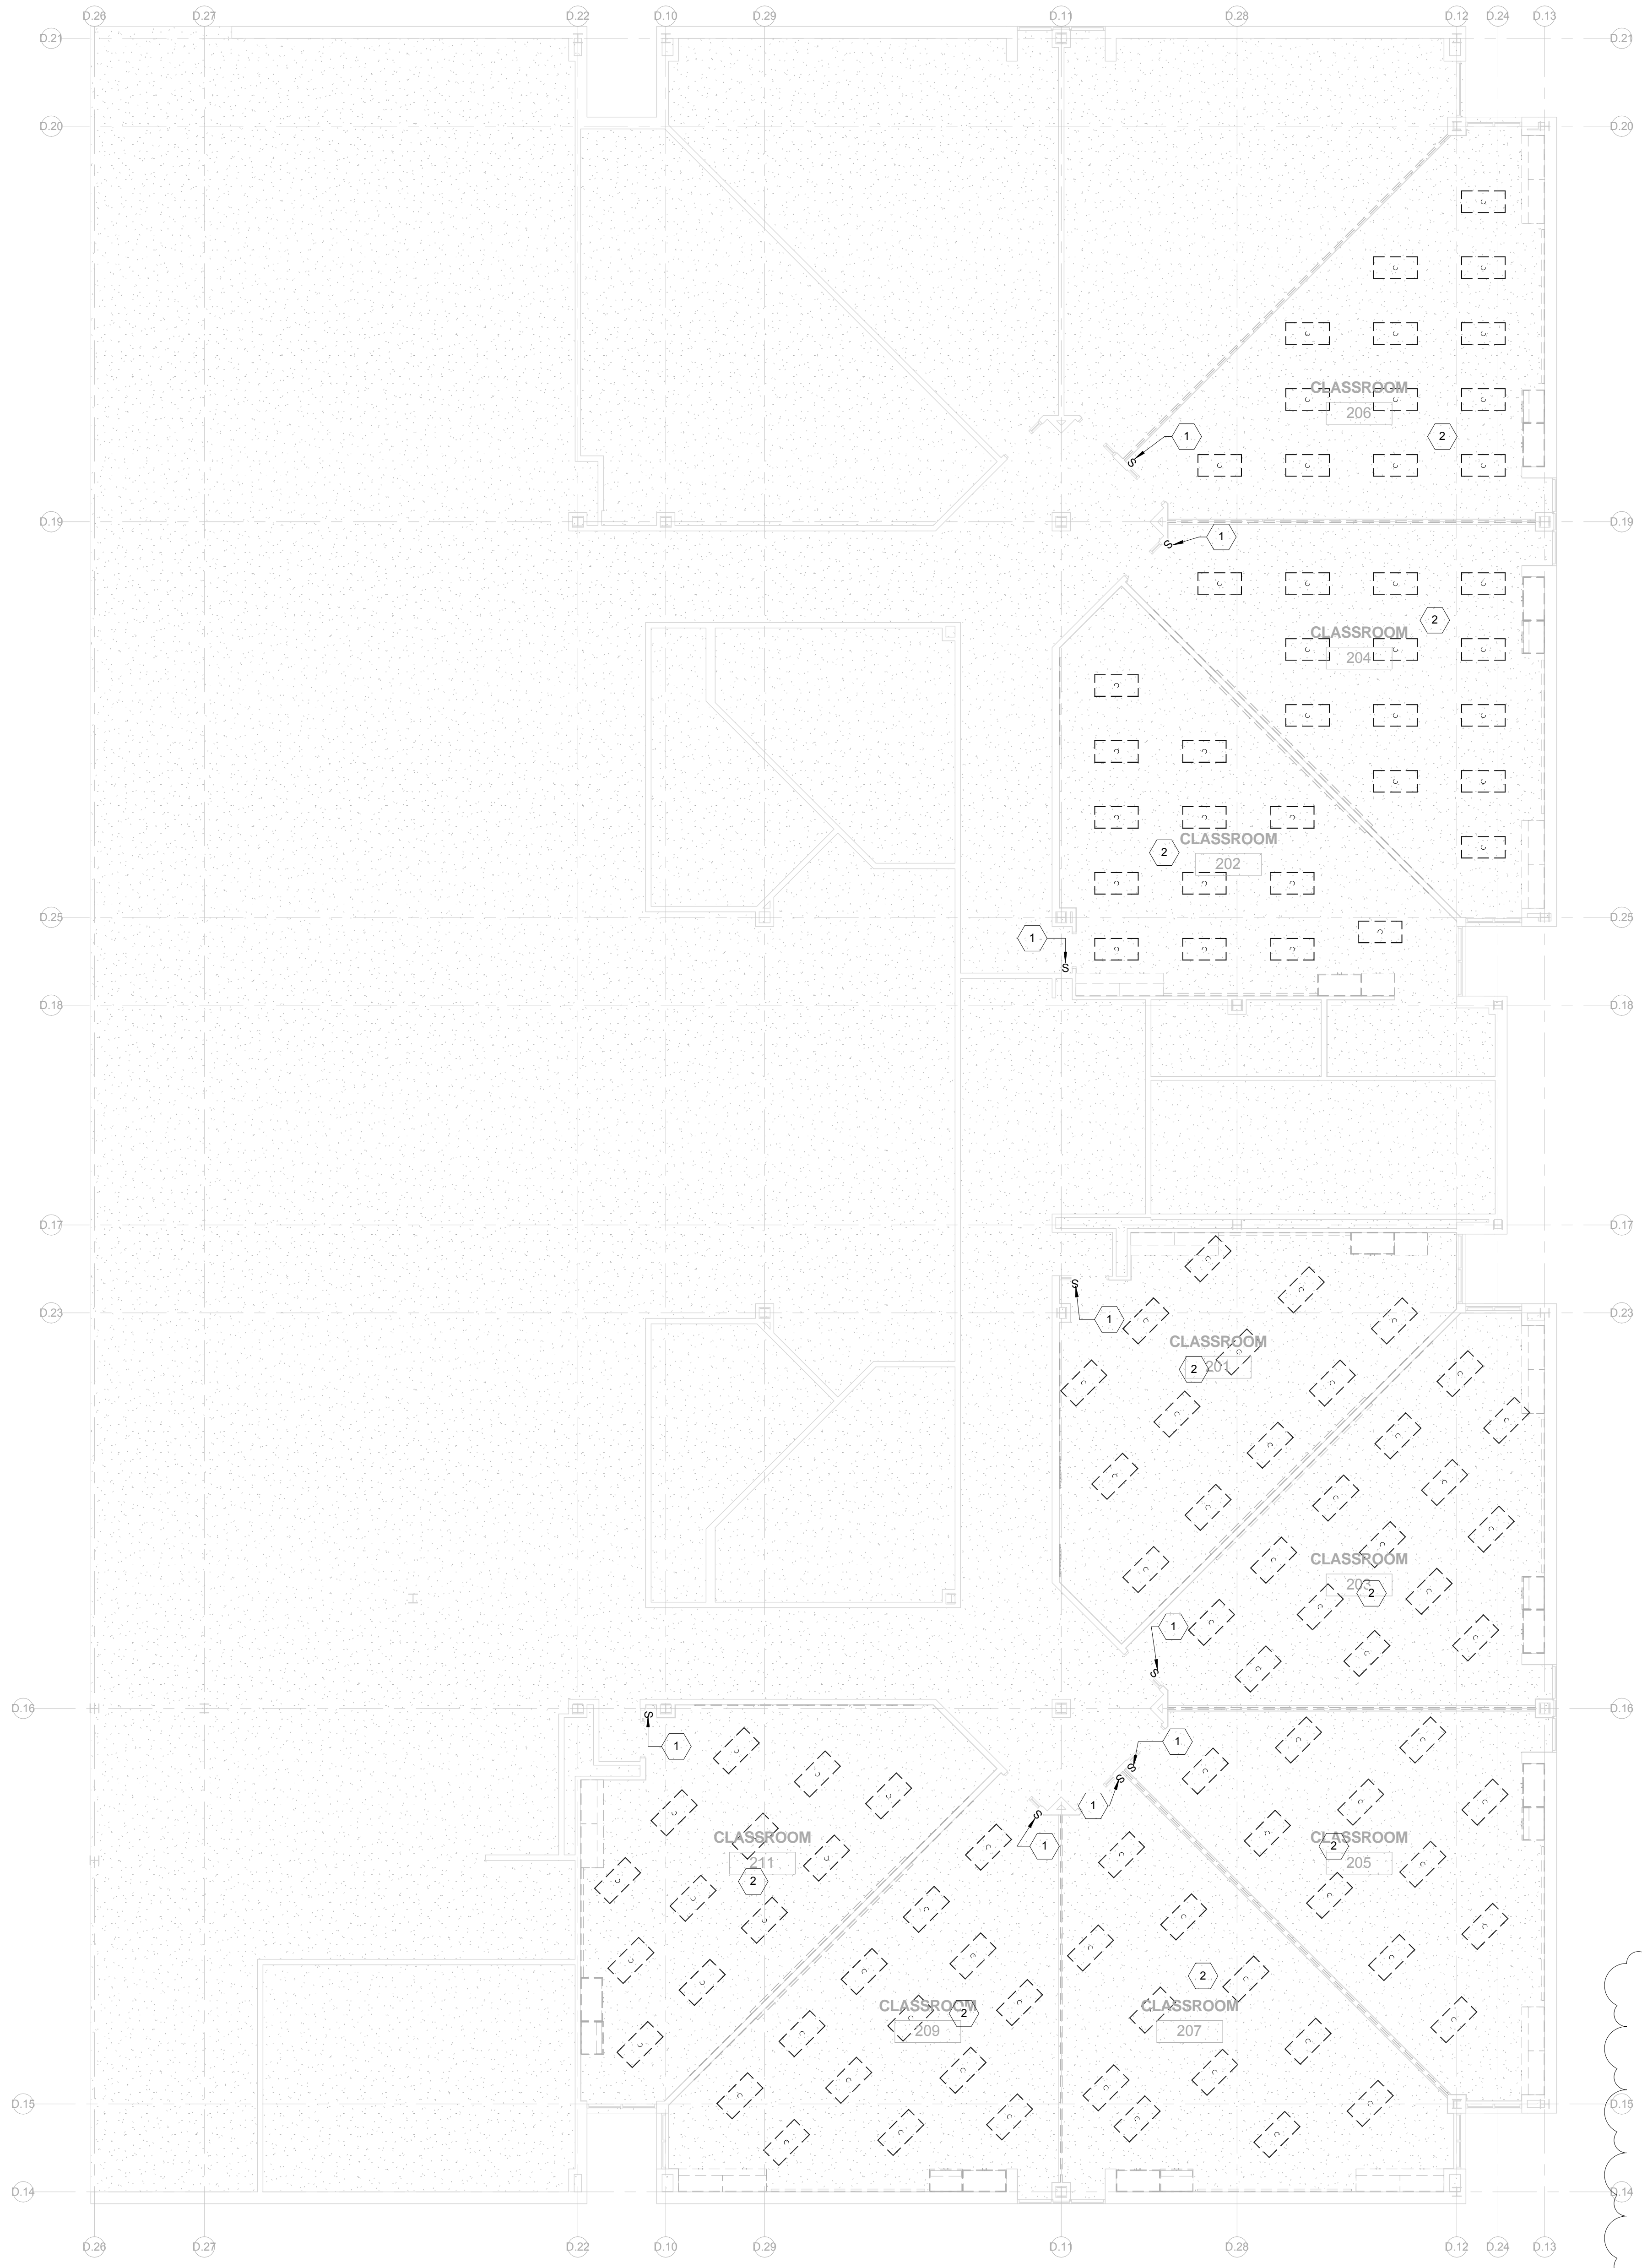
PROJECT TITLE
 Classroom Modifications to Edward T. Steel Elementary School

DRAWING TITLE
 FIRST LEVEL - LIGHTING FLOOR PLAN - DEMO

LOCATION NO.	FILE NO.
XX-XXX	
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Author	Checker
B-067 C	OF 2017/18
B-070 C	OF 2017/18

DRAWING NO.
 ED111





GENERAL NOTES

- REFER TO E001 FOR GENERAL NOTES, SYMBOL LEGEND AND LIST OF ABBREVIATIONS.

KEYED NOTES

- DISCONNECT AND REMOVE ALL EXISTING LIGHT SWITCH WITH COVER PLATE, EXISTING CIRCUIT TO REMAIN. PROVIDE NEW DIMMER SWITCHES IN ITS PLACE WITH COVER PLATE, AND RECONNECT TO EXISTING LIGHTING CIRCUIT.
- DISCONNECT AND REMOVE ALL EXISTING LIGHT FIXTURE. EXISTING LIGHTING CIRCUIT TO REMAIN.

SEAL:

Architectural:
SCHRADERGROUP Architecture, LLC
Address: 161 Leverington Ave, Suite 105, Philadelphia PA 19127
Phone: 215.482.7440
Fax: 215.482.7441
Email: bgoon@srarc.com
Attn: Brian Good

MEP:
GES
Global Engineering Solutions®
Address: 6700A Rockledge Drive, Suite 301
Bethesda Maryland 20817
Phone: 301.216.2871
Fax: 301.216.9671
Email: arily@thejes.com
Attn: Aril Gil

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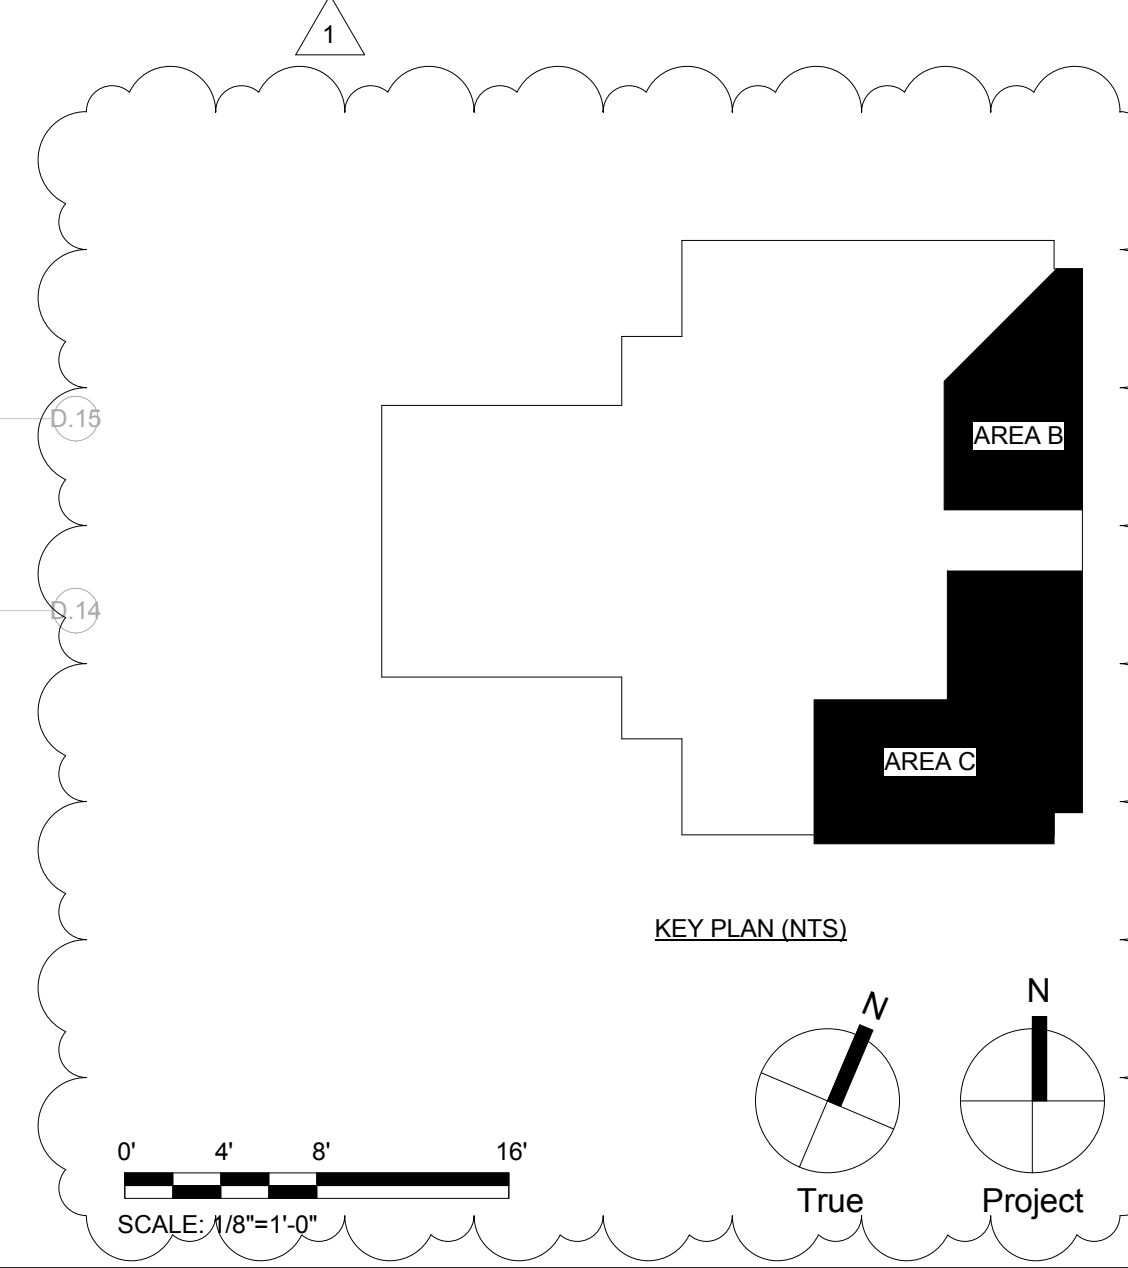
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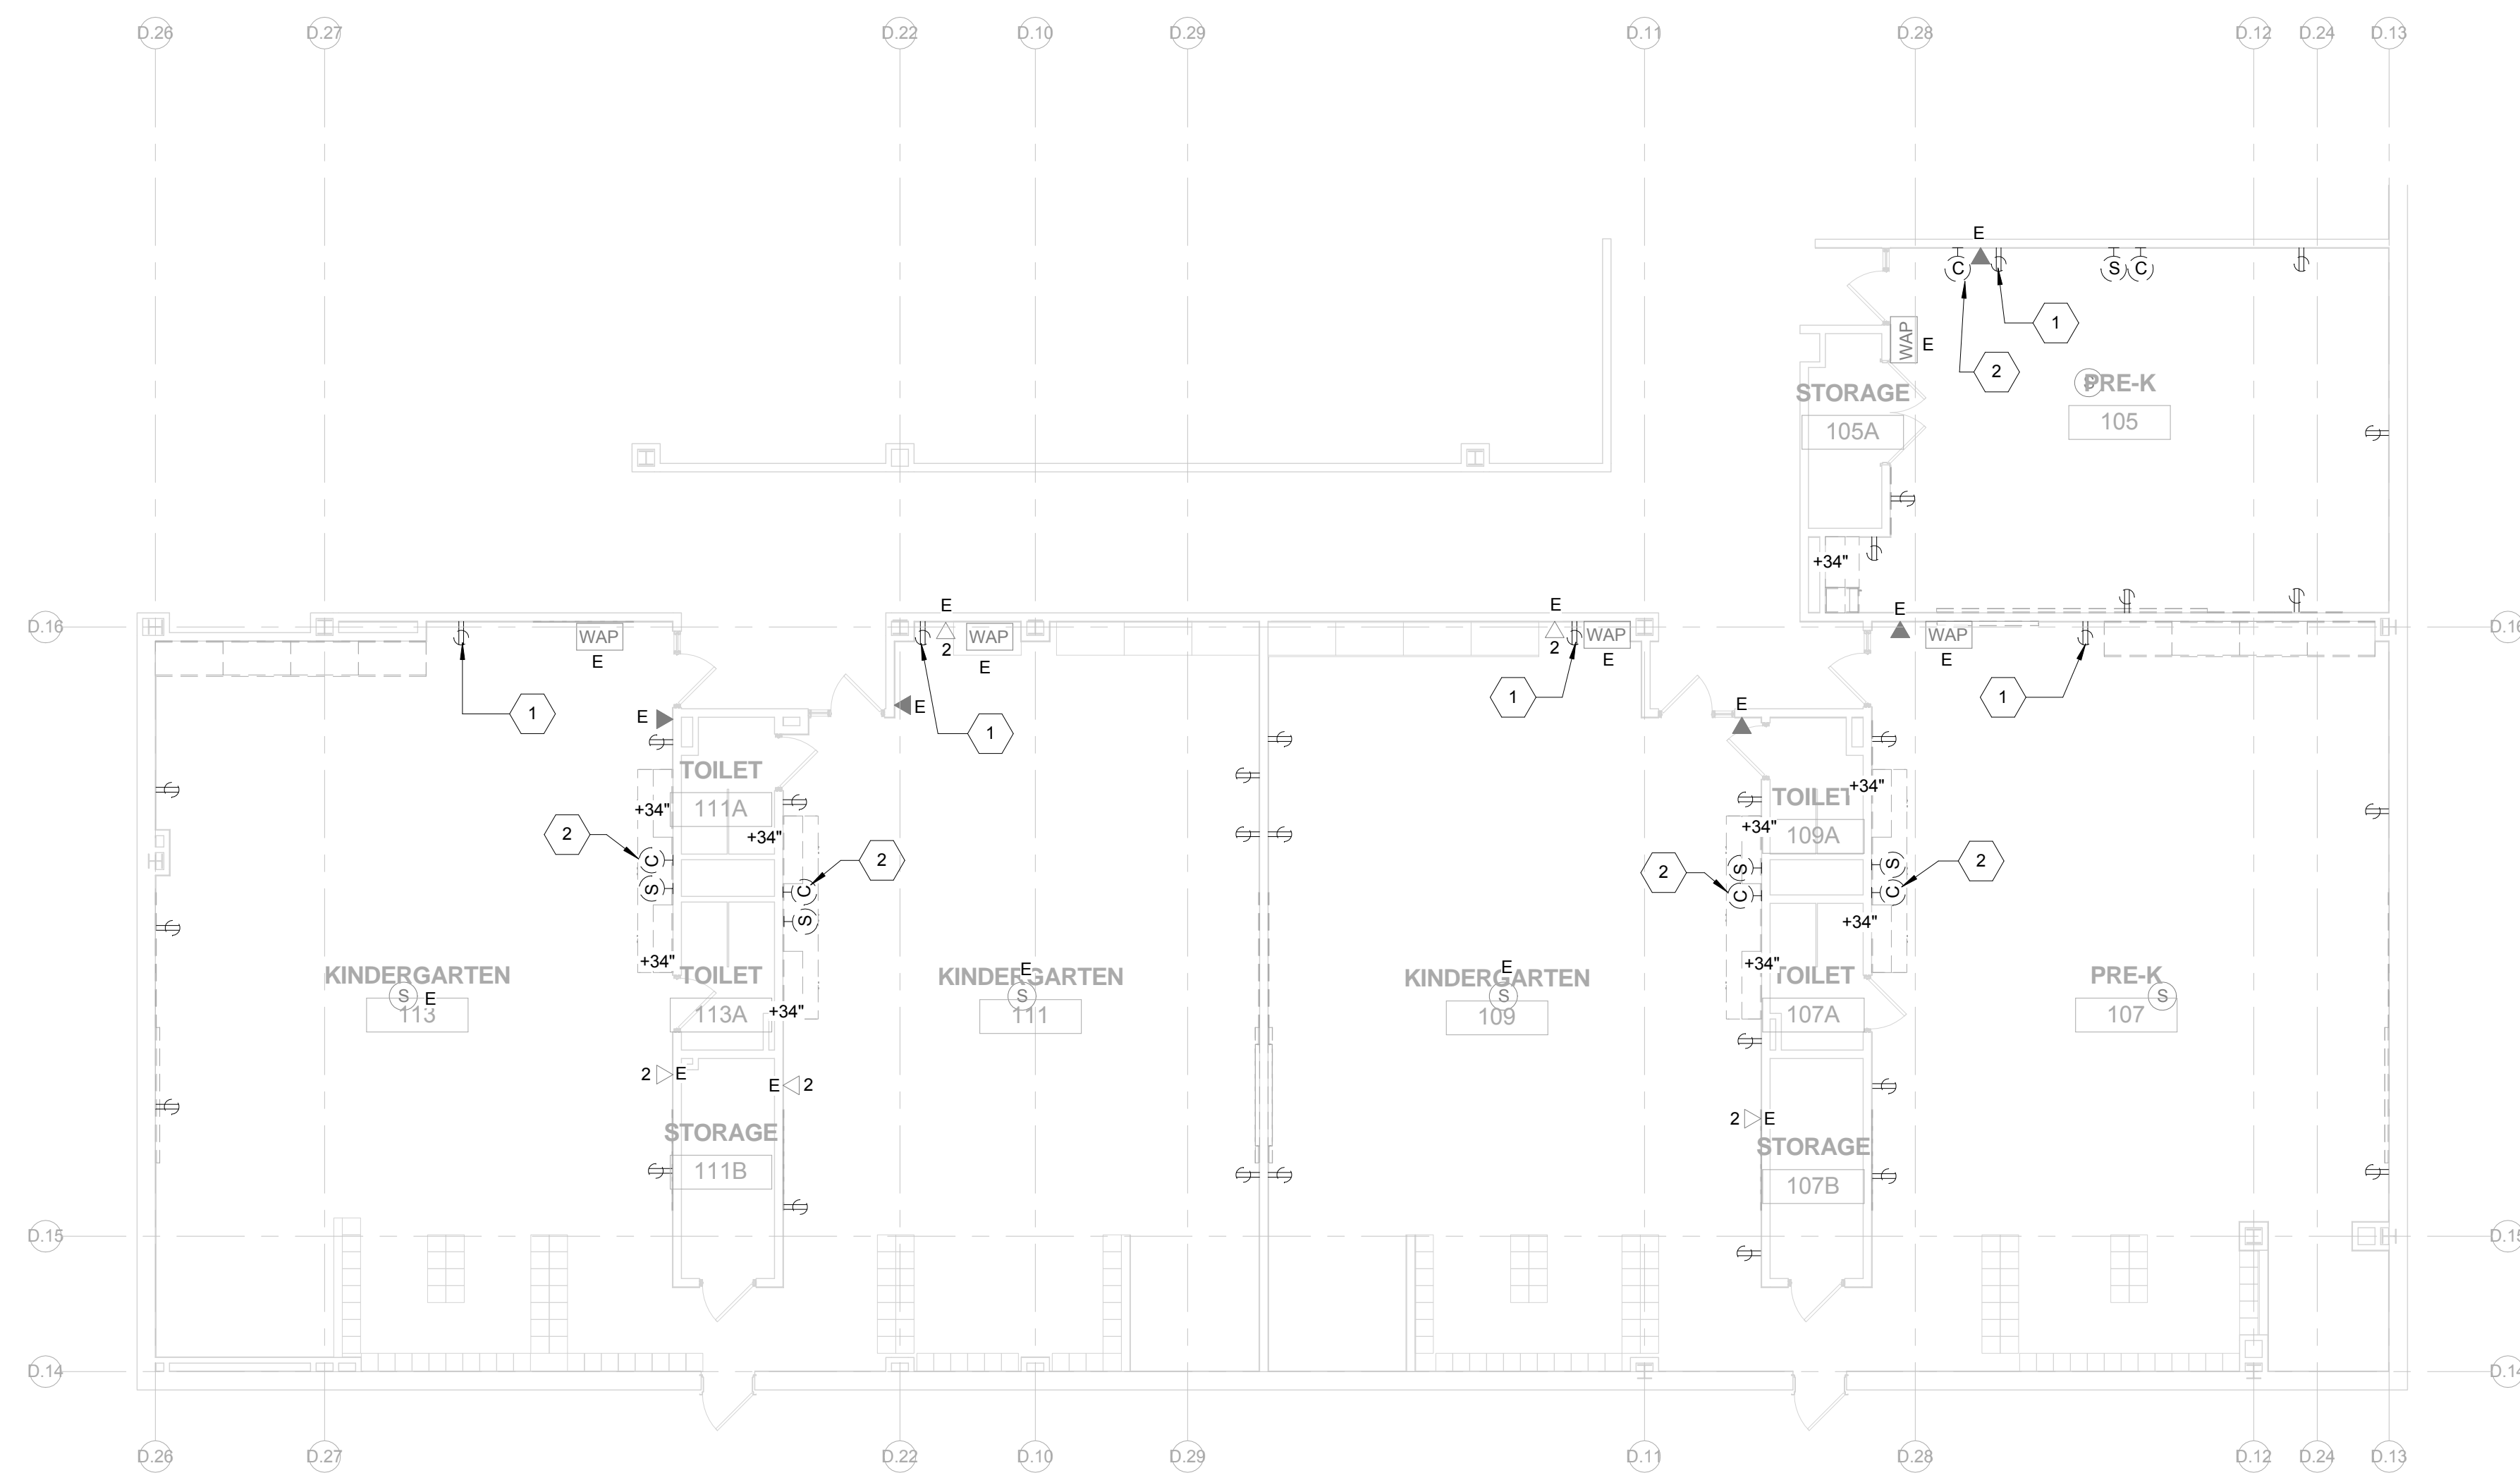
DRAWING TITLE
SECOND LEVEL - LIGHTING FLOOR PLAN - DEMO

LOCATION NO.	FILE NO.
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1 SECOND LEVEL - LIGHTING FLOOR PLAN - DEMOLITION - CLASSROOM 202 TO 211
1/8" = 1'-0"





1 FIRST LEVEL - POWER FLOOR PLAN - DEMOLITION- CLASSROOM 105 TO 113
 1/8" = 1'-0"

GENERAL NOTES

- REFER TO E001 FOR GENERAL NOTES, SYMBOL LEGEND AND LIST OF ABBREVIATIONS.

KEYED NOTES

- DISCONNECT AND REMOVE ALL EXISTING RECEPTACLES WITH COVER PLATE. EXISTING CIRCUIT TO REMAIN. PROVIDE NEW TAMPER RESISTANT RECEPTACLES WITH COVER PLATE, AND RECONNECT TO EXISTING CIRCUIT.
- DISCONNECT AND REMOVE ALL EXISTING SYNCHRONOUS CLOCKS. PROVIDE BLANK COVER PLATE. PATCH AND PAINT TO MATCH EXISTING SURFACES.

SEAL:

Architectural:
 SCHRADERGROUP Architecture, LLC
 Address: 161 Leverington Ave, Suite 105, Philadelphia PA 19127
 Phone: 215.482.7440
 Fax: 215.482.7441
 Email: bgoo@grarc.com
 Attn: Brian Good

MEP:
 GES
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 Address: 6700A Rockledge Drive, Suite 301
 Bethesda Maryland 20817
 Phone: 301.216.2871
 Fax: 301.216.9671
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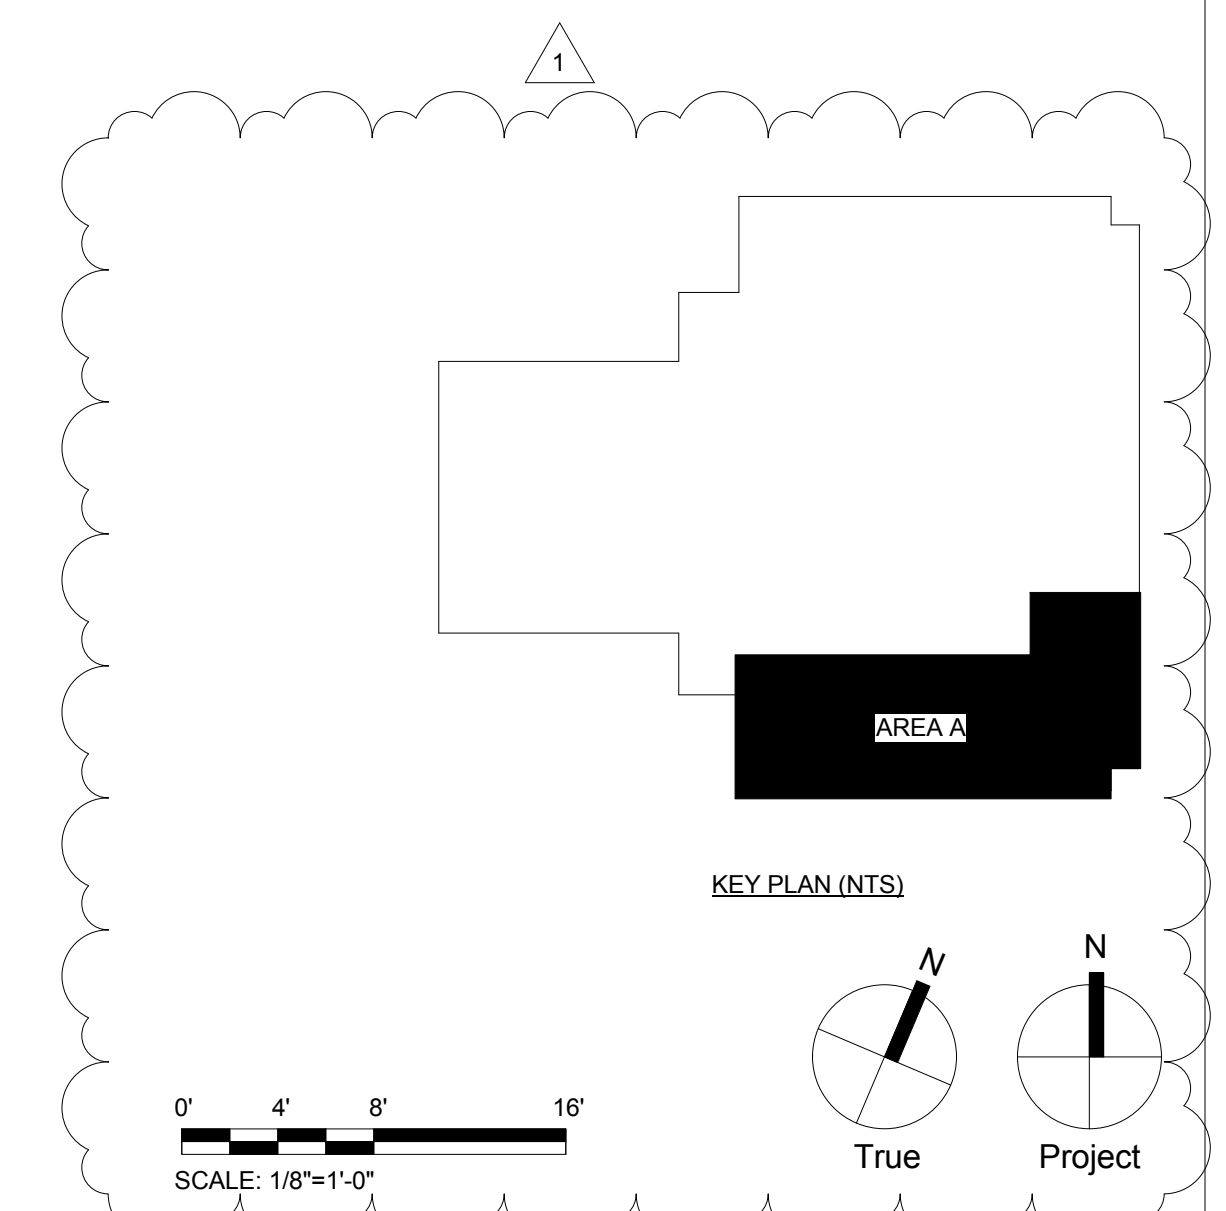
SCHOOL & LOCATION
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 4301 Wayne Avenue, Philadelphia, PA 19140

PROJECT TITLE
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DRAWING TITLE
 FIRST LEVEL - POWER FLOOR PLAN - DEMO

LOCATION NO.	FILE NO.
XX-XXX	
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B-070 C	OF 2017/18

DRAWING NO.
 ED121



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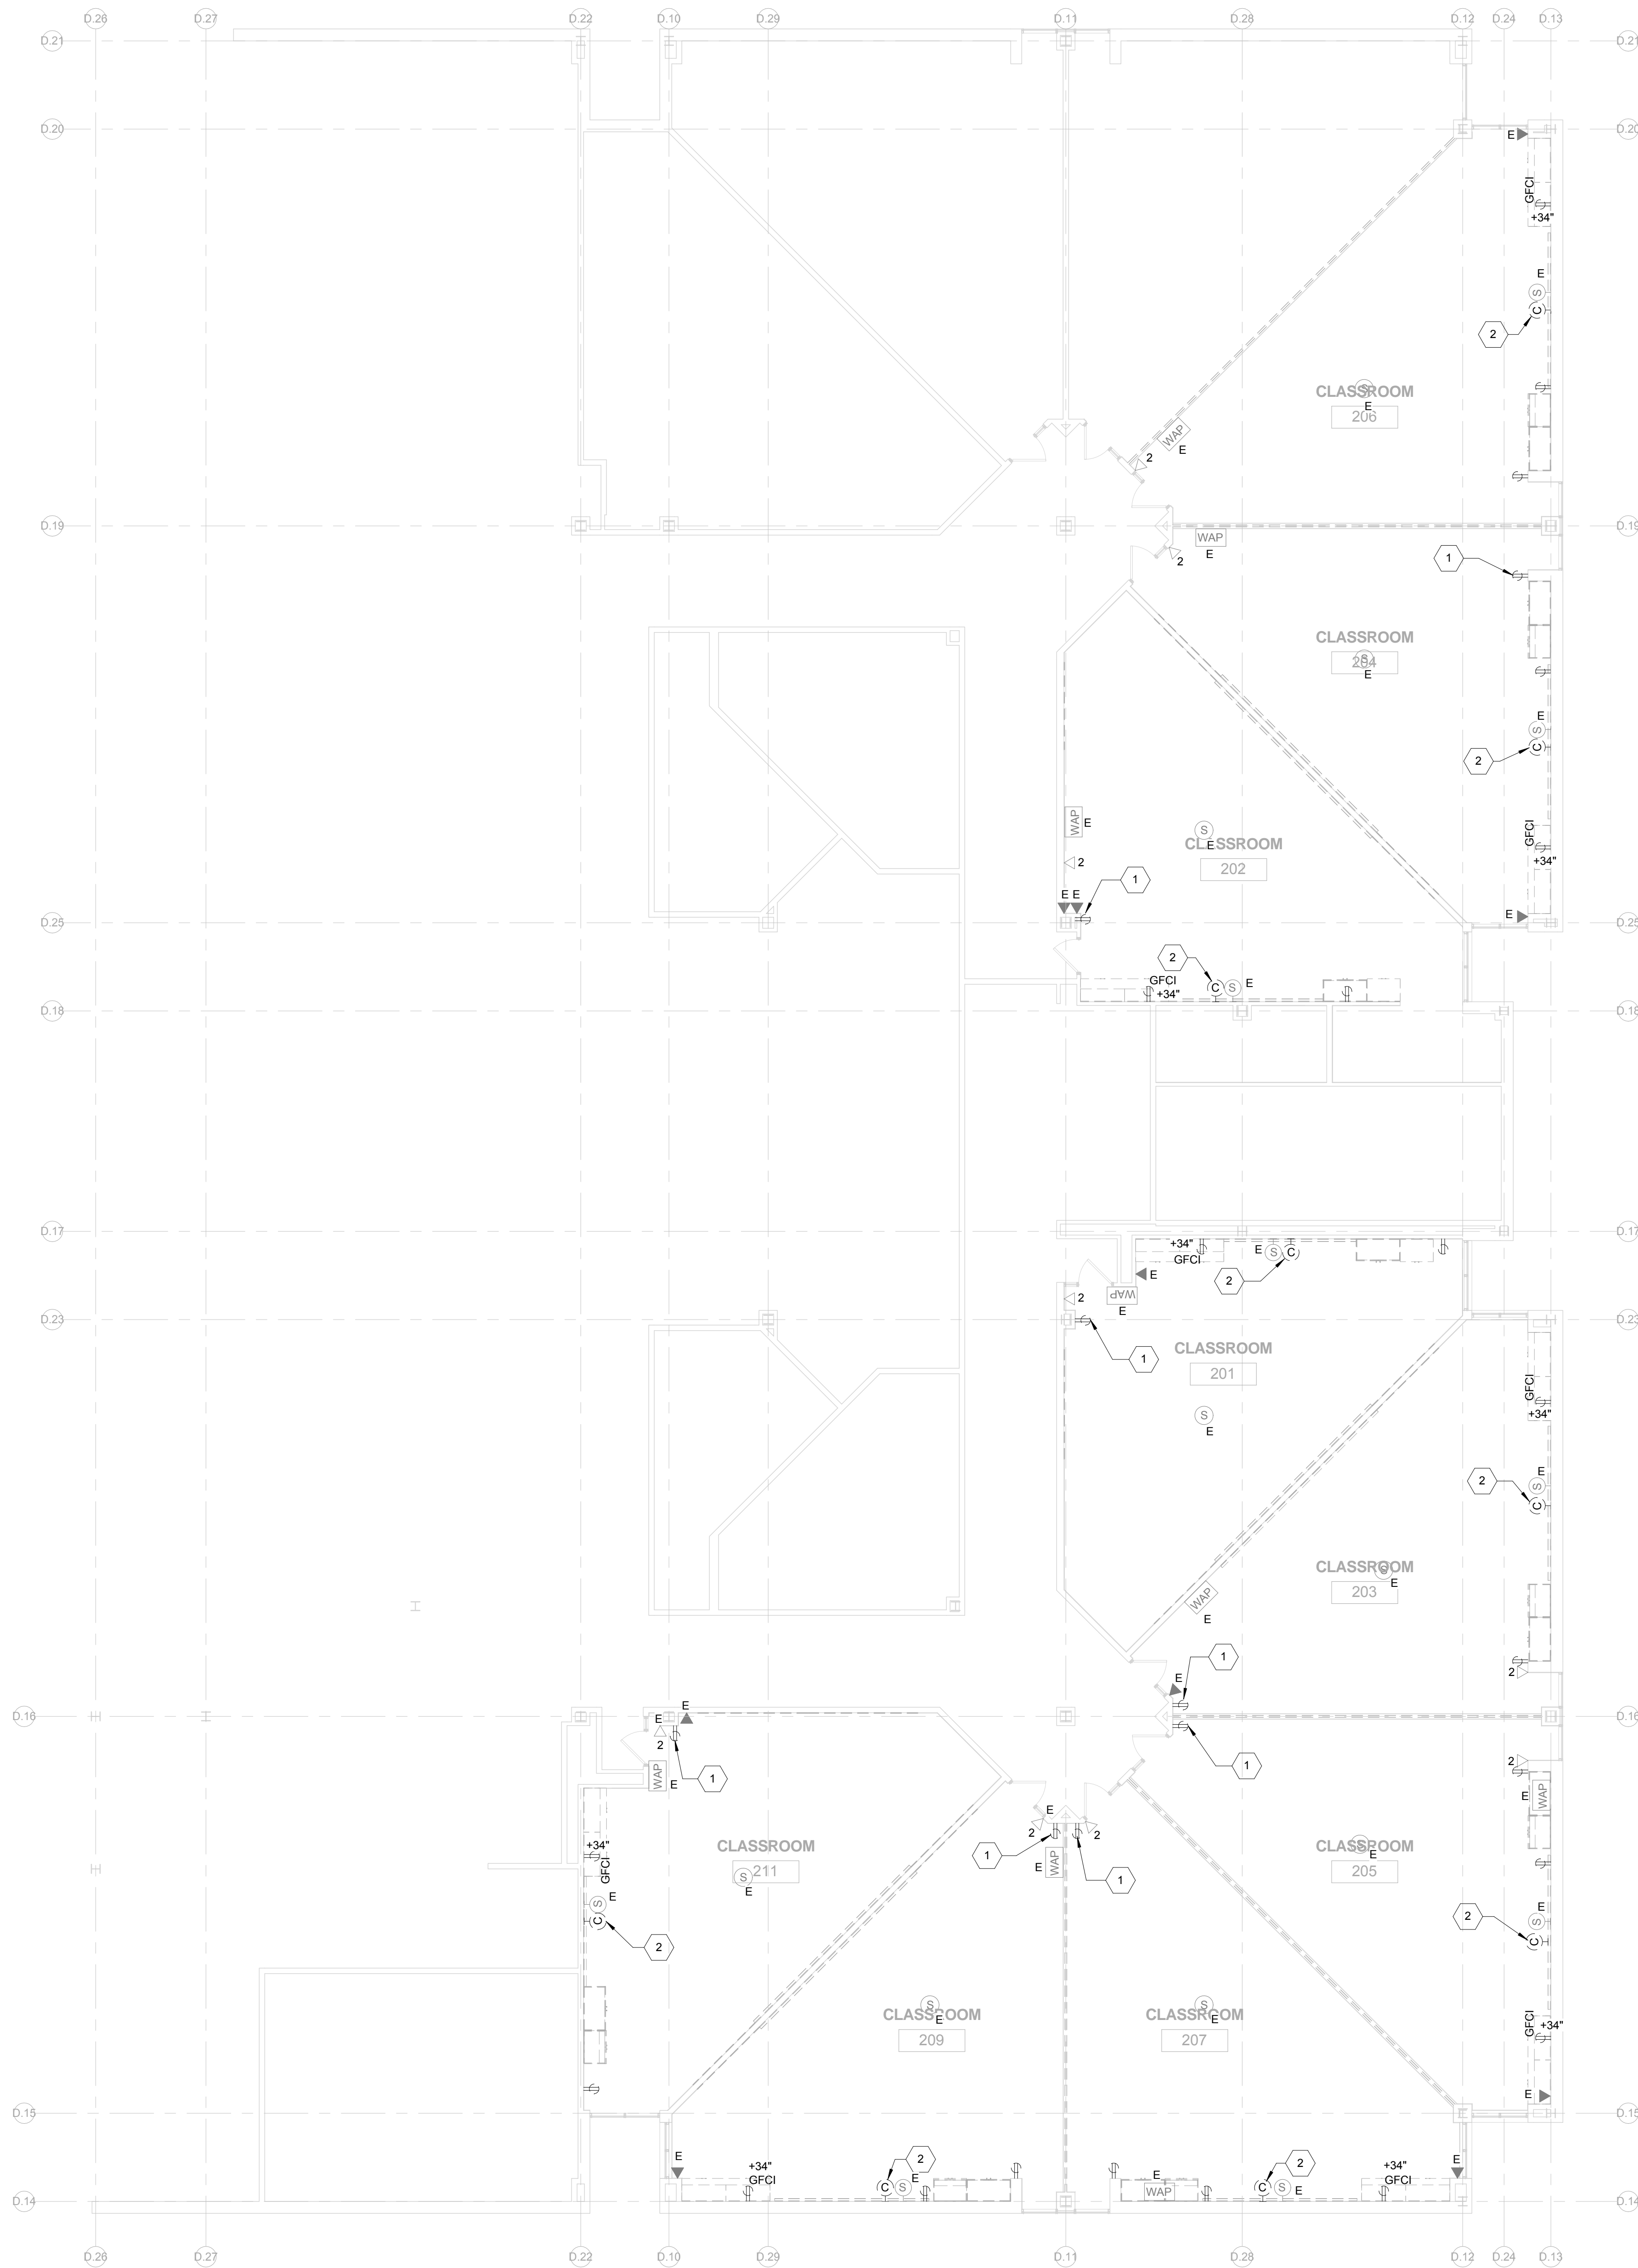
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GENERAL NOTES

- REFER TO E001 FOR GENERAL NOTES, SYMBOL LEGEND AND LIST OF ABBREVIATIONS.

KEYED NOTES

- DISCONNECT AND REMOVE ALL EXISTING RECEPTACLES WITH COVER PLATE. EXISTING CIRCUIT TO REMAIN. PROVIDE NEW TAMPER RESISTANT RECEPTACLES WITH COVER PLATE, AND RECONNECT TO EXISTING CIRCUIT.
- DISCONNECT AND REMOVE ALL EXISTING SYNCHRONOUS CLOCKS. PROVIDE BLANK COVER PLATE. PATCH AND PAINT TO MATCH EXISTING SURFACES.

SEAL:

Architectural:
SCHRADERGROUP Architecture, LLC
Address: 161 Leverington Ave, Suite 105, Philadelphia PA 19127
Phone: 215.482.7440
Fax: 215.482.7441
Email: bgoo@grarc.com
Attn: Brian Good

MEP:
GES
Global Engineering Solutions®
Address: 6700A Rockledge Drive, Suite 301 Bethesda Maryland 20817
Phone: 301.216.2271
Fax: 301.216.9671
Email: amlg@theiges.com
Attn: Ami Gil

[BID DOCUMENTS](#)
[APRIL 20, 2018](#)

NO.	DATE	REVISION
1	05/09/18	ADDENDUM 1

SCHOOL & LOCATION
Edward T. Steel Elementary School
4301 Wayne Avenue, Philadelphia, PA 19140

PROJECT TITLE
Classroom Modifications to Edward T. Steel Elementary School

DRAWING TITLE
SECOND LEVEL - LIGHTING FLOOR PLAN - NEW



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DRAWING NO.
ED122

SECOND LEVEL - POWER FLOOR PLAN - DEMOLITION - CLASSROOM 201, 202, 203, 204, 205, 206, 207, 209, AND 211

1/8" = 1'-0"

0' 4' 8' 16'
SCALE: 1/8"=1'-0"

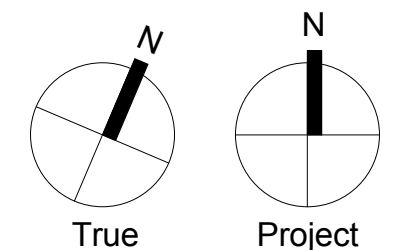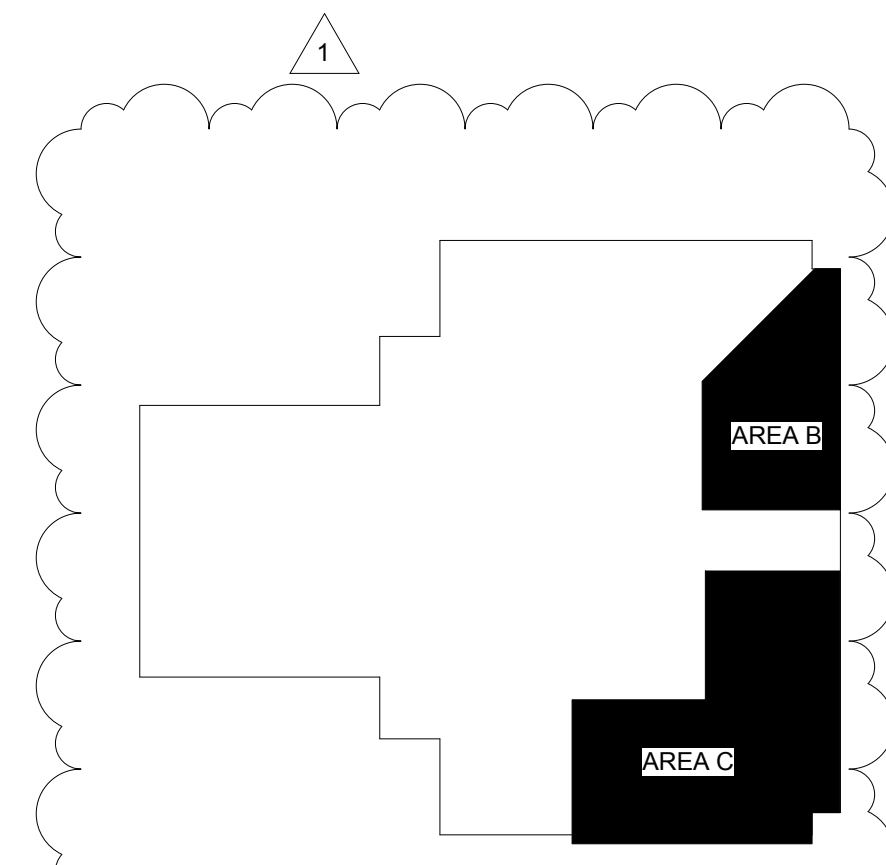

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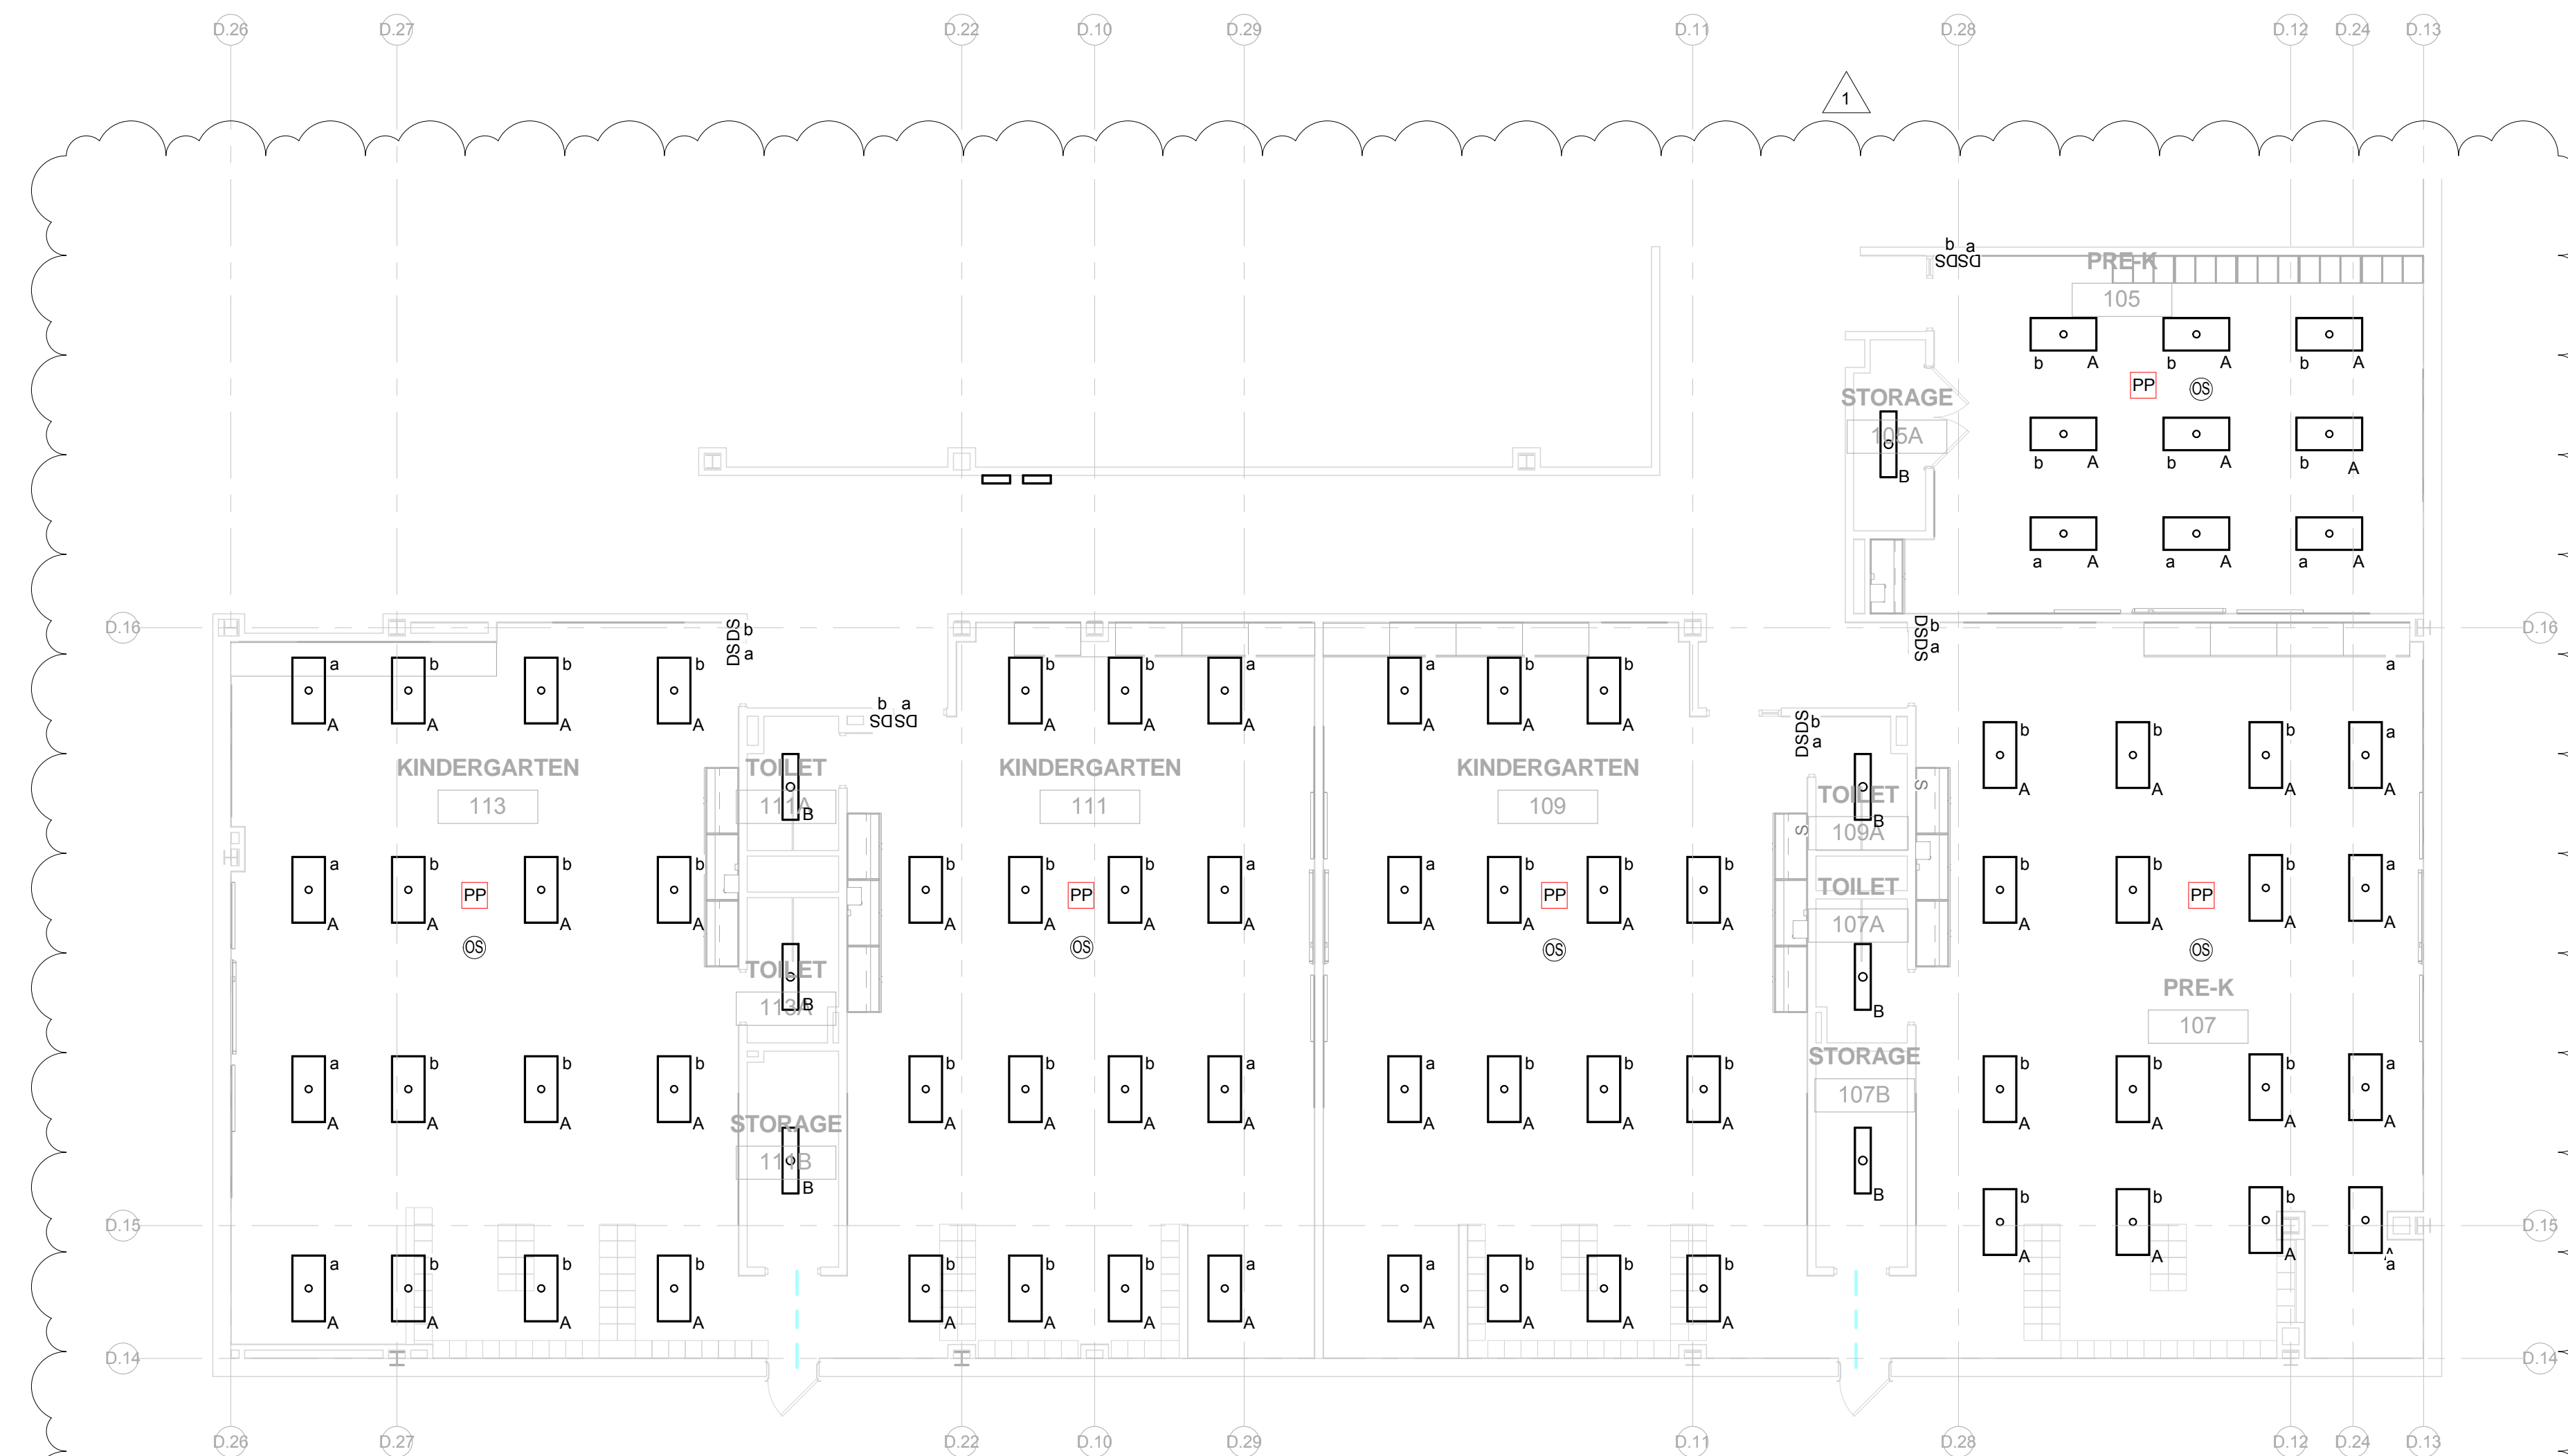
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1 FIRST LEVEL - LIGHTING FLOOR PLAN - NEW WORK - CLASSROOM 105, 107, 109, 111, AND 113
 1/8" = 1'-0"

GENERAL NOTES

1. REFER TO E001 FOR GENERAL NOTES, SYMBOL LEGEND AND LIST OF ABBREVIATIONS.

KEYED NOTES

SEAL:

Architectural:
 SCHRADERGROUP Architecture, LLC
 Address: 161 Leverington Ave, Suite 105, Philadelphia PA 19127
 Phone: 215.482.7440
 Fax: 215.482.7441
 Email: bgood@grarc.com
 Attn: Brian Good

MEP:
 GES
 Global Engineering Solutions®
 Address: 6700A Rockledge Drive, Suite 301 Bethesda Maryland 20817
 Phone: 301.216.2871
 Fax: 301.216.9671
 Email: anlg@thejes.com
 Attn: Anil Gai

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 APRIL 20, 2018

NO.	DATE	REVISION
1	05/09/18	ADDENDUM 1


SCHOOL & LOCATION
Edward T. Steel Elementary School
 4301 Wayne Avenue, Philadelphia, PA 19140

PROJECT TITLE
Classroom Modifications to Edward T. Steel Elementary School

DRAWING TITLE
FIRST LEVEL - LIGHTING FLOOR PLAN - NEW

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XX-XXX	
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Author	Checker
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DRAWING NO.
E111

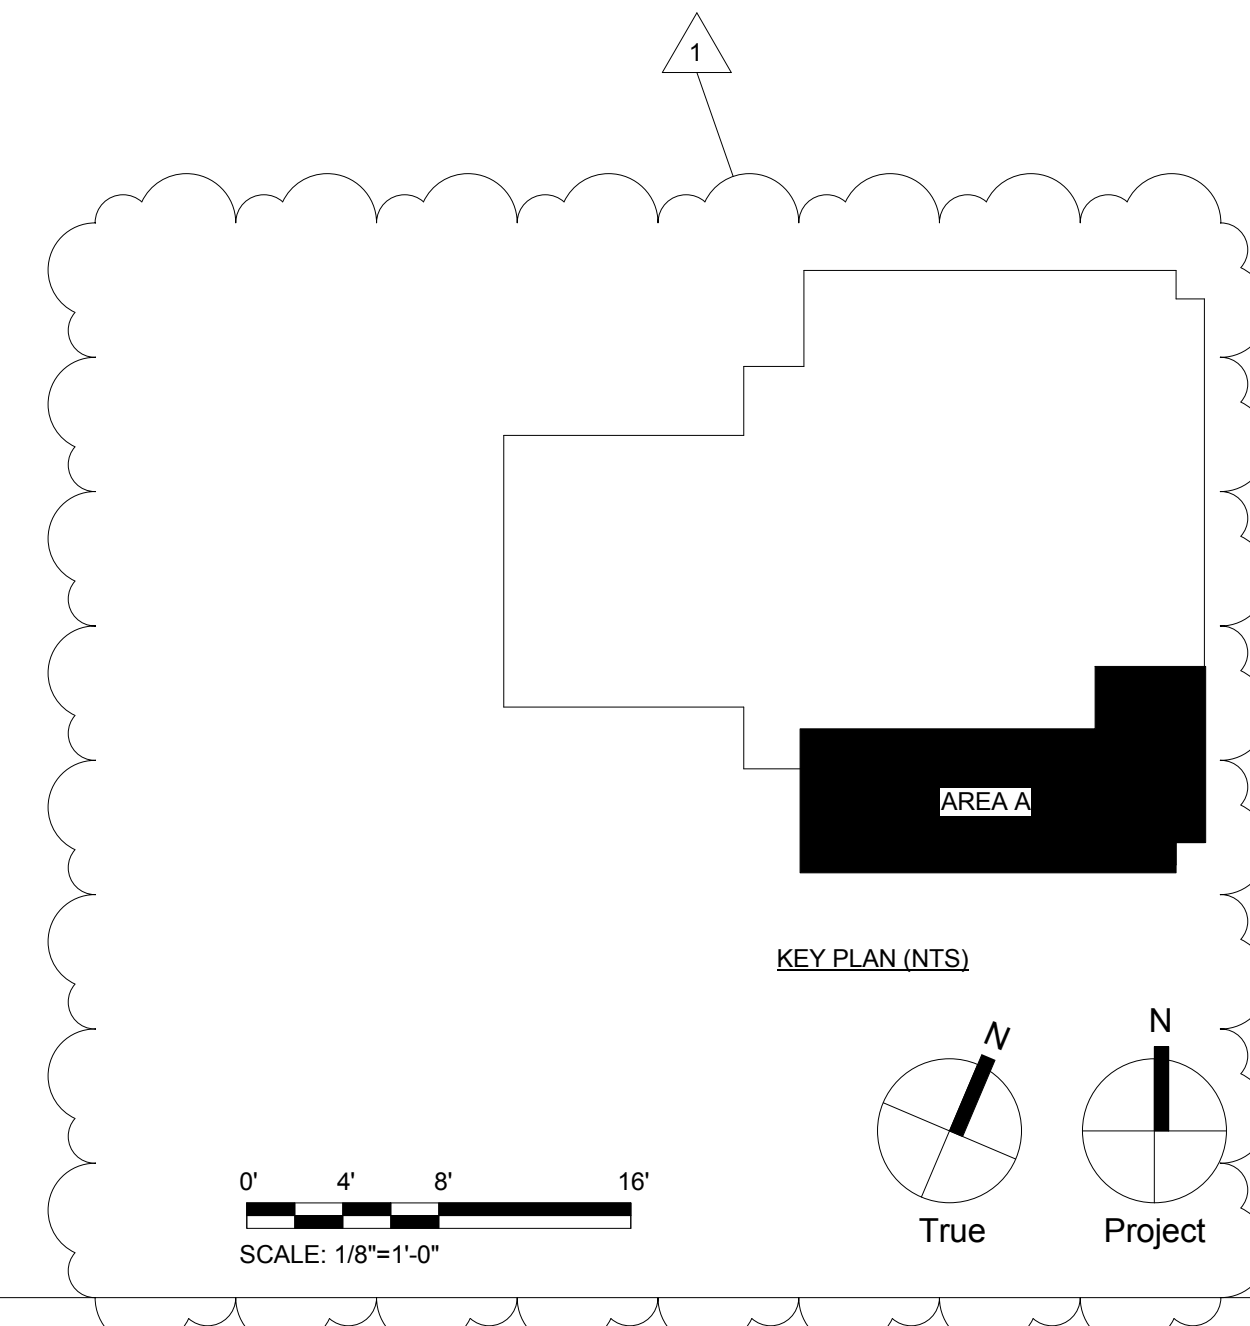

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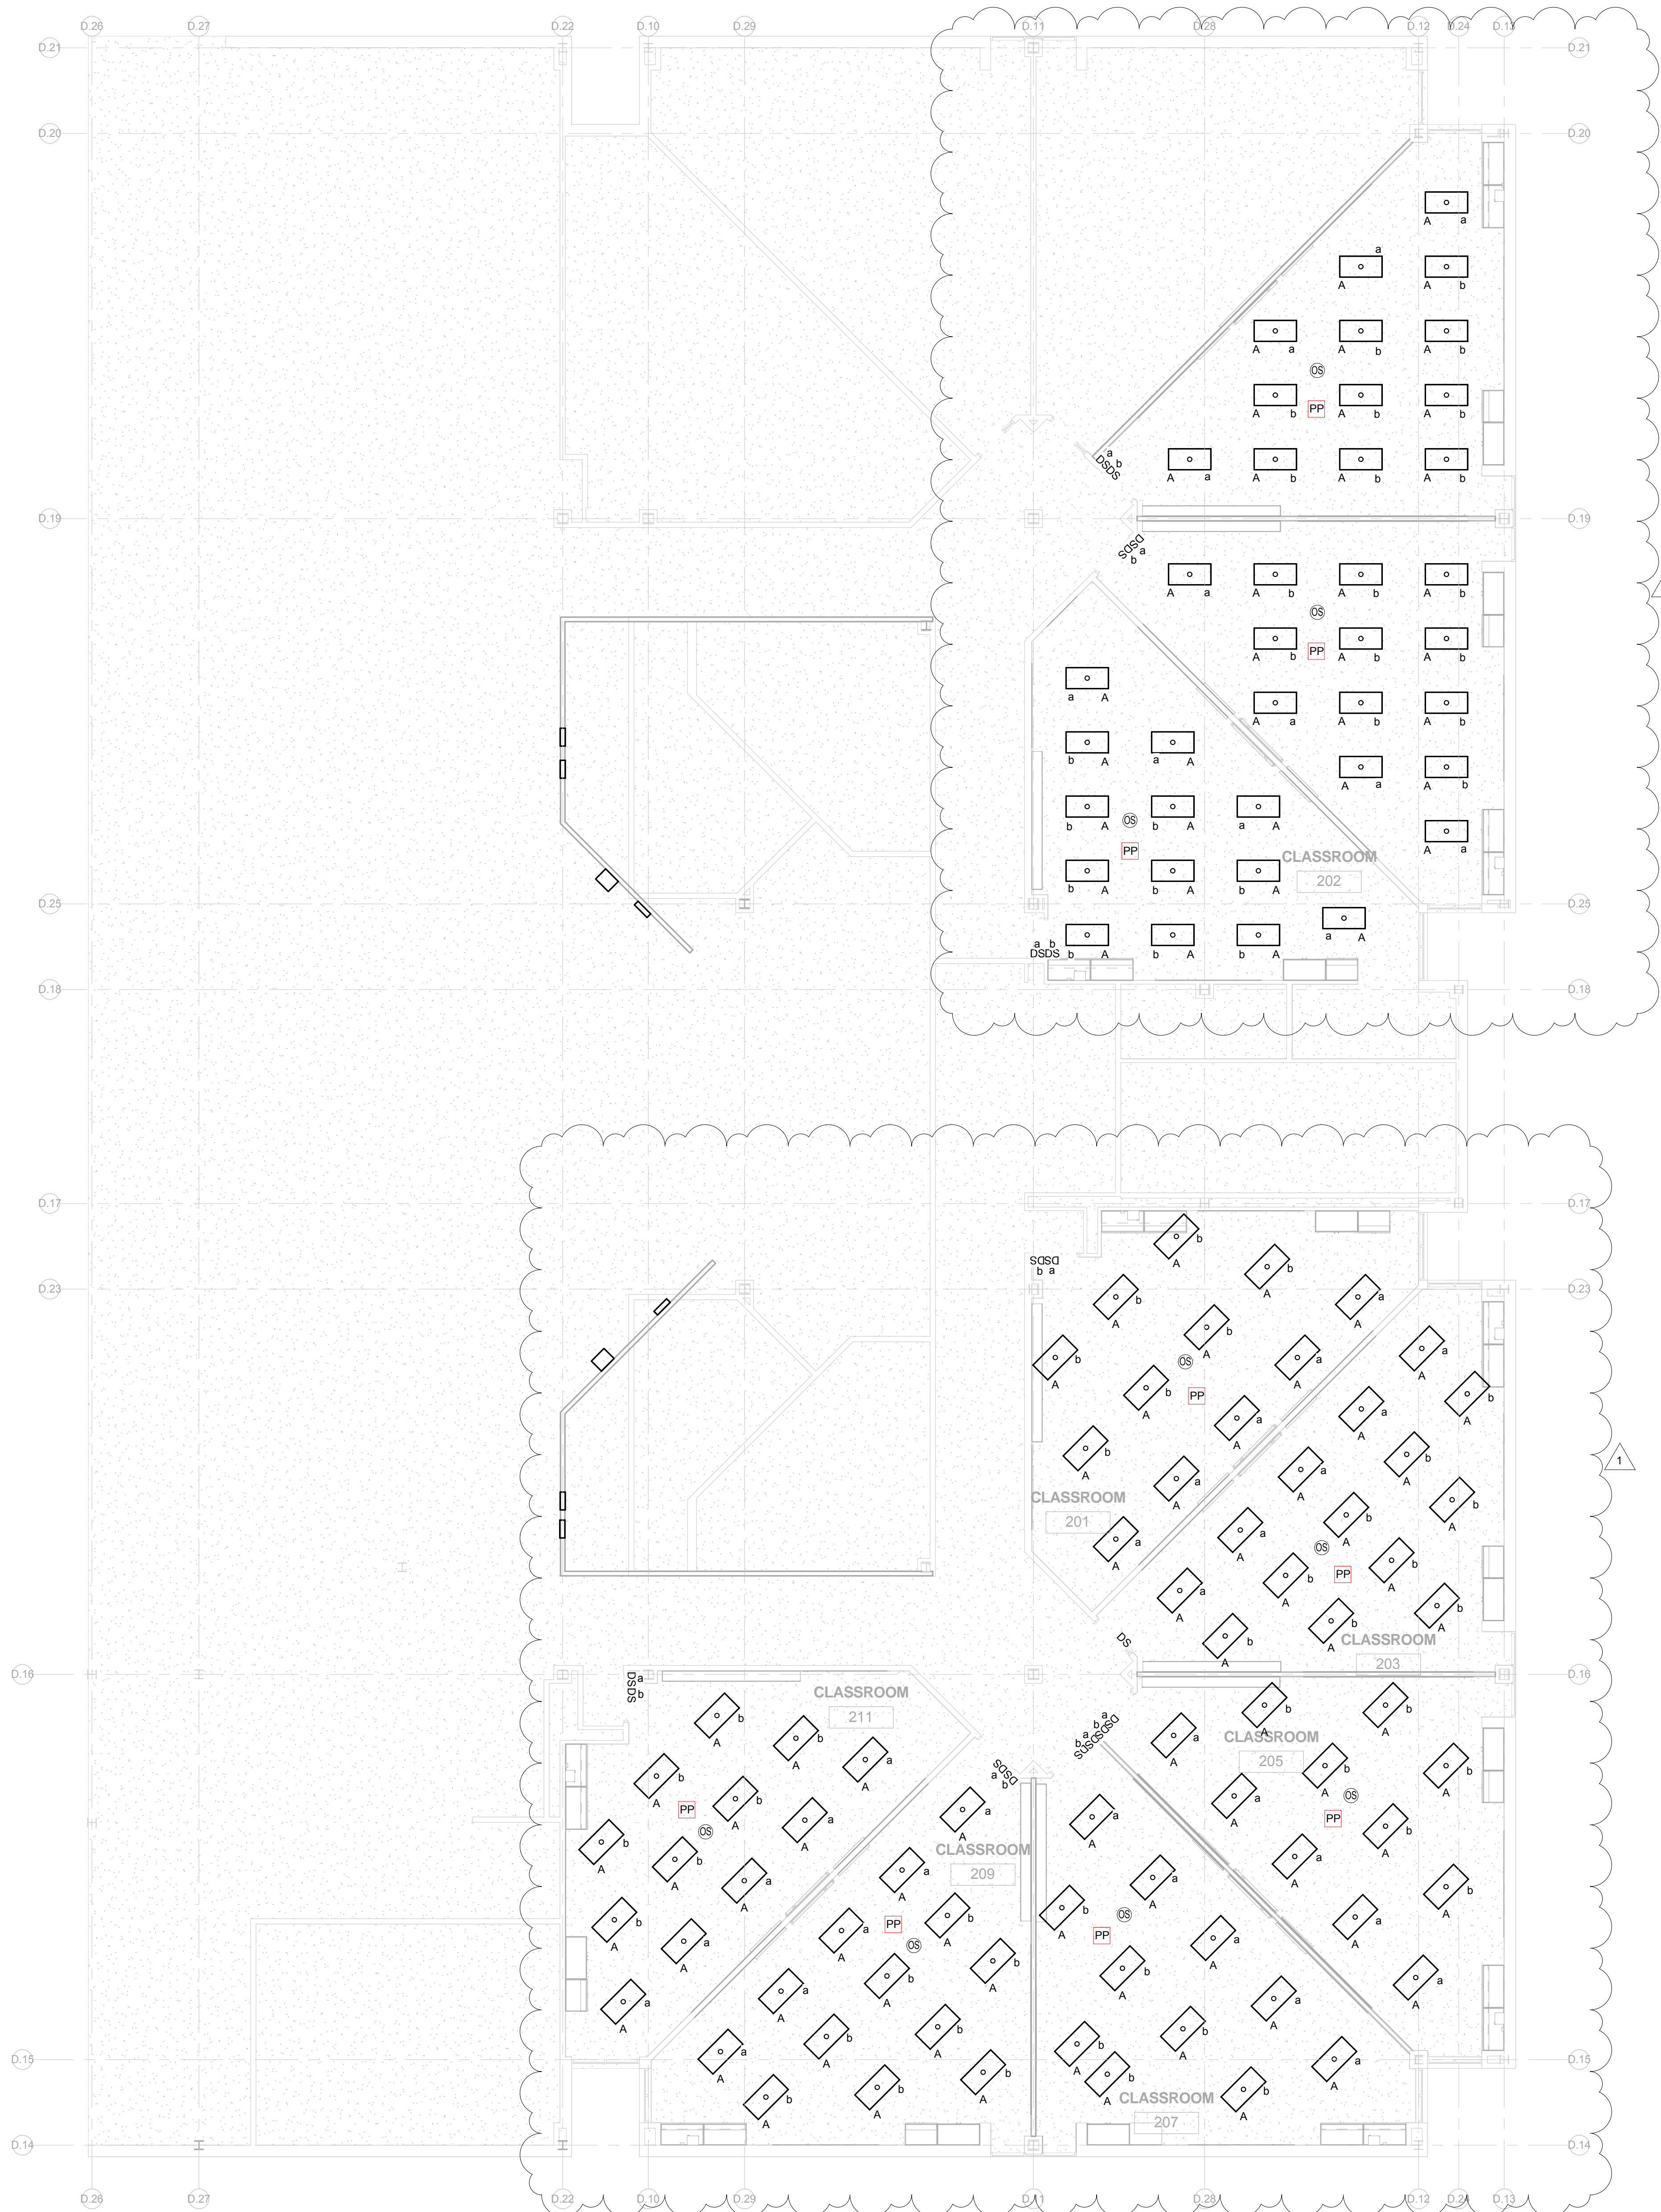
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GENERAL NOTES

- REFER TO E001 FOR GENERAL NOTES, SYMBOL LEGEND AND LIST OF ABBREVIATIONS.

KEYED NOTES

SEAL:

Architectural:
 SCHRADERGROUP Architecture, LLC
 Address: 161 Leverington Ave, Suite 105, Philadelphia PA 19127
 Phone: 215.482.7440
 Fax: 215.482.7441
 Email: bgood@grarc.com
 Attn: Brian Good

MEP:

 Global Engineering Solutions®
 Address: 6700A Rockledge Drive, Suite 301 Bethesda Maryland 20817
 Phone: 301.216.2871
 Fax: 301.216.9671
 Email: amlg@thejges.com
 Attn: Anil Gai

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APRIL 20, 2018

NO.	DATE	REVISION
1	05/09/18	ADDENDUM 1

SCHOOL & LOCATION
Edward T. Steel Elementary School
 4301 Wayne Avenue, Philadelphia, PA 19140

PROJECT TITLE
Classroom Modifications to Edward T. Steel Elementary School

DRAWING TITLE
SECOND LEVEL - LIGHTING FLOOR PLAN - NEW


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B-067 C	OF	2017/18
B-070 C	OF	2017/18

DRAWING NO.
E112

1 SECOND LEVEL - LIGHTING FLOOR PLAN - NEW WORK - CLASSROOM 202 TO 211
 1/8" = 1'-0"



MAXIMUM 20A BRANCH CIRCUIT LENGTH TO FARTHEST OUTLET, ONE WAY, O.U.N.

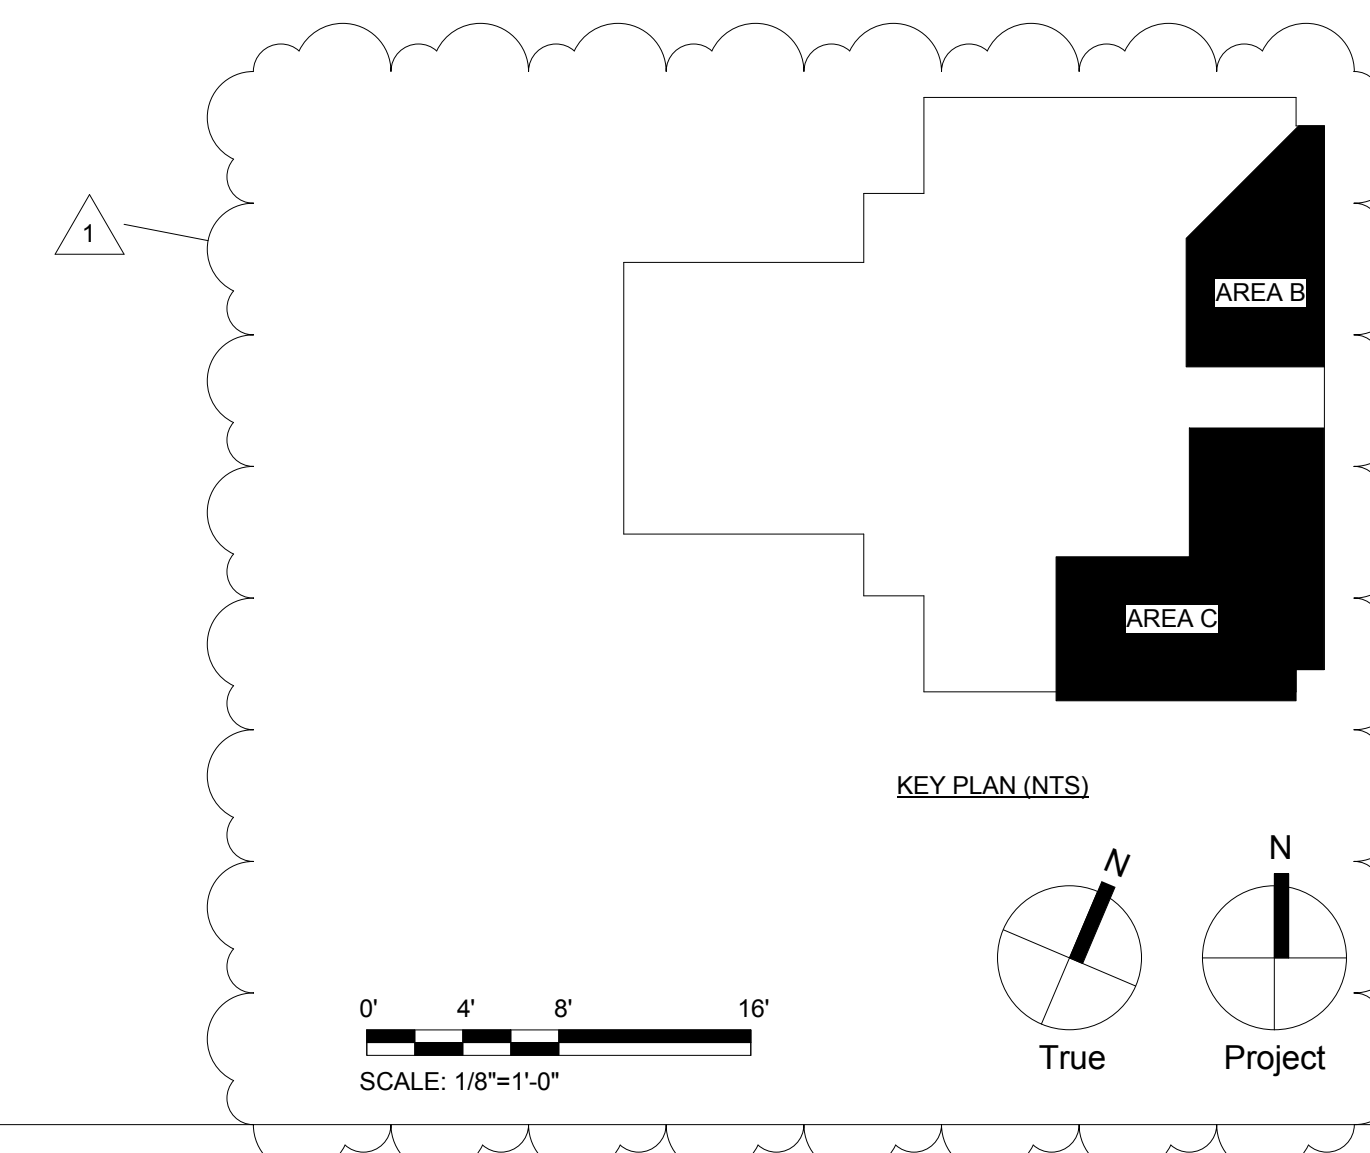
AWG	120V, 1PH			277V, 1PH		
#12	65'	-	-	150'	-	-
#10	-	125'	-	-	275'	-
#8	-	-	200'	-	-	-

GENERAL NOTES

1. REFER TO E001 FOR GENERAL NOTES, SYMBOL LEGEND AND LIST OF ABBREVIATIONS.

KEYED NOTES

1. PROVIDE NEW TAMPER-RESISTANT WITH COVER PLATE RECEPTACLE IN EXISTING BACK BOX AND CONNECT TO EXISTING CIRCUIT.
2. SURFACE MOUNT NEW RECEPTACLE, DATA OUTLET AND ASSOCIATED CONDUITS. CONTRACTOR SHALL COORDINATE LOCATION AND IS-FEASIBILITY OF NEW RECEPTACLE AND DATA OUTLET PRIOR TO INSTALLATION.
3. CONNECT TO AN EXISTING 20A, 1P SPARE CIRCUIT BREAKER #8 IN PANEL LPL-1C.
4. DISCONNECT AND REMOVE EXISTING 50A, 2P SPARE CIRCUIT BREAKER #28, 30 IN PANEL LPL-1C. IN PLACE PROVIDE (2) 20A, 1P, 120V CIRCUIT BREAKER.
5. CONNECT TO EACH CIRCUIT TO AN EXISTING 20A, 1P SPARE CIRCUIT BREAKER #28, 30 IN PANEL LPL-1C.

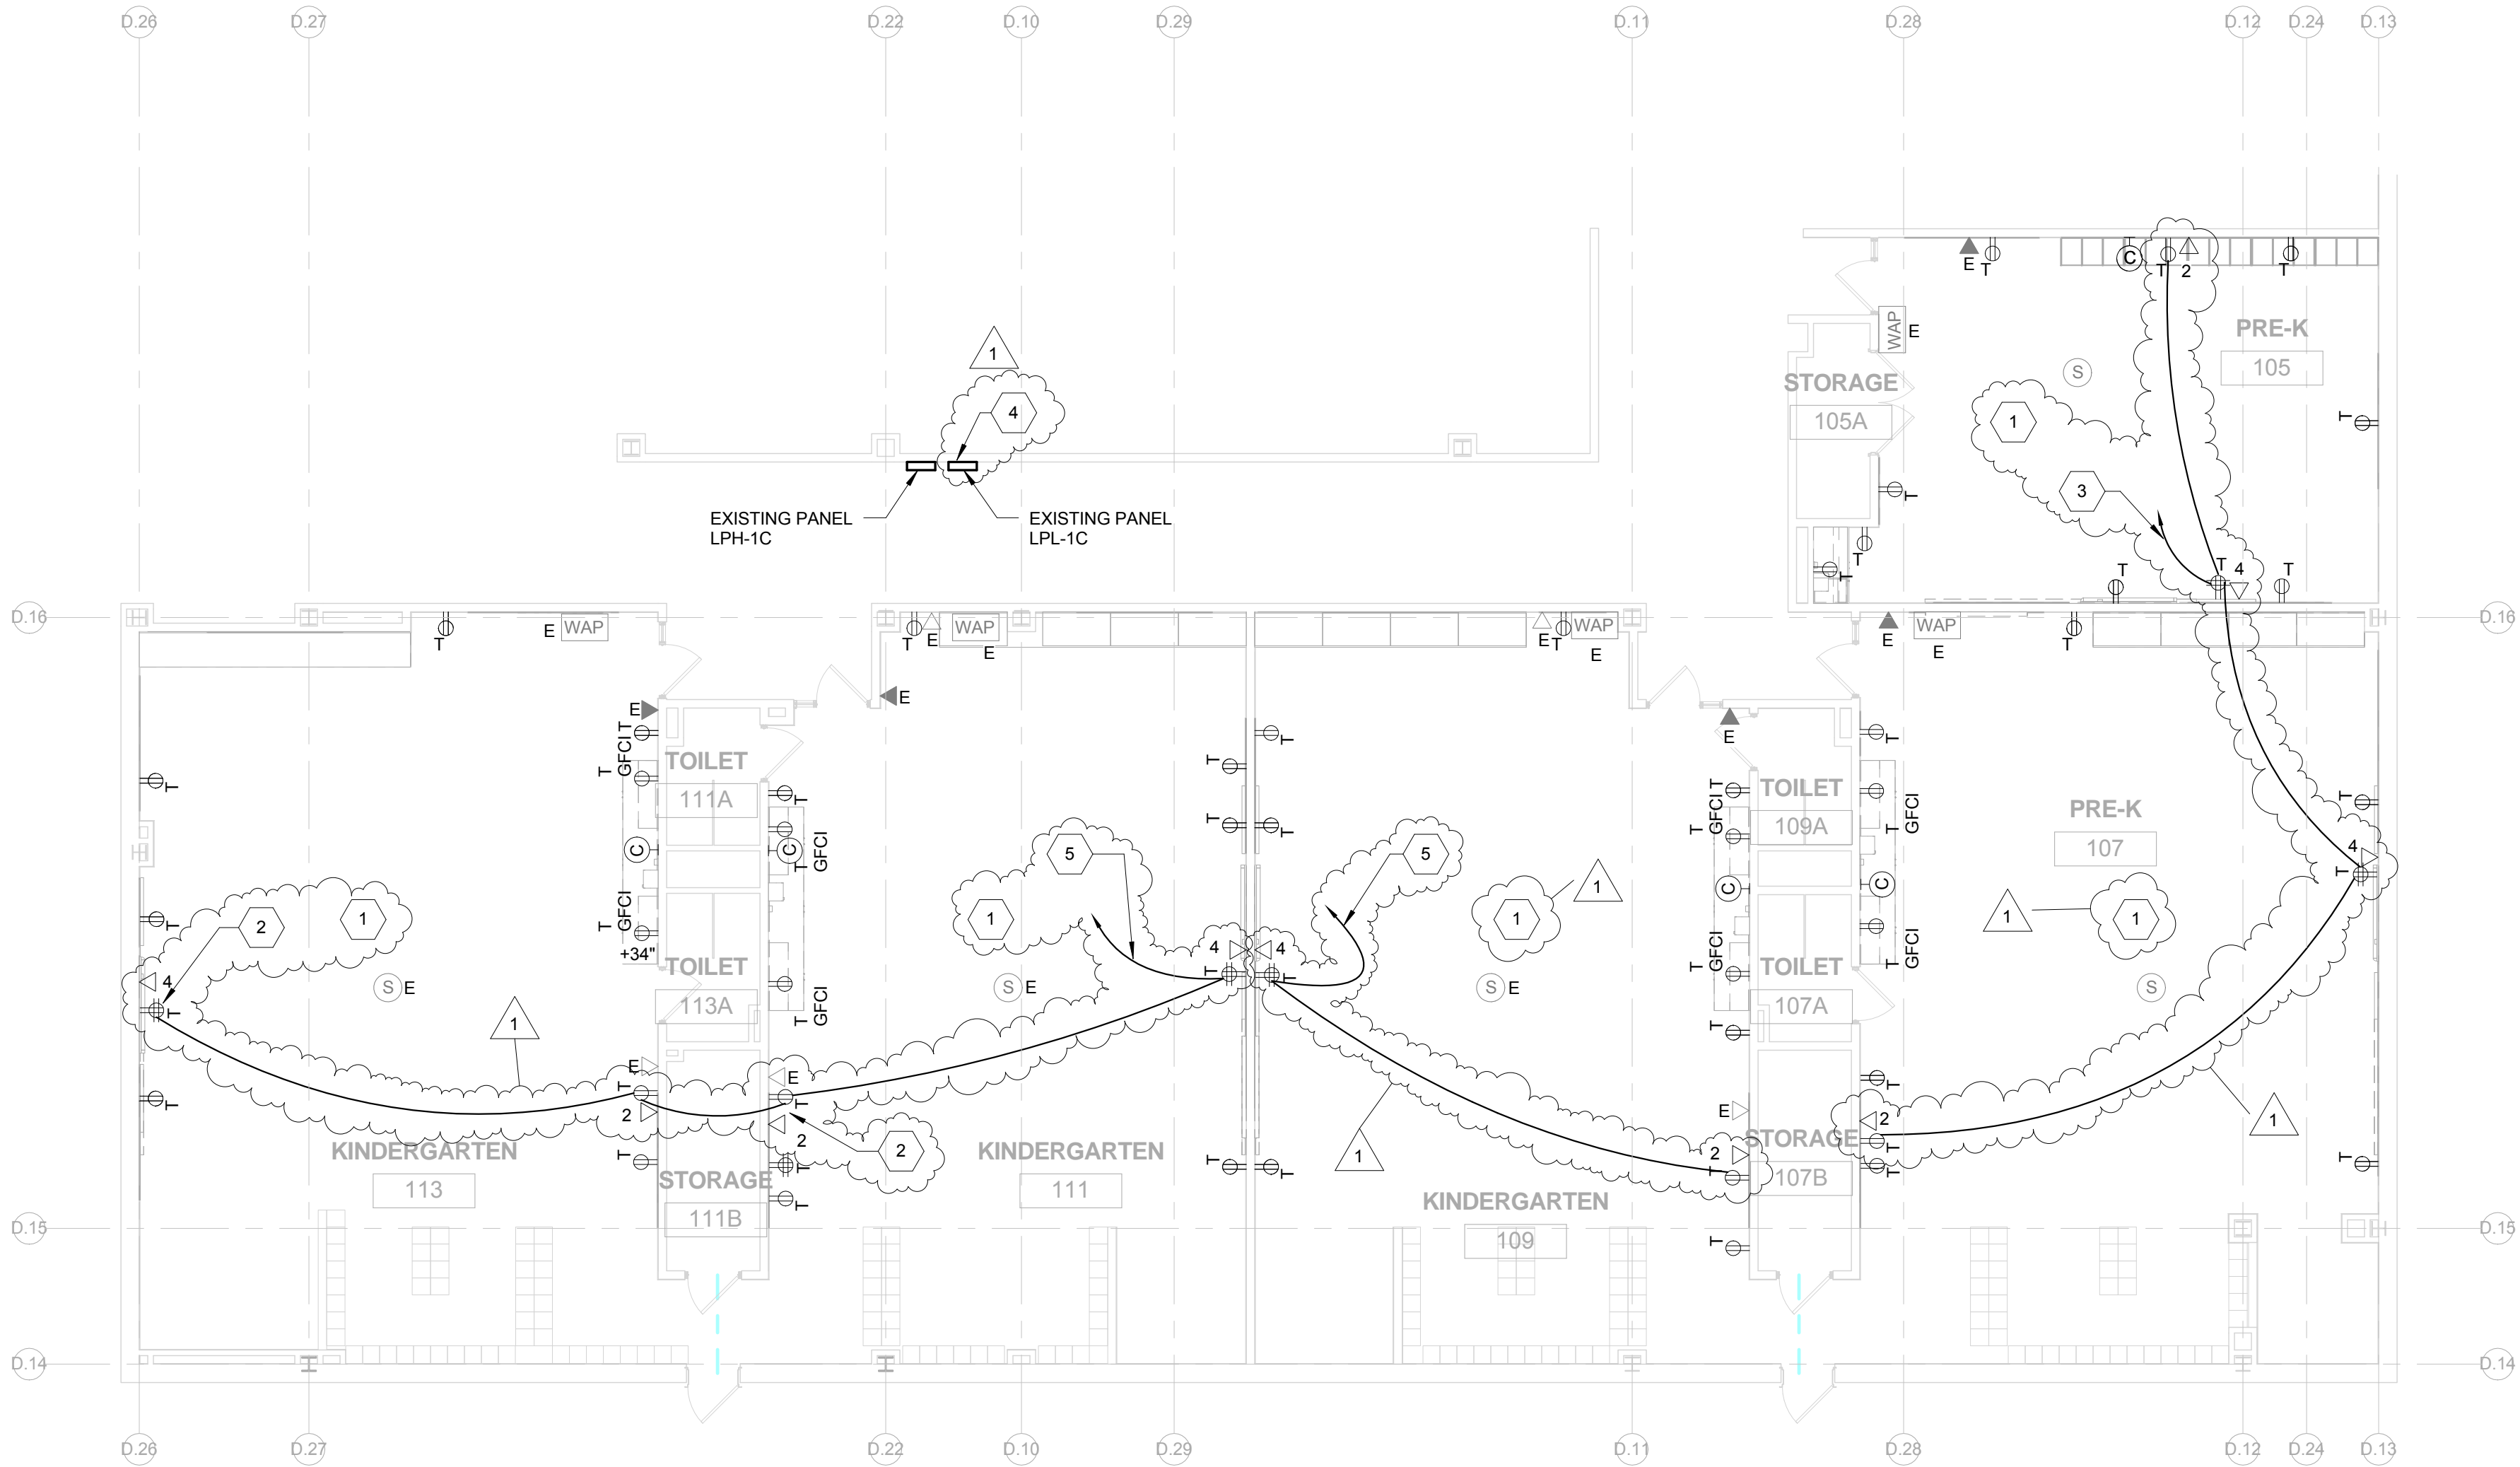

1 FIRST LEVEL - POWER FLOOR PLAN - NEW WORK - CLASSROOMS 105, 107, 109, 111 AND 113
1/8" = 1'-0"

SEAL:

Architectural:
SCHRADERGROUP Architecture, LLC
Address: 161 Leverington Ave, Suite 105, Philadelphia PA 19127
Phone: 215.482.7440
Fax: 215.482.7441
Email: bgood@sgarc.com
Attn: Brian Good

MEP:
GES
Global Engineering Solutions®
Address: 6700A Rockledge Drive, Suite 301 Bethesda Maryland 20817
Phone: 301.216.2871
Fax: 301.216.9671
Email: amlg@thesges.com
Attn: Ami Gai

BID DOCUMENTS
APRIL 20, 2018

NO.	DATE	REVISION
1	05/09/18	ADDENDUM 1


SCHOOL & LOCATION
Edward T. Steel Elementary School
4301 Wayne Avenue, Philadelphia, PA 19140


PROJECT TITLE
Classroom Modifications to Edward T. Steel Elementary School

DRAWING TITLE
FIRST LEVEL - POWER FLOOR PLAN - NEW

LOCATION NO.	FILE NO.
XX-XXX	
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B-067 C	OF 2017/18
B-070 C	OF 2017/18

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E121

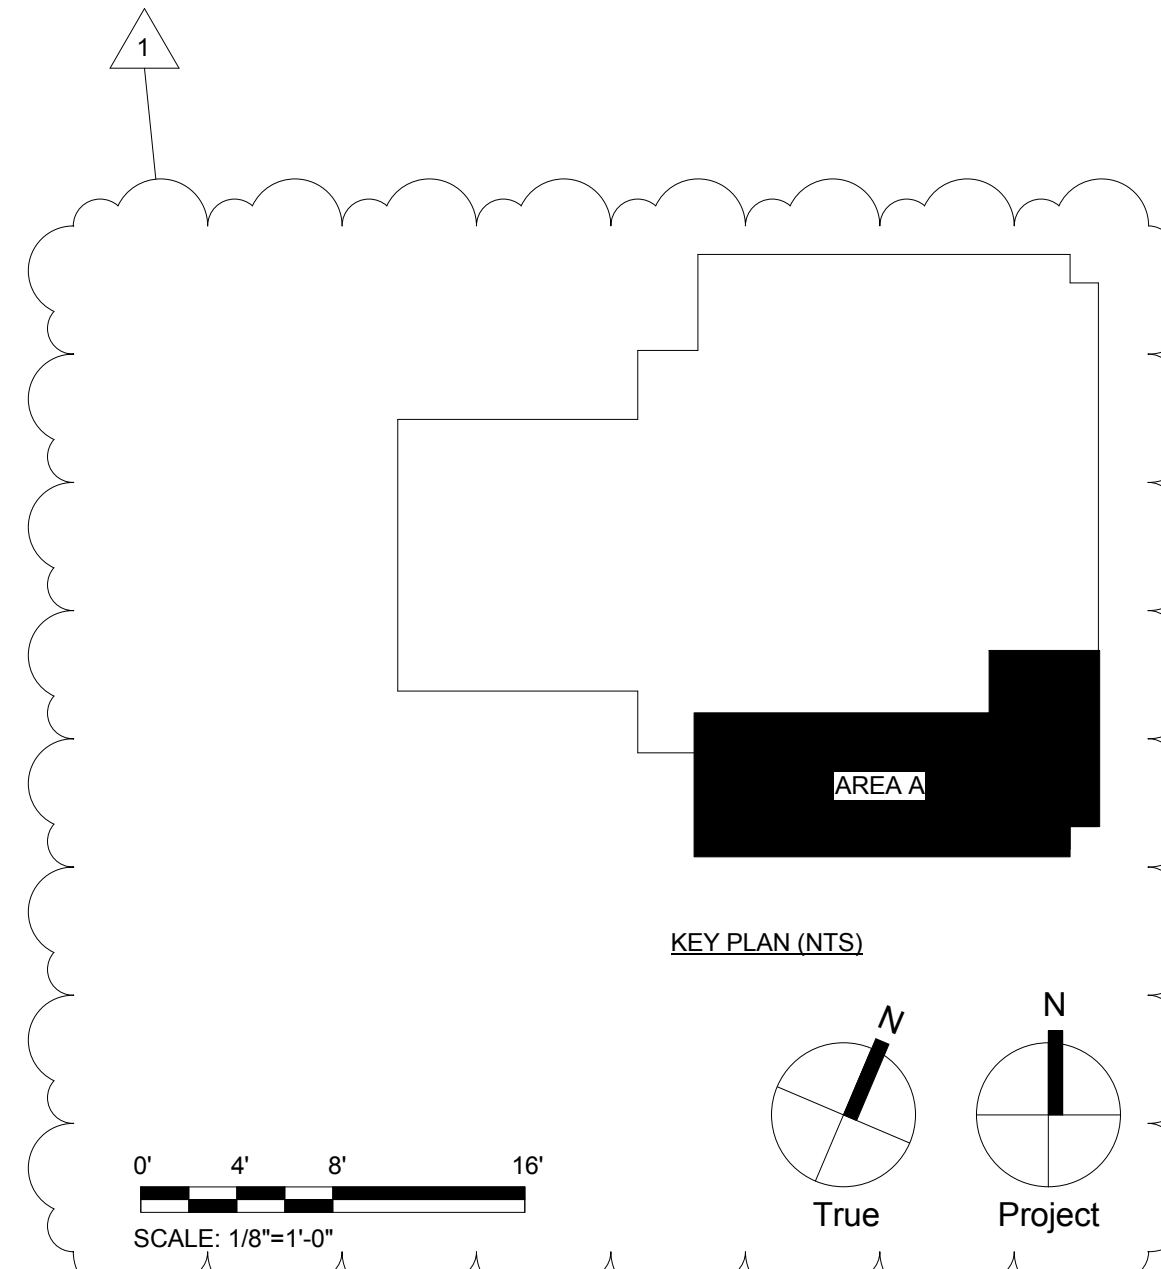

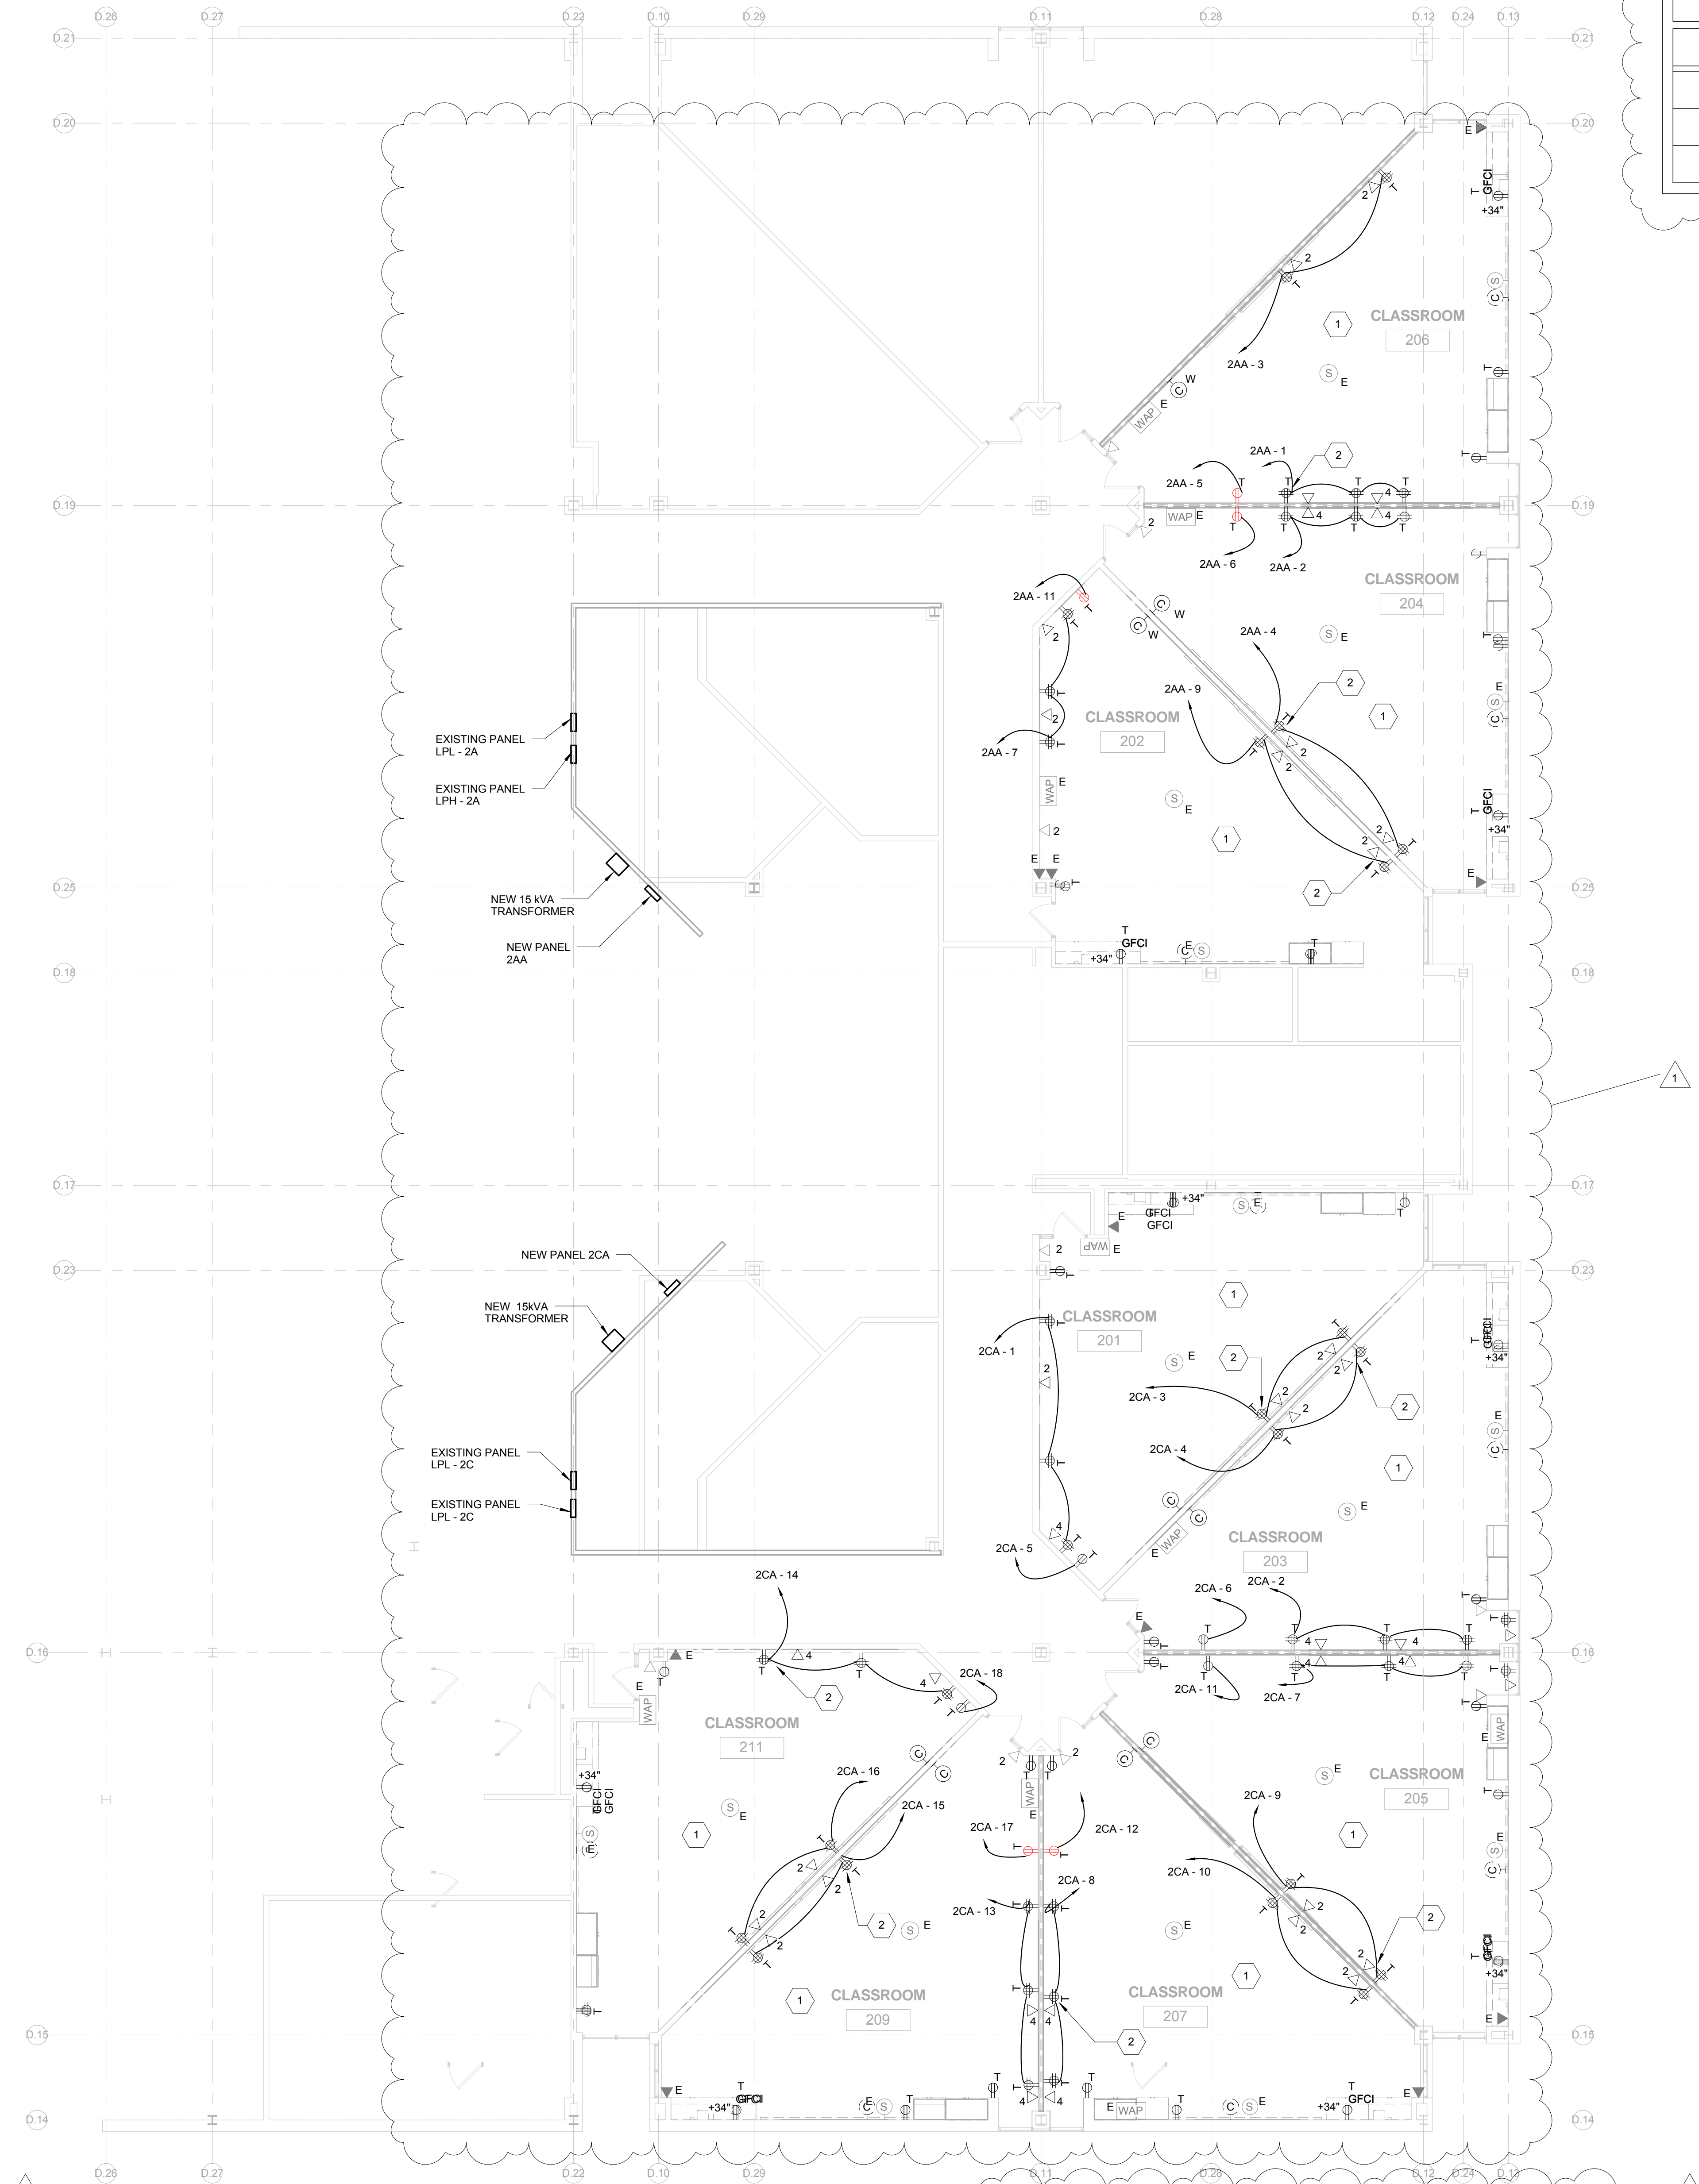

MAXIMUM 20A BRANCH CIRCUIT LENGTH TO FARTHEST OUTLET, ONE WAY, O.U.N.

AWG	120V, 1PH		277V, 1PH	
#12	65'	-	150'	-
#10	-	125'	-	275'
#8	-	-	200'	-

GENERAL NOTES

1. REFER TO E001 FOR GENERAL NOTES, SYMBOL LEGEND AND LIST OF ABBREVIATIONS.

KEYED NOTES

1. PROVIDE NEW TAMPER-RESISTANT WITH COVER PLATE RECEPTACLE IN EXISTING BACK BOX AND CONNECT TO EXISTING CIRCUIT.
2. SURFACE MOUNT NEW RECEPTACLE, DATA OUTLET AND ASSOCIATED CONDUITS. CONTRACTOR SHALL COORDINATE LOCATION AND ITS FEASIBILITY OF NEW RECEPTACLE AND DATA OUTLET PRIOR TO INSTALLATION.

SEAL:

Architectural:
SCHRADERGROUP Architecture, LLC
Address: 161 Leverington Ave, Suite 105, Philadelphia PA 19127
Phone: 215.482.7440
Fax: 215.482.7441
Email: bgoode@grarc.com
Attn: Brian Good

MEP:
GES
Global Engineering Solutions®
Address: 6700A Rockledge Drive, Suite 301
Bethesda Maryland 20817
Phone: 301.216.2871
Fax: 301.216.9671
Email: amilg@theiges.com
Attn: Anil Gai

BID DOCUMENTS
APRIL 20, 2018

NO.	DATE	REVISION
1	05/09/18	ADDENDUM 1

SCHOOL & LOCATION
Edward T. Steel Elementary School
4301 Wayne Avenue, Philadelphia, PA 19140

PROJECT TITLE
Classroom Modifications to Edward T. Steel Elementary School

DRAWING TITLE
SECOND LEVEL - POWER FLOOR PLAN - NEW


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Author	Checker

	OF	2017/18
B-067 C	OF	2017/18
B-070 C	OF	2017/18

DRAWING NO.
E122

SECOND LEVEL - POWER FLOOR PLAN - NEW WORK - CLASSROOMS 201, 202, 203, 204, 205, 206, 207, 209, AND 211
1/8" = 1'-0"

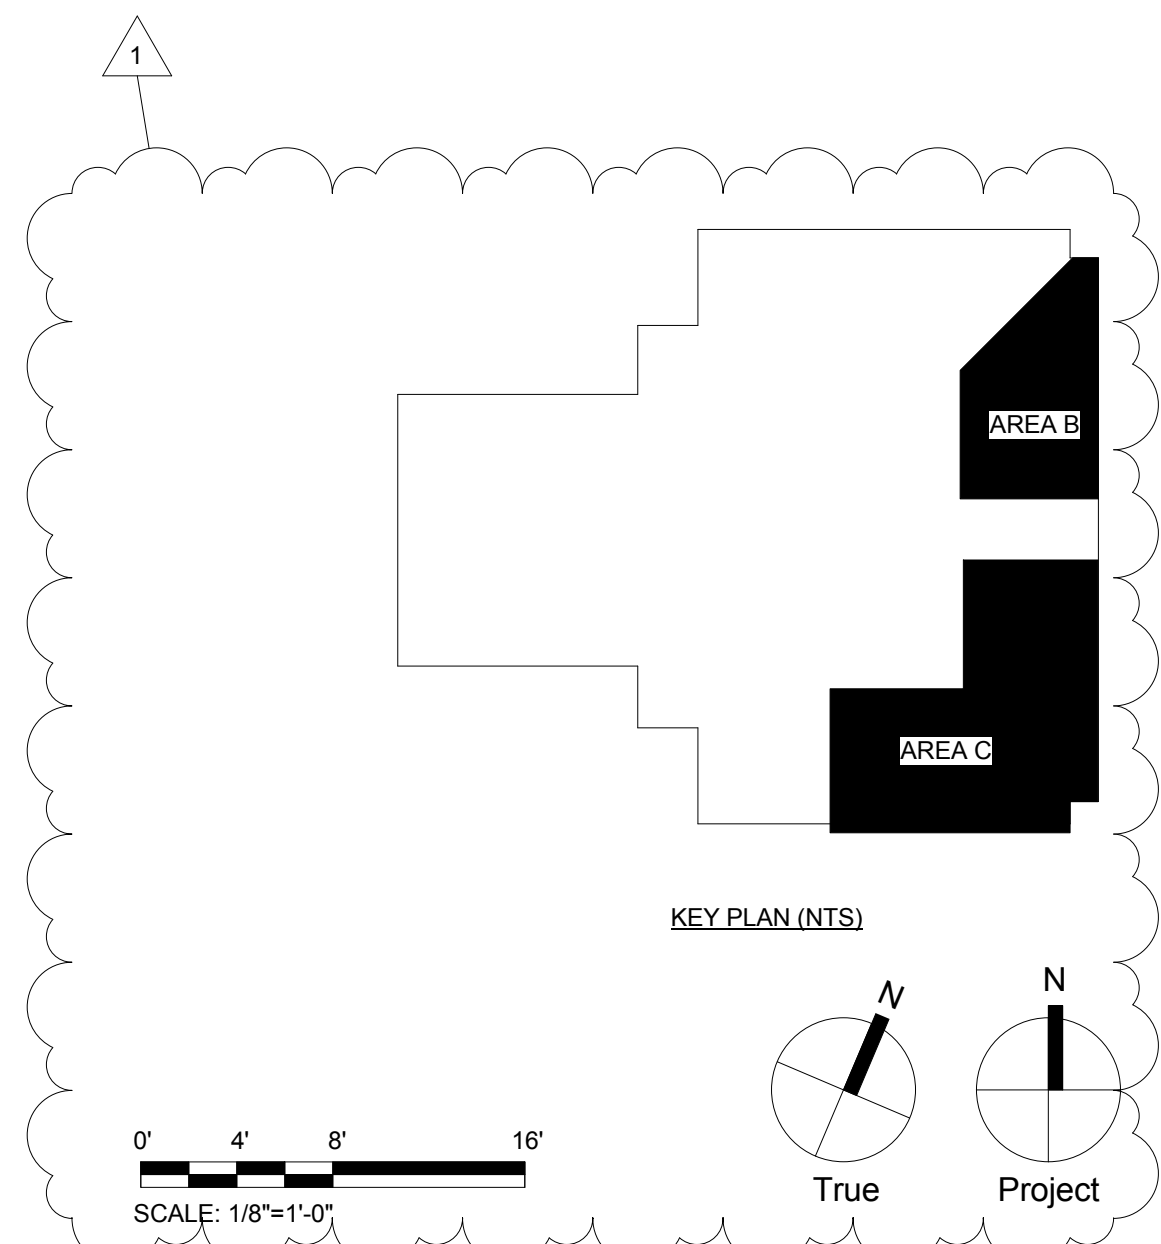

SEAL:

Farhad Mojidi, PA PE Stamp.png

NAME (LICENSED PROFESSIONAL) DATE
STATE AND LICENSE NO. XX/XX/20XX

Architectural:
SCHRADERGROUP Architectue, LLC
Address: 161 Leverington Ave, Suite 105, Philadelphia PA 19127
Phone: 215.492.7440
Fax: 215.492.7441
Email: bgood@sgarc.com
Attn: Brian Good


MEP:
GES
Global Engineering Solutions®
Address: 6700A Rockledge Drive, Suite 301 Bethesda Maryland 20817
Phone: 301.216.2871
Fax: 301.216.9871
Email: anig@thesges.com
Attn: Anil Giri

GENERAL NOTES

- SEE DRAWING E001 FOR ELECTRICAL SYMBOLS, GENERAL NOTES AND ABBREVIATIONS.

SPECIFIC NOTES

- EXISTING 25A, 3P, 4W, 277/480V WITH 200A MCB.
- PROVIDE 25A, 3P, 480V CIRCUIT BREAKER IN EXISTING BLANK SPACES. ELECTRICAL CHARACTERISTICS (AIC AND TYPE) OF THE NEW CIRCUIT BREAKER SHALL MATCH EXISTING CIRCUIT BREAKER.
- 15KVA, 480V DELTA PRIMARY/ 208Y/120 SECONDARY K13 COPPER WINDING TRANSFORMER.
- 3#10-1#10G-3/4"C.
- 4#6-1#10G-1"C.

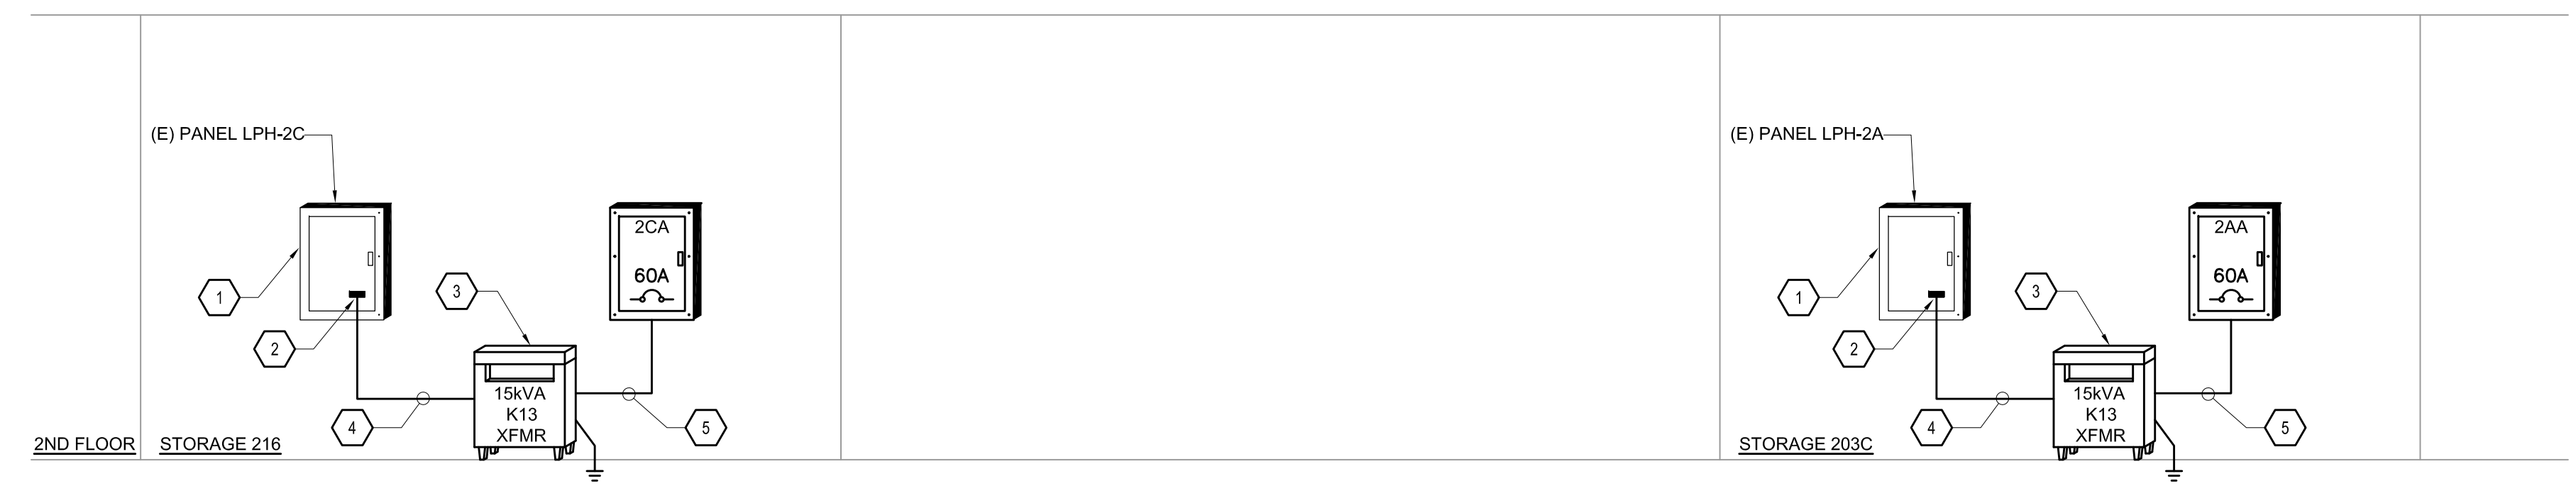

1 PARTIAL POWER RISER DIAGRAM
SCALE: N.T.S.

PANELBOARD NAME: 2CA (NEW) (NEW)														
VOLTAGE: 208Y/120V BUS RATING: 100A POLES: 30 MINIMUM A.I.C. RATING (A): 14,000														
PHWIRE: 3 PHASE, 4 WIRE + GROUND MAIN: 60A MCB MOUNTING: SURFACE SERVICE: NORMAL														
CKT NO.	LOAD TYPE	LOAD DESCRIPTION	BKR P	LOAD (VA)	PHASE LOAD (VA)			LOAD (VA)	BKR P	LOAD DESCRIPTION	LOAD TYPE	CKT NO.		
					A	B	C							
1	R	CLASSROOM 201 REC.	1	20	1080	2160		1080	1	20	CLASSROOM 203 REC.	R	2	
3	R	CLASSROOM 201 REC.	1	20	720		1440	720	1	20	CLASSROOM 203 REC.	R	4	
5	R	CLASSROOM 201 REC.	1	20	180			360	180	1	20	CLASSROOM 203 REC.	R	6
7	R	CLASSROOM 205 REC.	1	20	1080	2160		1080	1	20	CLASSROOM 207 REC.	R	8	
9	R	CLASSROOM 205 REC.	1	20	720		1440	720	1	20	CLASSROOM 207 REC.	R	10	
11	R	CLASSROOM 205 REC.	1	20	180			360	180	1	20	CLASSROOM 207 REC.	R	12
13	R	CLASSROOM 209 REC.	1	20	1080	2160		1080	1	20	CLASSROOM 211 REC.	R	14	
15	R	CLASSROOM 209 REC.	1	20	720		1440	720	1	20	CLASSROOM 211 REC.	R	16	
17	R	CLASSROOM 209 REC.	1	20	180			360	180	1	20	CLASSROOM 211 REC.	R	18
19	SPARE		1	20						1	20	SPARE		20
21	SPARE		1	20						1	20	SPARE		22
23	SPARE		1	20						1	20	SPARE		24
25	SPARE		1	20						1	20	SPARE		26
27	SPARE		1	20						1	20	SPARE		28
29	SPARE		1	20						1	20	SPARE		30
TOTAL CONNECTED LOAD (A):				33.0	18.0	12.0	3.0	(AMPS/PHASE)			#BOLD INDICATES NEW			
TOTAL CONNECTED LOAD (VA):				11,880	6,480	4,320	1,080	(VA/PHASE)						

PROVIDE ITEMS MARKED BELOW :		LOAD TYPE		CONNECTED		DEMAND	
		VA	AMPS	VA	AMPS	VA	AMPS
<input checked="" type="checkbox"/>	DOOR-IN-DOOR CONSTRUCTION						
<input type="checkbox"/>	SHUNT TRIP ON MAIN DEVICE						
<input type="checkbox"/>	FEED THRU LUGS						
<input type="checkbox"/>	SERVICE NEUTRAL						
<input type="checkbox"/>	ISOLATED GROUND BUS						
<input type="checkbox"/>	200% NEUTRAL						
<input type="checkbox"/>	NEMA 3R						
<input checked="" type="checkbox"/>	OTHER: PROVIDE PANEL W/ INTEGRA SURGE PROTECTION (SDP)						
TOTAL CONNECTED & DEMAND LOAD :		11.88 (kVA)		10.94 (kVA)			
TOTAL CONNECTED & DEMAND LOAD :		32.98 (A)		30.37 (A)			

PANELBOARD NAME: 2AA (NEW) (NEW)														
VOLTAGE: 208Y/120V BUS RATING: 100A POLES: 30 MINIMUM A.I.C. RATING (A): 14,000														
PHWIRE: 3 PHASE, 4 WIRE + GROUND MAIN: 60A MCB MOUNTING: SURFACE SERVICE: NORMAL														
CKT NO.	LOAD TYPE	LOAD DESCRIPTION	BKR P	LOAD (VA)	PHASE LOAD (VA)			LOAD (VA)	BKR P	LOAD DESCRIPTION	LOAD TYPE	CKT NO.		
					A	B	C							
1	R	CLASSROOM 208 REC.	1	20	1080	2160		1080	1	20	CLASSROOM 204 REC.	R	2	
3	R	CLASSROOM 208 REC.	1	20	720		1440	720	1	20	CLASSROOM 204 REC.	R	4	
5	R	CLASSROOM 208 REC.	1	20	180			360	180	1	20	CLASSROOM 204 REC.	R	6
7	R	CLASSROOM 202 REC.	1	20	1080	1080				1	20	SPARE		8
9	R	CLASSROOM 202 REC.	1	20	720		720			1	20	SPARE		10
11	R	CLASSROOM 202 REC.	1	20	180			180		1	20	SPARE		12
13	SPARE		1	20						1	20	SPARE		14
15	SPARE		1	20						1	20	SPARE		16
17	SPARE		1	20						1	20	SPARE		18
19	SPARE		1	20						1	20	SPARE		20
21	SPARE		1	20						1	20	SPARE		22
23	SPARE		1	20						1	20	SPARE		24
25	SPACE		--							--		SPACE		26
27	SPACE		--							--		SPACE		28
29	SPACE		--							--		SPACE		30
TOTAL CONNECTED LOAD (A):				16.5	9.0	6.0	1.5	(AMPS/PHASE)			#BOLD INDICATES NEW			
TOTAL CONNECTED LOAD (VA):				5,940	3,240	2,160	540	(VA/PHASE)						

PROVIDE ITEMS MARKED BELOW :		LOAD TYPE		CONNECTED		DEMAND	
		VA	AMPS	VA	AMPS	VA	AMPS
<input checked="" type="checkbox"/>	DOOR-IN-DOOR CONSTRUCTION						
<input type="checkbox"/>	SHUNT TRIP ON MAIN DEVICE						
<input type="checkbox"/>	FEED THRU LUGS						
<input type="checkbox"/>	SERVICE NEUTRAL						
<input type="checkbox"/>	ISOLATED GROUND BUS						
<input type="checkbox"/>	200% NEUTRAL						
<input type="checkbox"/>	NEMA 3R						
<input checked="" type="checkbox"/>	OTHER: PROVIDE PANEL W/ INTEGRA SURGE PROTECTION (SDP)						
TOTAL CONNECTED & DEMAND LOAD :		5.94 (kVA)		5.94 (kVA)			
TOTAL CONNECTED & DEMAND LOAD :		16.49 (A)		16.49 (A)			

BID DOCUMENTS
APRIL 20, 2018

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NO. DATE REVISION

SCHOOL & LOCATION

Edward T. Steel Elementary School
4301 Wayne Avenue, Philadelphia, PA 19140

PROJECT TITLE

Classroom Modifications to Edward T. Steel Elementary School

DRAWING TITLE

POWER RISER AND PANELBOARD SCHEDULES


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B-070 C	OF 2017/18

DRAWING NO.
E401


SEAL:

Architectural: SCHRADERGROUP Architecture, LLC Address: 161 Leverington Ave, Suite 105, Philadelphia PA 19127 Phone: 215.482.7440 Fax: 215.482.7441 Email: bgood@grarc.com Attn: Brian Good

MEP: GES Global Engineering Solutions® Address: 6700A Rockledge Drive, Suite 301 Bethesda Maryland 20817 Phone: 301.216.9271 Fax: 301.216.9671 Email: arilg@theGES.com Attn: Aril Gil

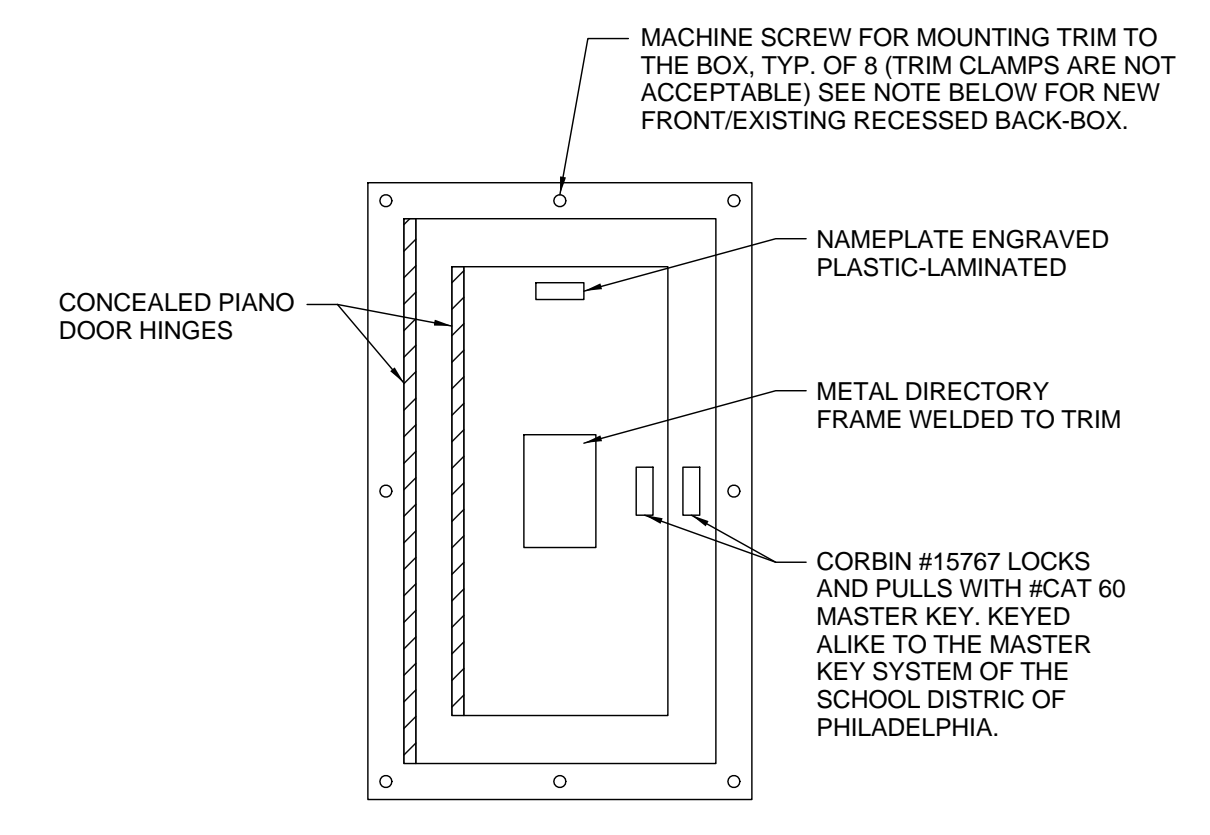


3 PANELBOARD FRONT STANDARD DETAIL NTS

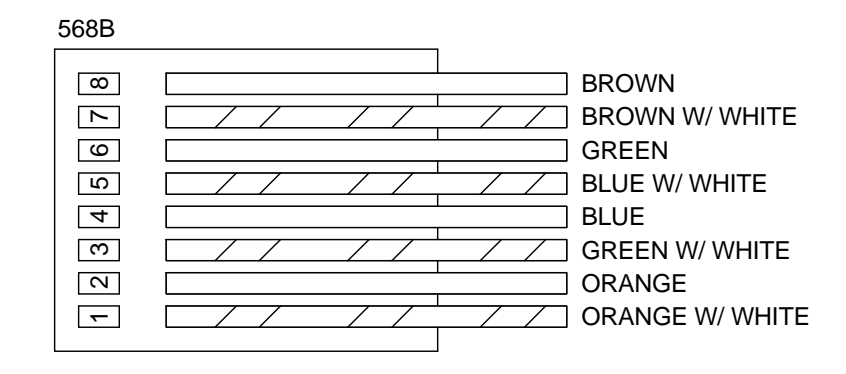


NOTE 1. ALL RJ45 TERMINATION POINTS SHALL BE CONFIGURED TO THE EIA/TIA 568B STANDARD UNLESS SPECIFICALLY DIRECTED OTHERWISE BY SDP AUTHORIZED REPRESENTATIVE.

4 RJ45 TERMINATION DETAIL NTS

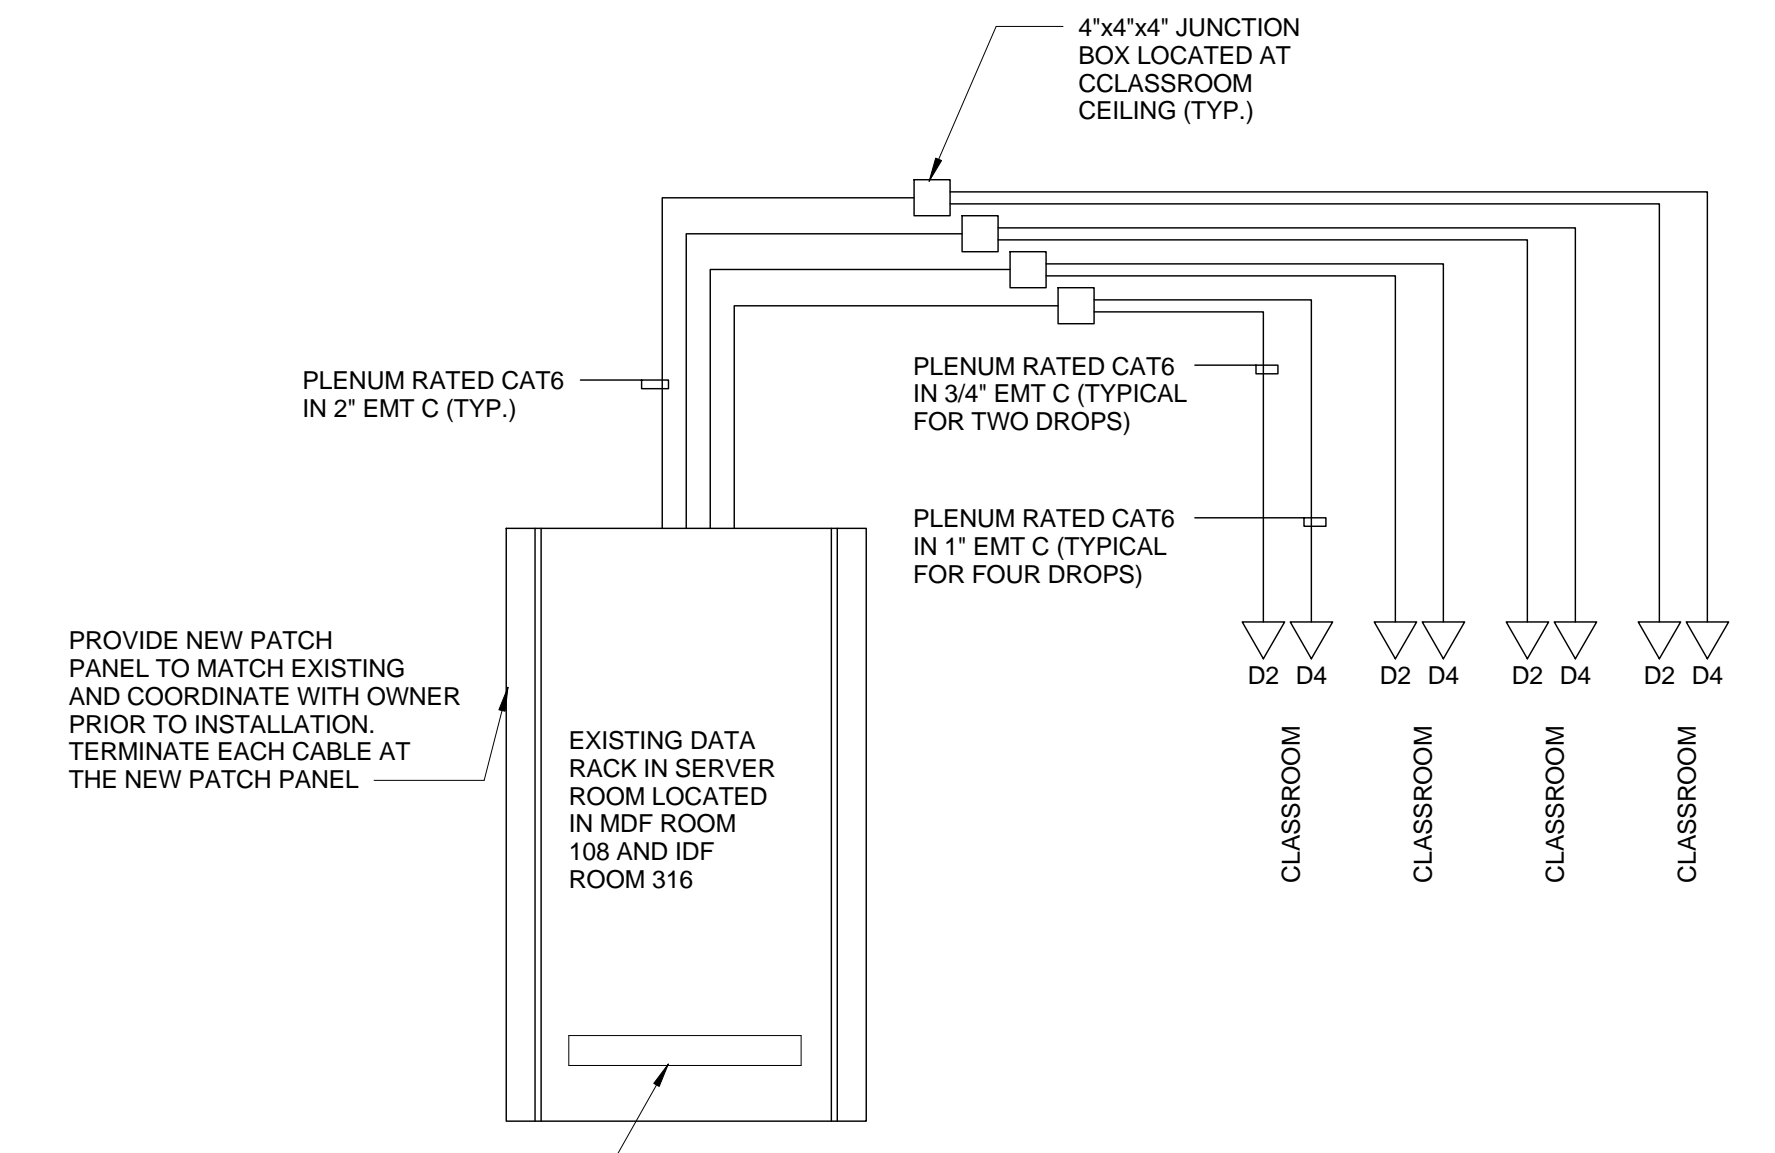

NOTES 1. ELECTRICAL CONTRACTOR IS TO TEST EACH INDIVIDUAL DATA DROP AFTER TERMINATION AND PROVIDE A REPORT OF ALL DROPS TO SDP IT DEPARTMENT. SDP IT DEPARTMENT WILL BE RESPONSIBLE FOR FINAL CONNECTION AND ACTIVATION. 2. FOR EXACT NUMBER AND LOCATION OF DATA OUTLETS SEE POWER FLOOR PLANS NEW WORK. 3. FOR ALL COMMUNICATION REQUIREMENT SEE SPECIFICATION 271300 (COMMUNICATION SYSTEM).

1 DATA RISER DIAGRAM NTS

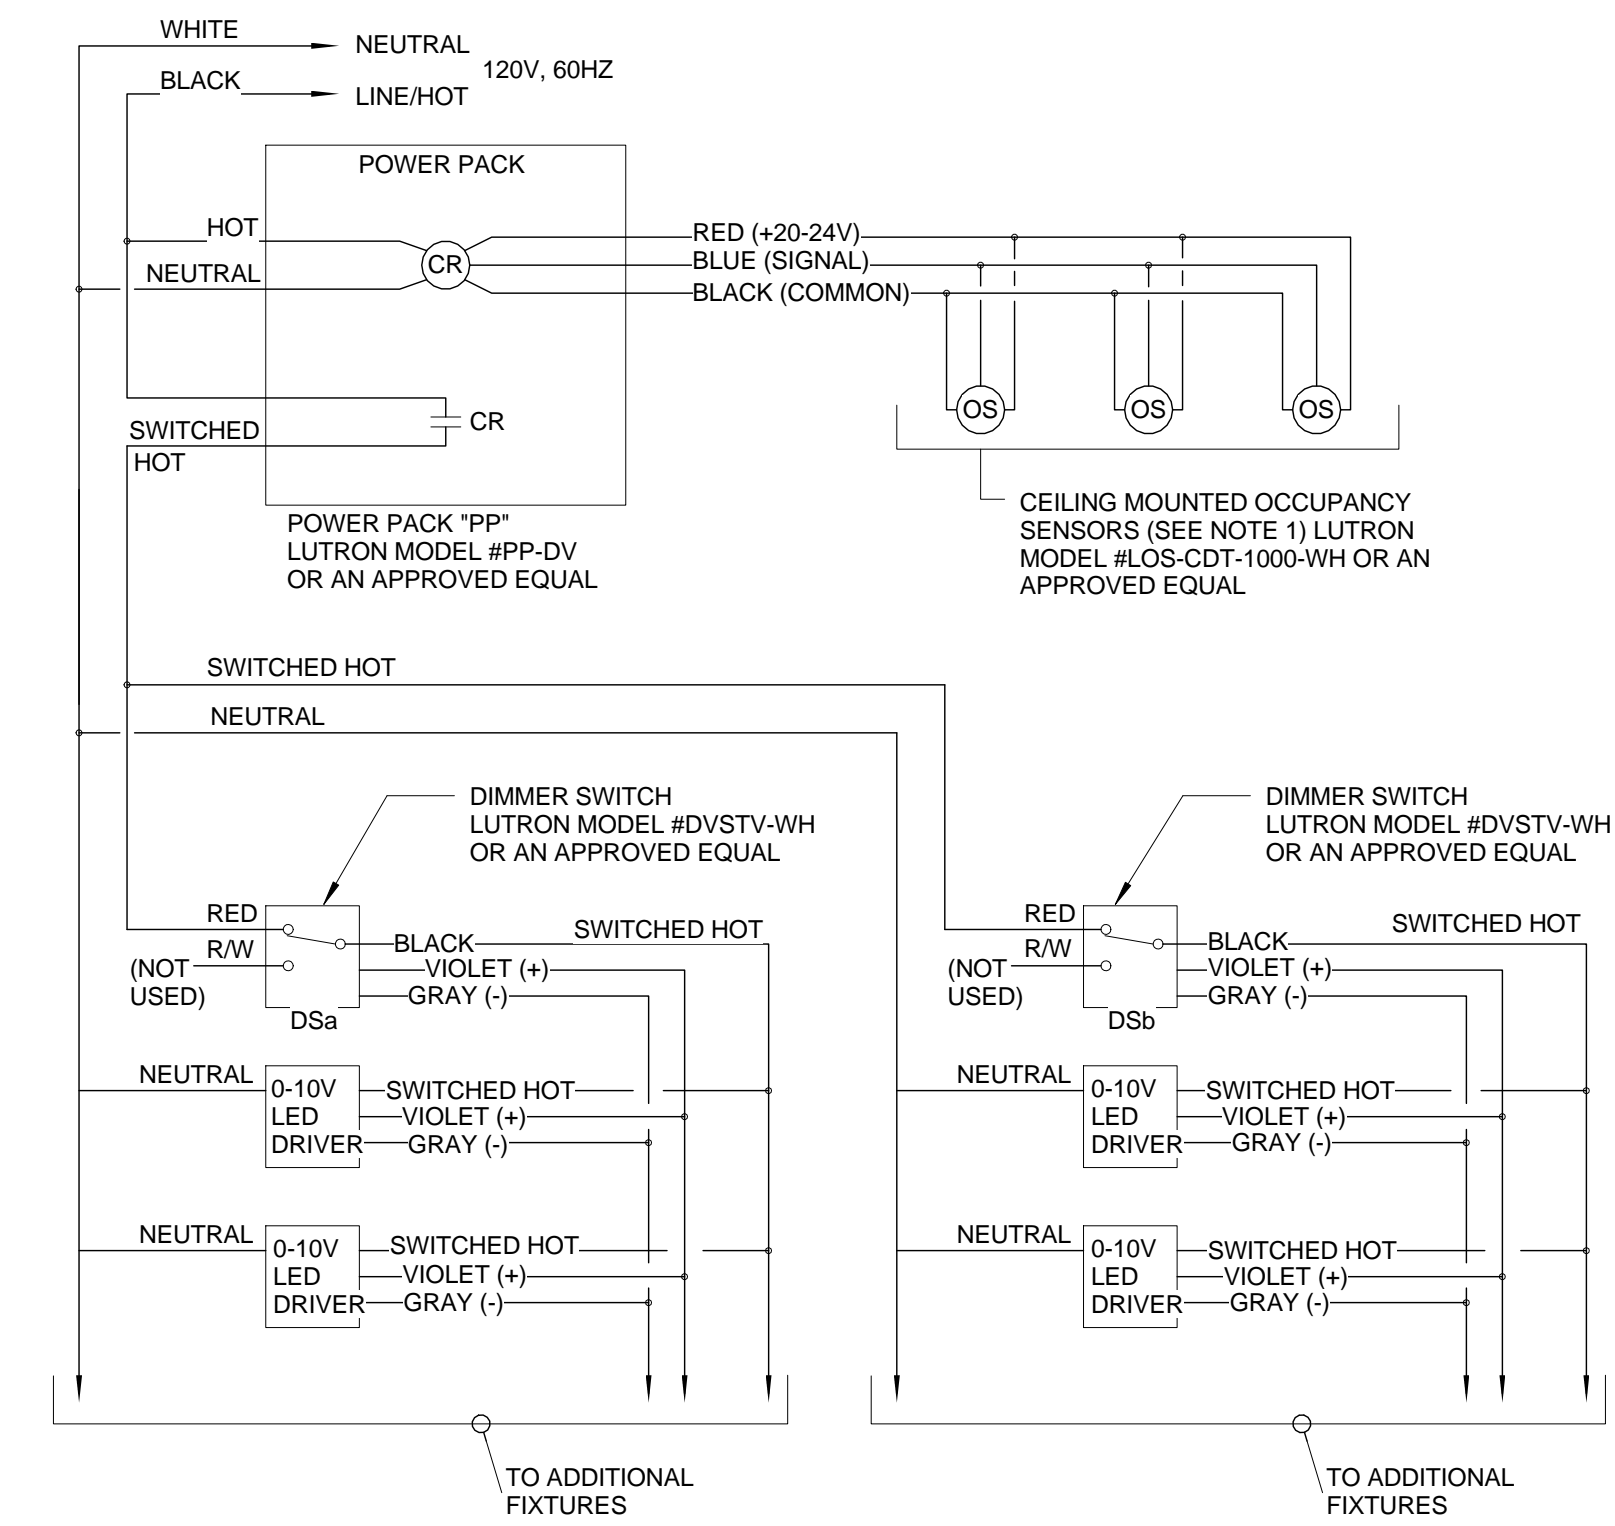

NOTES 1. MAXIMUM COMBINATION OF THREE OCCUPANCY SENSORS AND/OR RELAY UNITS PER CONTROL UNIT. 2. CONTRACTOR SHALL VERIFY CONTROLS COMPATIBILITY OF ALL DEVICE AND FIXTURE WITH MANUFACTURERS PRIOR TO PURCHASE. 3. DIAGRAM IS SCHEMATIC AND TO SHOW DESIGN INTENT AND IT IS BASED ON LUTRON PRODUCTS; CONTRACTOR SHALL VERIFY EXACT WIRING CONFIGURATION AND REQUIREMENTS PRIOR TO CONSTRUCTION.

2 TYPICAL CLASSROOM LED LIGHTING CONTROL SCHEMATIC CEILING OCCUPANCY SENSOR WITH TWO DIMMER SWITCHES NTS

BID DOCUMENTS APRIL 20, 2018

Table with 3 columns: NO., DATE, REVISION

SCHOOL & LOCATION Edward T. Steel Elementary School 4301 Wayne Avenue, Philadelphia, PA 19140

PROJECT TITLE Classroom Modifications to Edward T. Steel Elementary School

DRAWING TITLE ELECTRICAL DETAILS

Table with 2 columns: LOCATION NO., FILE NO. and DRAWN BY, CHECKED BY

DRAWING NO. E501

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2

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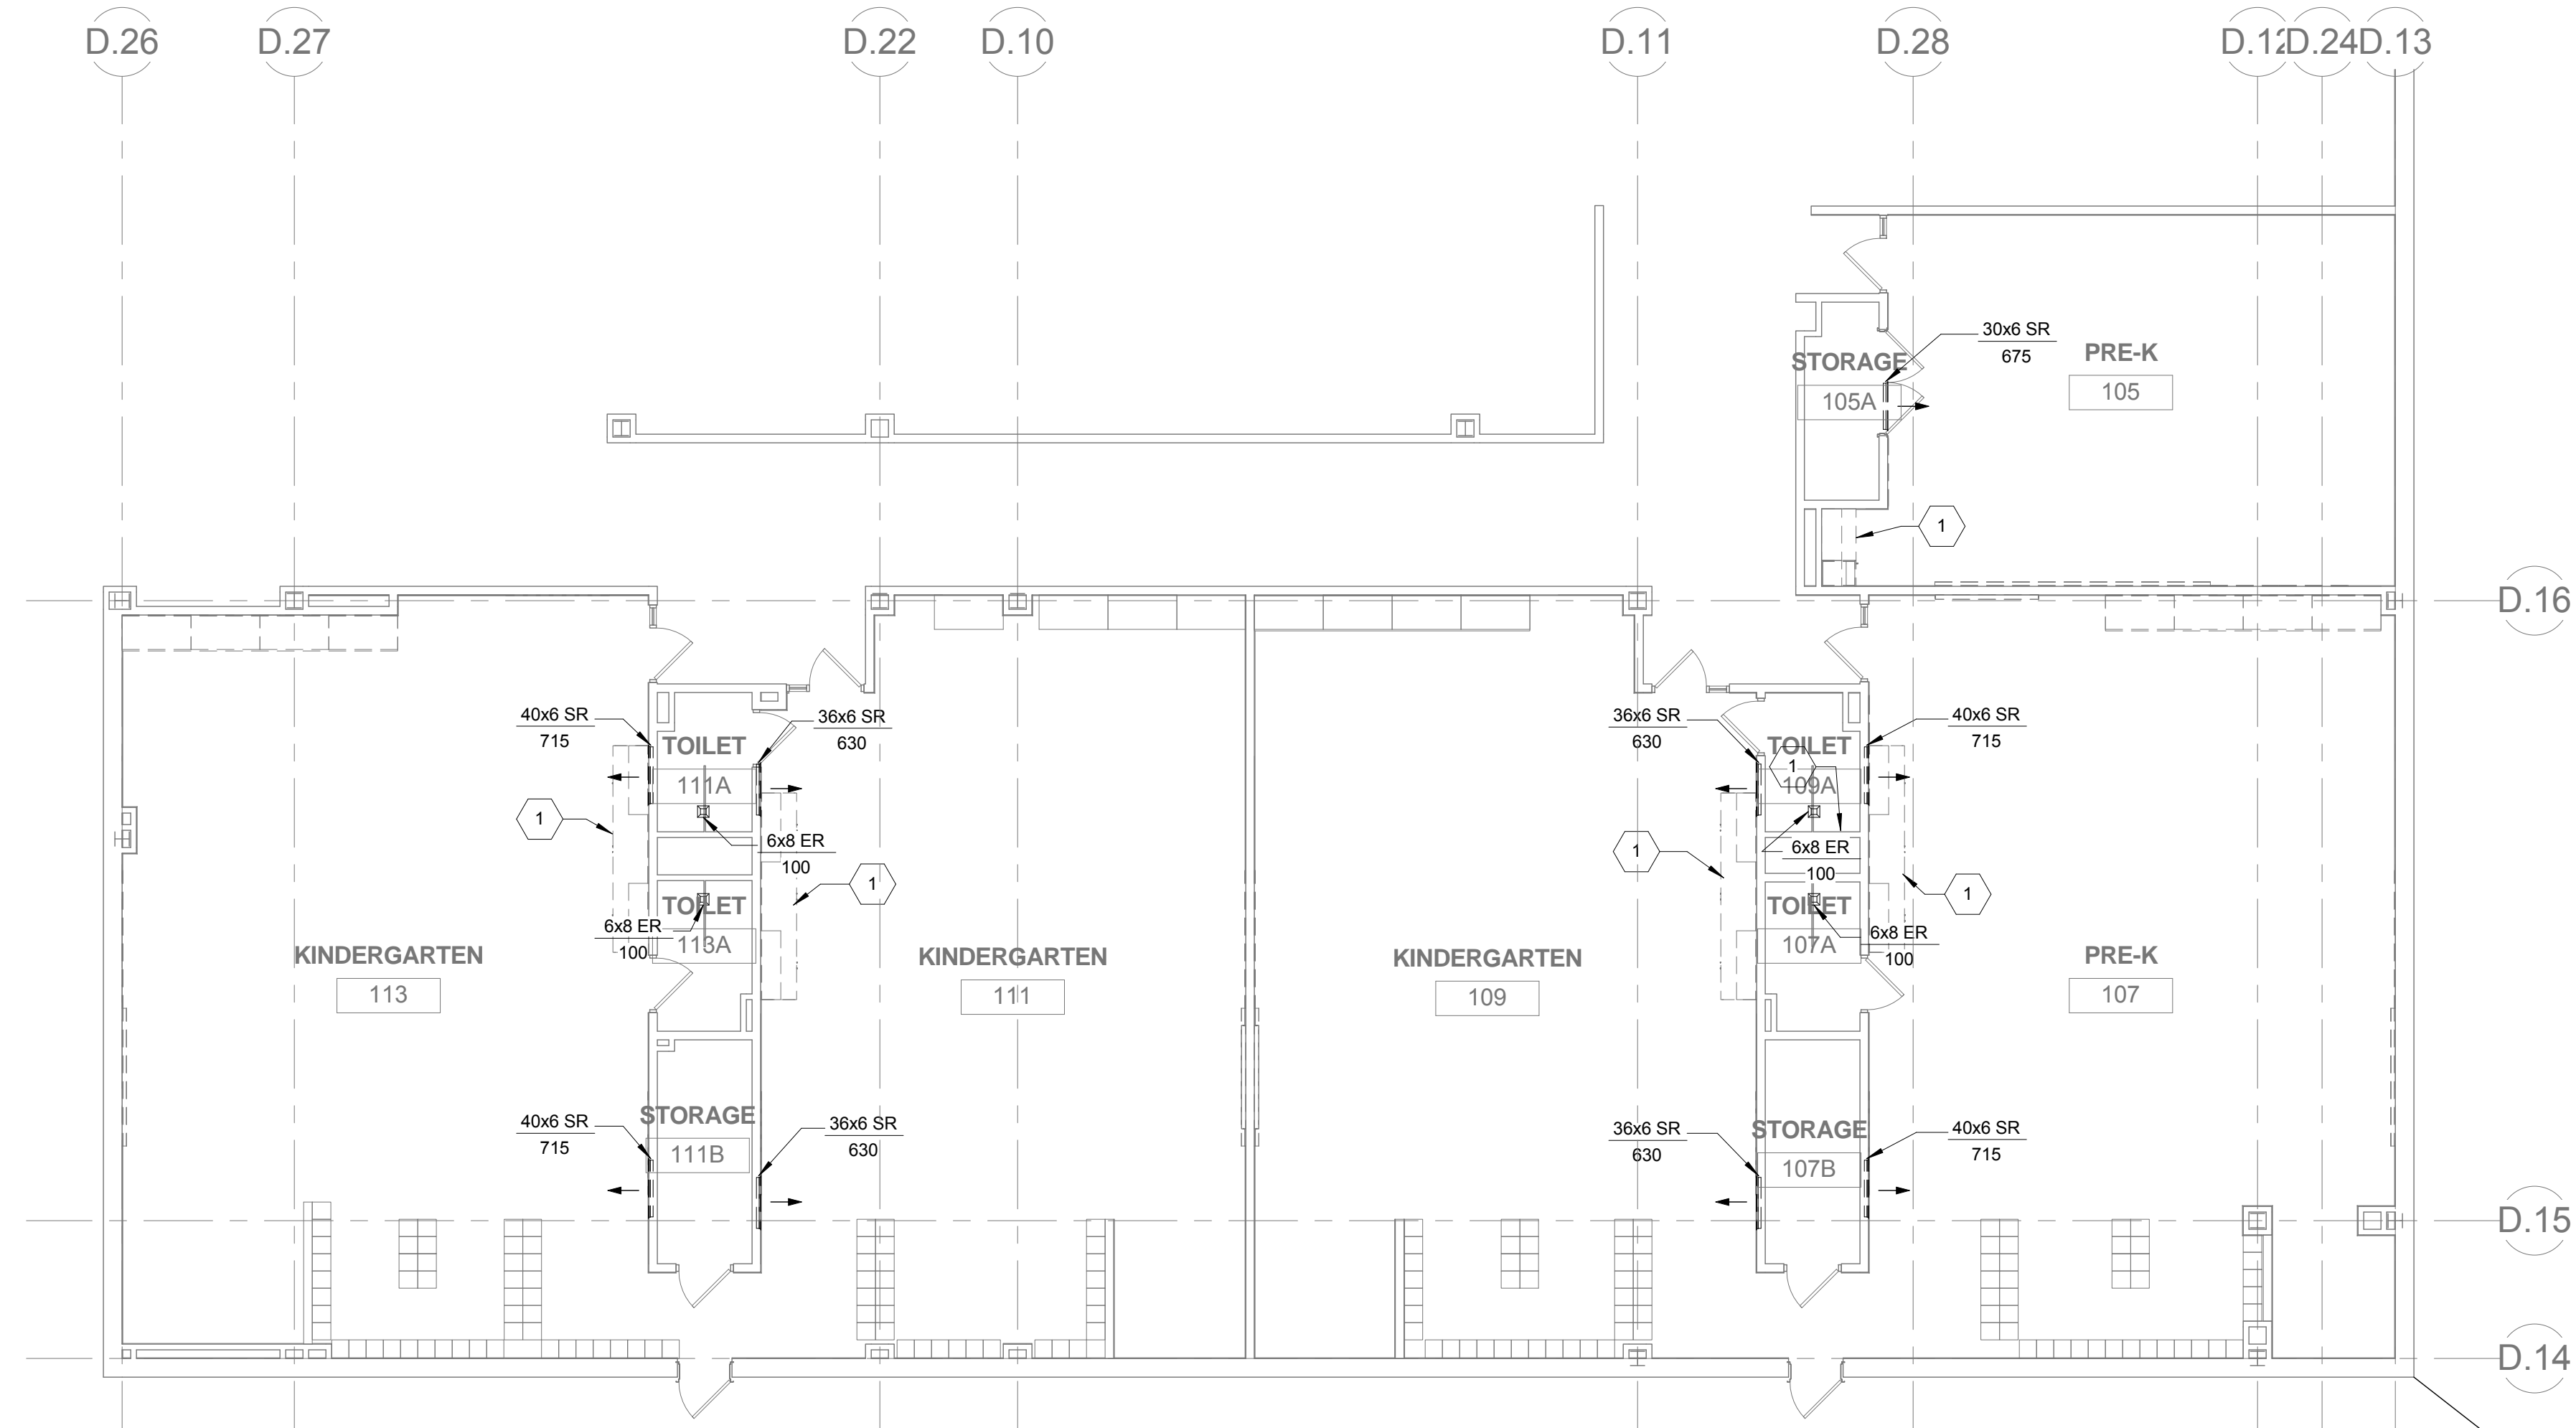
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1 FIRST LEVEL - MECHANICAL AND PLUMBING FLOOR PLAN - DEMOLITION
1/8" = 1'-0"

GENERAL NOTES

- REFER TO M001 FOR GENERAL NOTES, SYMBOL LEGEND AND LIST OF ABBREVIATIONS.
- DEMOLISH AIR DEVICES AS SHOWN ON FLOOR PLANS.

KEYED NOTES

- DEMOLISH AND DISPOSE OF PLUMBING FIXTURE. CAP EXISTING STUB-OUTS FOR CONNECTION TO NEW FIXTURE.

SEAL:



Vassilis K. Skarlis STATE AND LICENSE NO. PA PE081586 DATE 09/30/2019

Architectural:
SCHRADERGROUP Architecture, LLC
Address: 161 Leverington Ave, Suite 105, Philadelphia PA 19127
Phone: 215.482.7440
Fax: 215.482.7441
Email: bgoode@grarc.com
Attn: Brian Good

MEP:
GES
Global Engineering Solutions®
Address: 6700A Rockledge Drive, Suite 301 Bethesda Maryland 20817
Phone: 301.216.2871
Fax: 301.216.9671
Email: arily@theges.com
Attn: Aril Gil

BID DOCUMENTS
APRIL 20, 2018

NO.	DATE	REVISION
1	05/09/18	ADDENDUM 1




SCHOOL & LOCATION
Edward T. Steel Elementary School
4301 Wayne Avenue, Philadelphia, PA 19140

PROJECT TITLE
Classroom Modifications to Edward T. Steel Elementary School

DRAWING TITLE
FIRST LEVEL - MECHANICAL AND PLUMBING FLOOR PLAN - DEMOLITION

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XX-XXX	
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	2017/18 2017/18

DRAWING NO.
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GENERAL NOTES

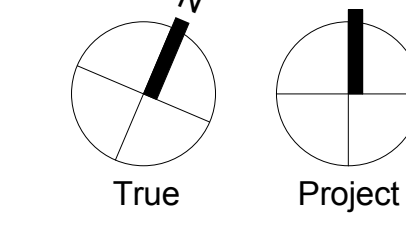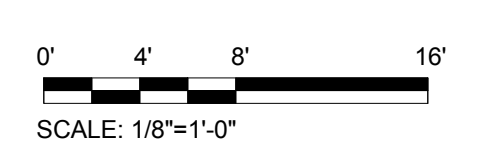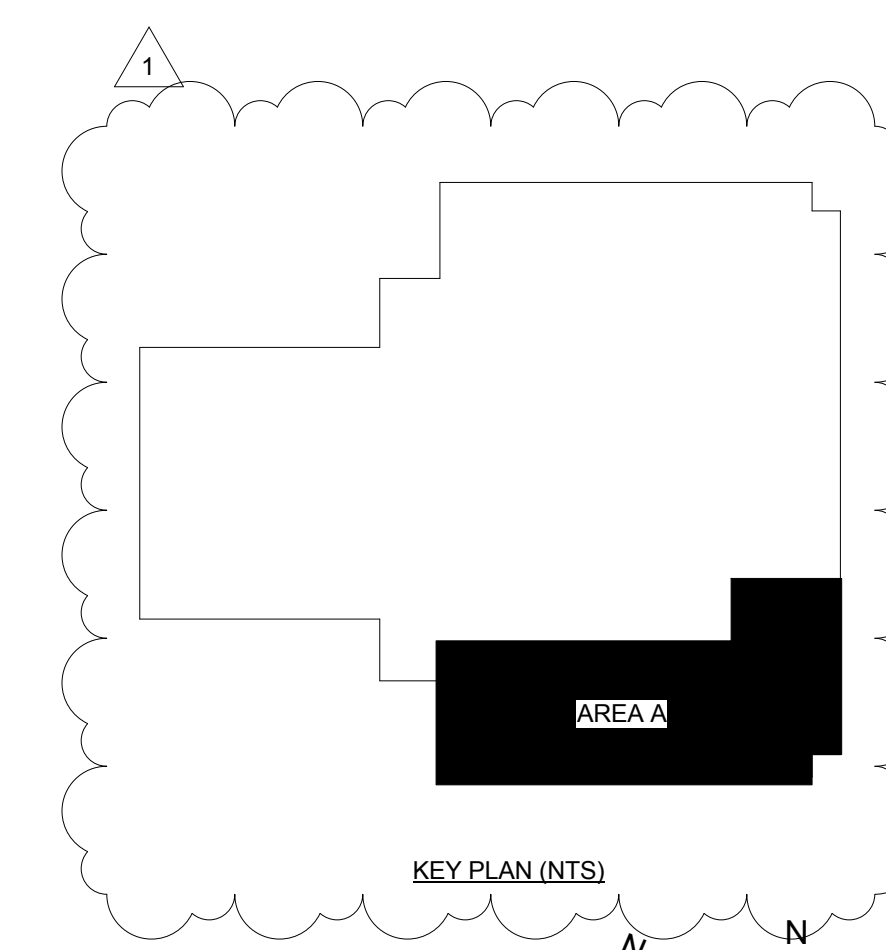1. REFER TO M001 FOR GENERAL NOTES, SYMBOL LEGEND AND LIST OF ABBREVIATIONS.
2. DEMOLISH AIR DEVICES AS SHOWN ON FLOOR PLANS.

KEYED NOTES

1. DEMOLISH AND DISPOSE OF PLUMBING FIXTURE, CAP EXISTING STUB-OUTS FOR CONNECTION TO NEW FIXTURE.

SEAL:



Vassilis K. Stamboulis STATE AND LICENSE NO. PA PEB01586 DATE 09/30/2019

Architectural:
SCHRADERGROUP Architecture, LLC
Address: 161 Leverington Ave, Suite 105, Philadelphia PA 19127
Phone: 215.482.7440
Fax: 215.482.7441
Email: bg009@grarc.com
Attn: Brian Good

MEP:
GES
Global Engineering Solutions®
Address: 6700A Rockledge Drive, Suite 301 Bethesda Maryland 20817
Phone: 301.216.2871
Fax: 301.216.9671
Email: arnlj@thejes.com
Attn: Arnlj Gil

BID DOCUMENTS
APRIL 20, 2018

NO.	DATE	REVISION
1	05/09/18	ADDENDUM 1

SCHOOL & LOCATION
Edward T. Steel Elementary School
4301 Wayne Avenue, Philadelphia, PA 19140

PROJECT TITLE
Classroom Modifications to Edward T. Steel Elementary School


DRAWING TITLE
SECOND LEVEL - MECHANICAL AND PLUMBING FLOOR PLAN - DEMOLITION

LOCATION NO.	FILE NO.
XX-XXX	



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HS	AG

	OF	2017/18
B-067 C	OF	2017/18
B-070 C	OF	2017/18

DRAWING NO.
MD112

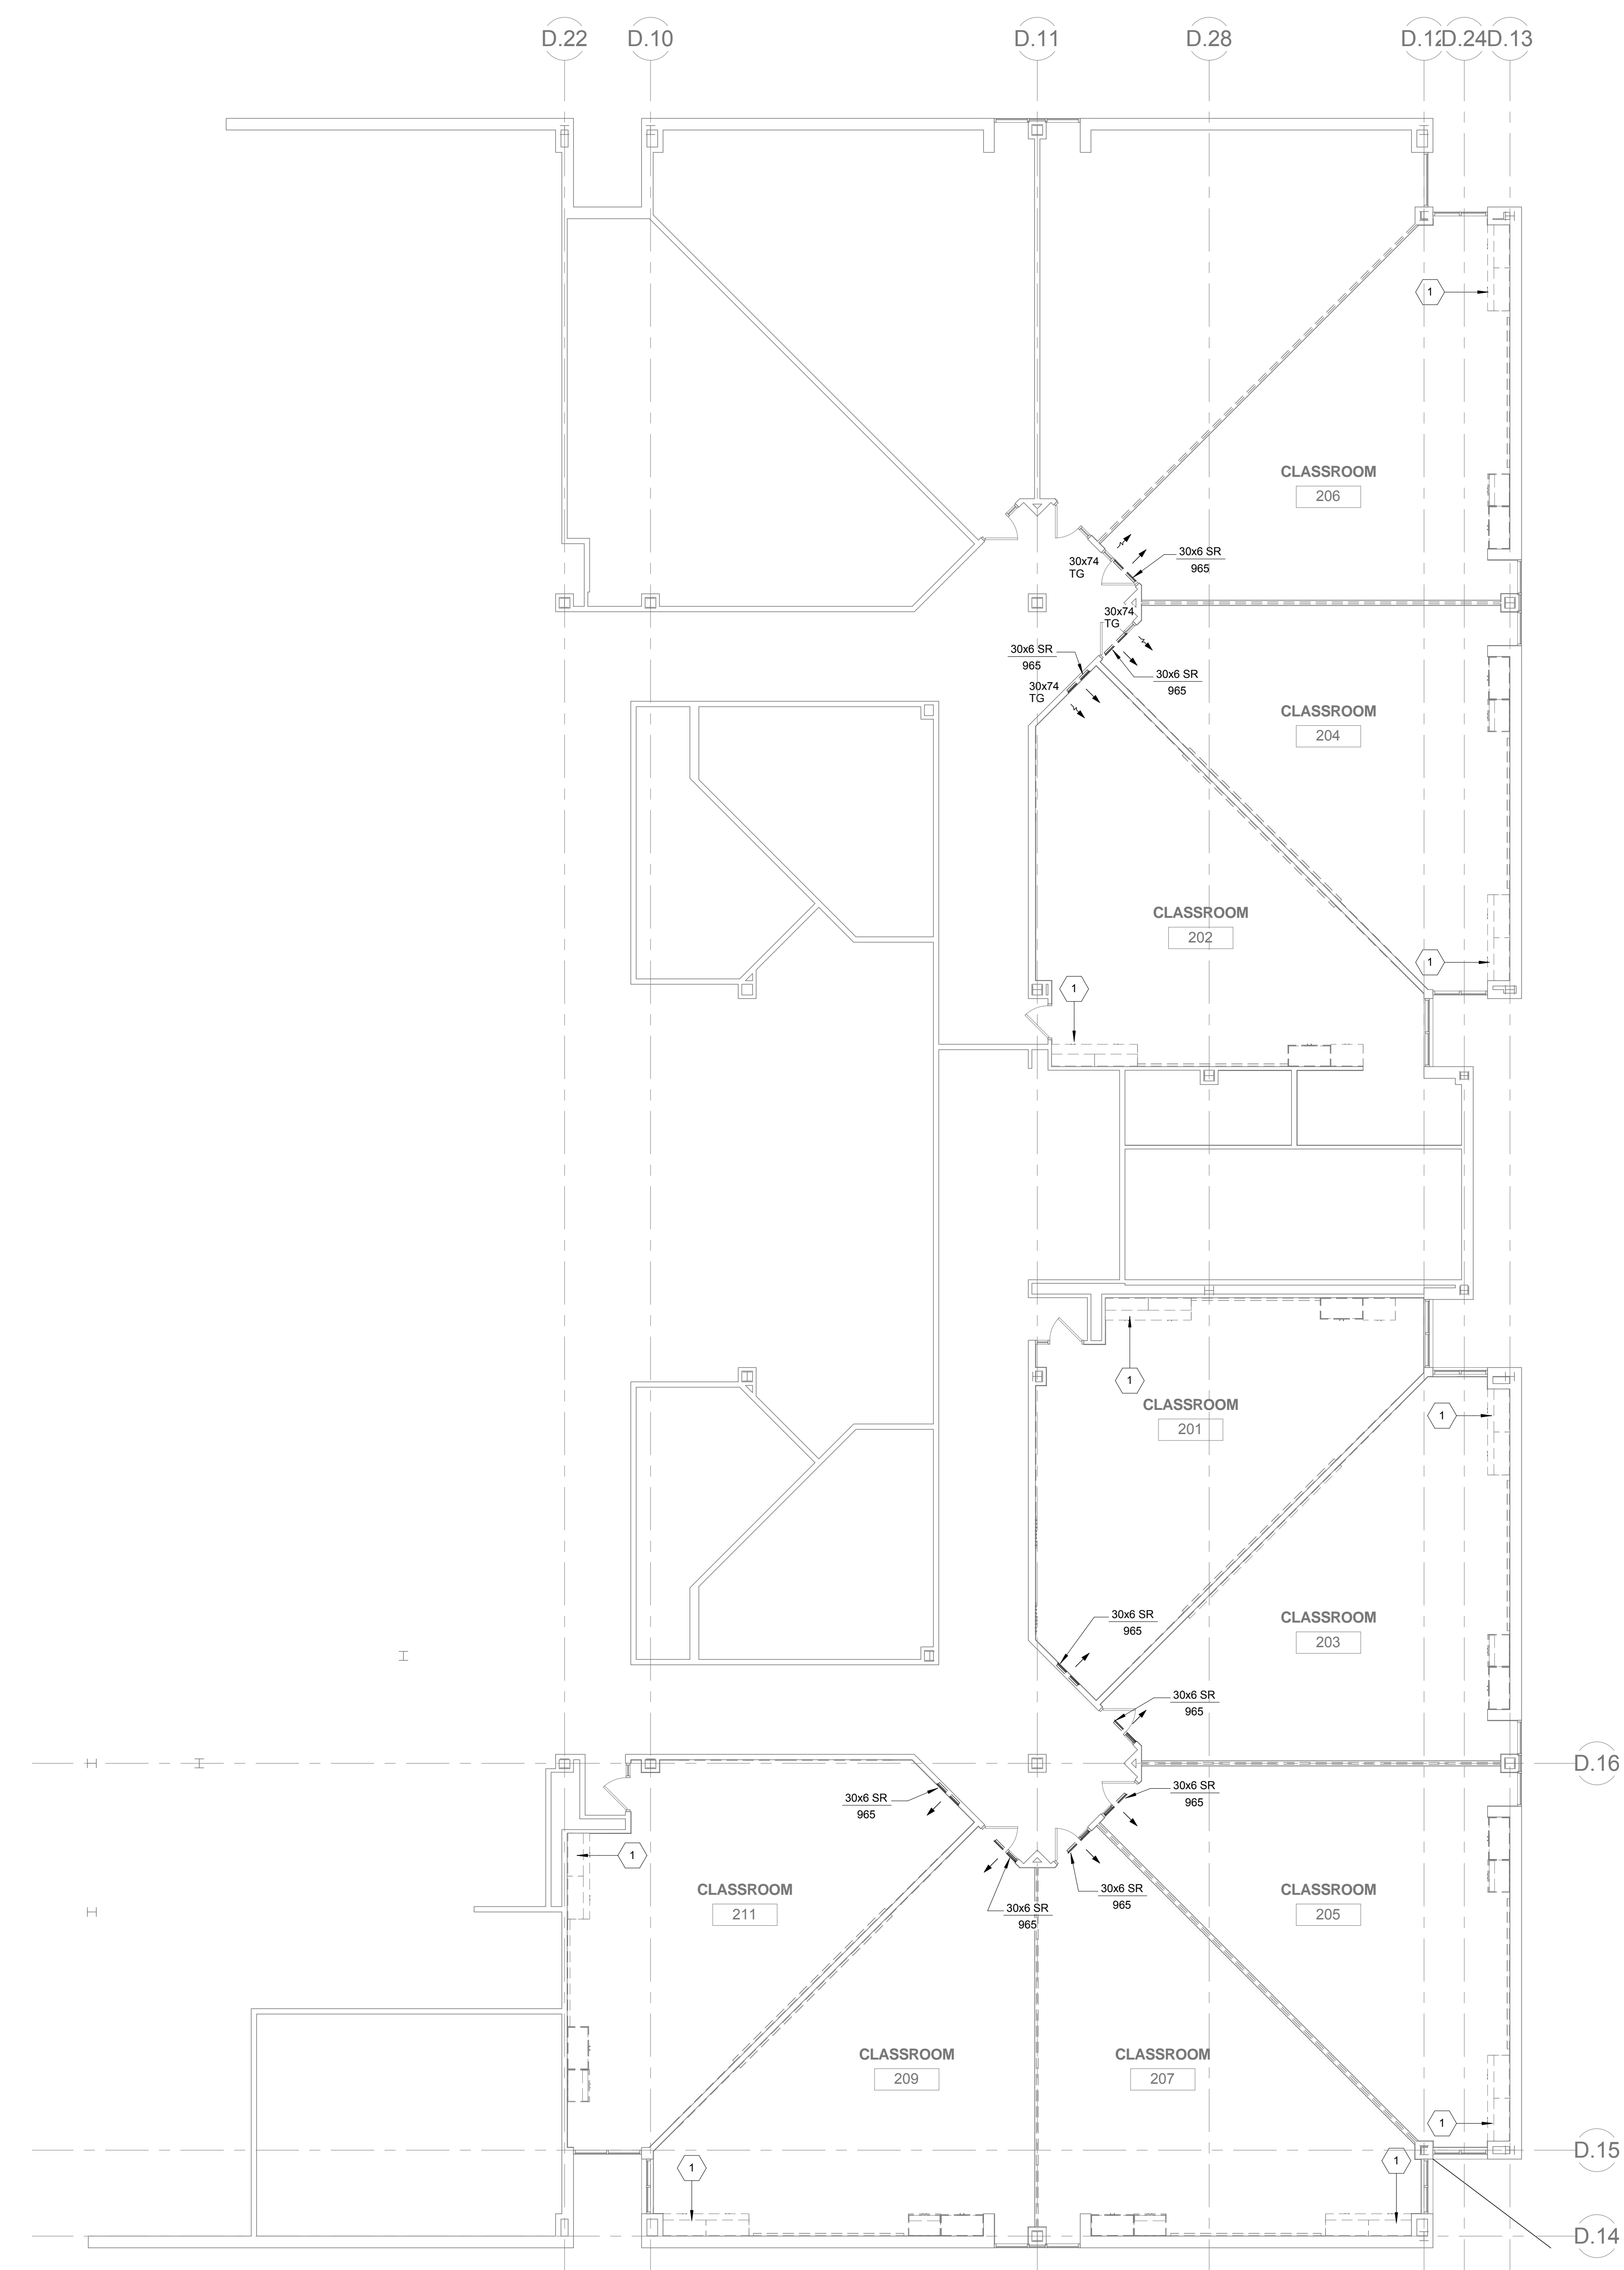

1 SECOND LEVEL - MECHANICAL AND PLUMBING FLOOR PLAN - DEMOLITION
1/8" = 1'-0"

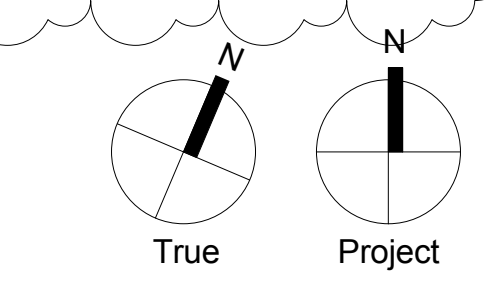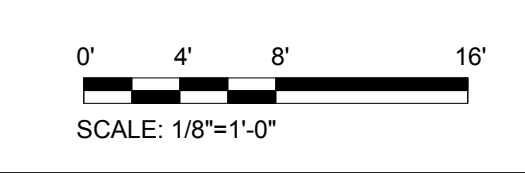

1
A
B
C
D
E
F

2 3 4 5 6 7 8

A

B

C

D

E


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GENERAL NOTES

- REFER TO M001 FOR GENERAL NOTES, SYMBOL LEGEND AND LIST OF ABBREVIATIONS.
- PROVIDE AIR DEVICES. PROVIDE FRAME TYPE AS REQUIRED PER INSTALLATION. PROVIDE OPPOSED BLADE DAMPER FOR SUPPLY REGISTERS. COORDINATE COLOR WITH ARCHITECT PRIOR TO PURCHASE. ALL AIR DEVICES SHALL BE ALUMINUM. SUPPLY REGISTER (SR) SHALL BE TITUS 301 FL OR APPROVED EQUAL. TRANSFER GRILLE SHALL BE TITUS 355 FL OR APPROVED EQUAL.

KEYED NOTES

- PROVIDE PLUMBING FIXTURE IN KIND. PROVIDE VALVES AND ACCESSORIES FOR FULL FUNCTIONALITY. CONNECT NEW FIXTURE TO EXISTING PIPING. VERIFY SIZE AND LOCATION OF EXISTING PIPING IN FIELD.
- PROVIDE STAINLESS STEEL SINK ELKAY LR1517 WITH CHICAGO FAUCET 786-CP OR APPROVED EQUAL. PROVIDE VALVES AND ACCESSORIES FOR FULL FUNCTIONALITY. CONNECT NEW FIXTURE TO EXISTING PIPING. VERIFY SIZE AND LOCATION OF EXISTING PIPING IN FIELD.

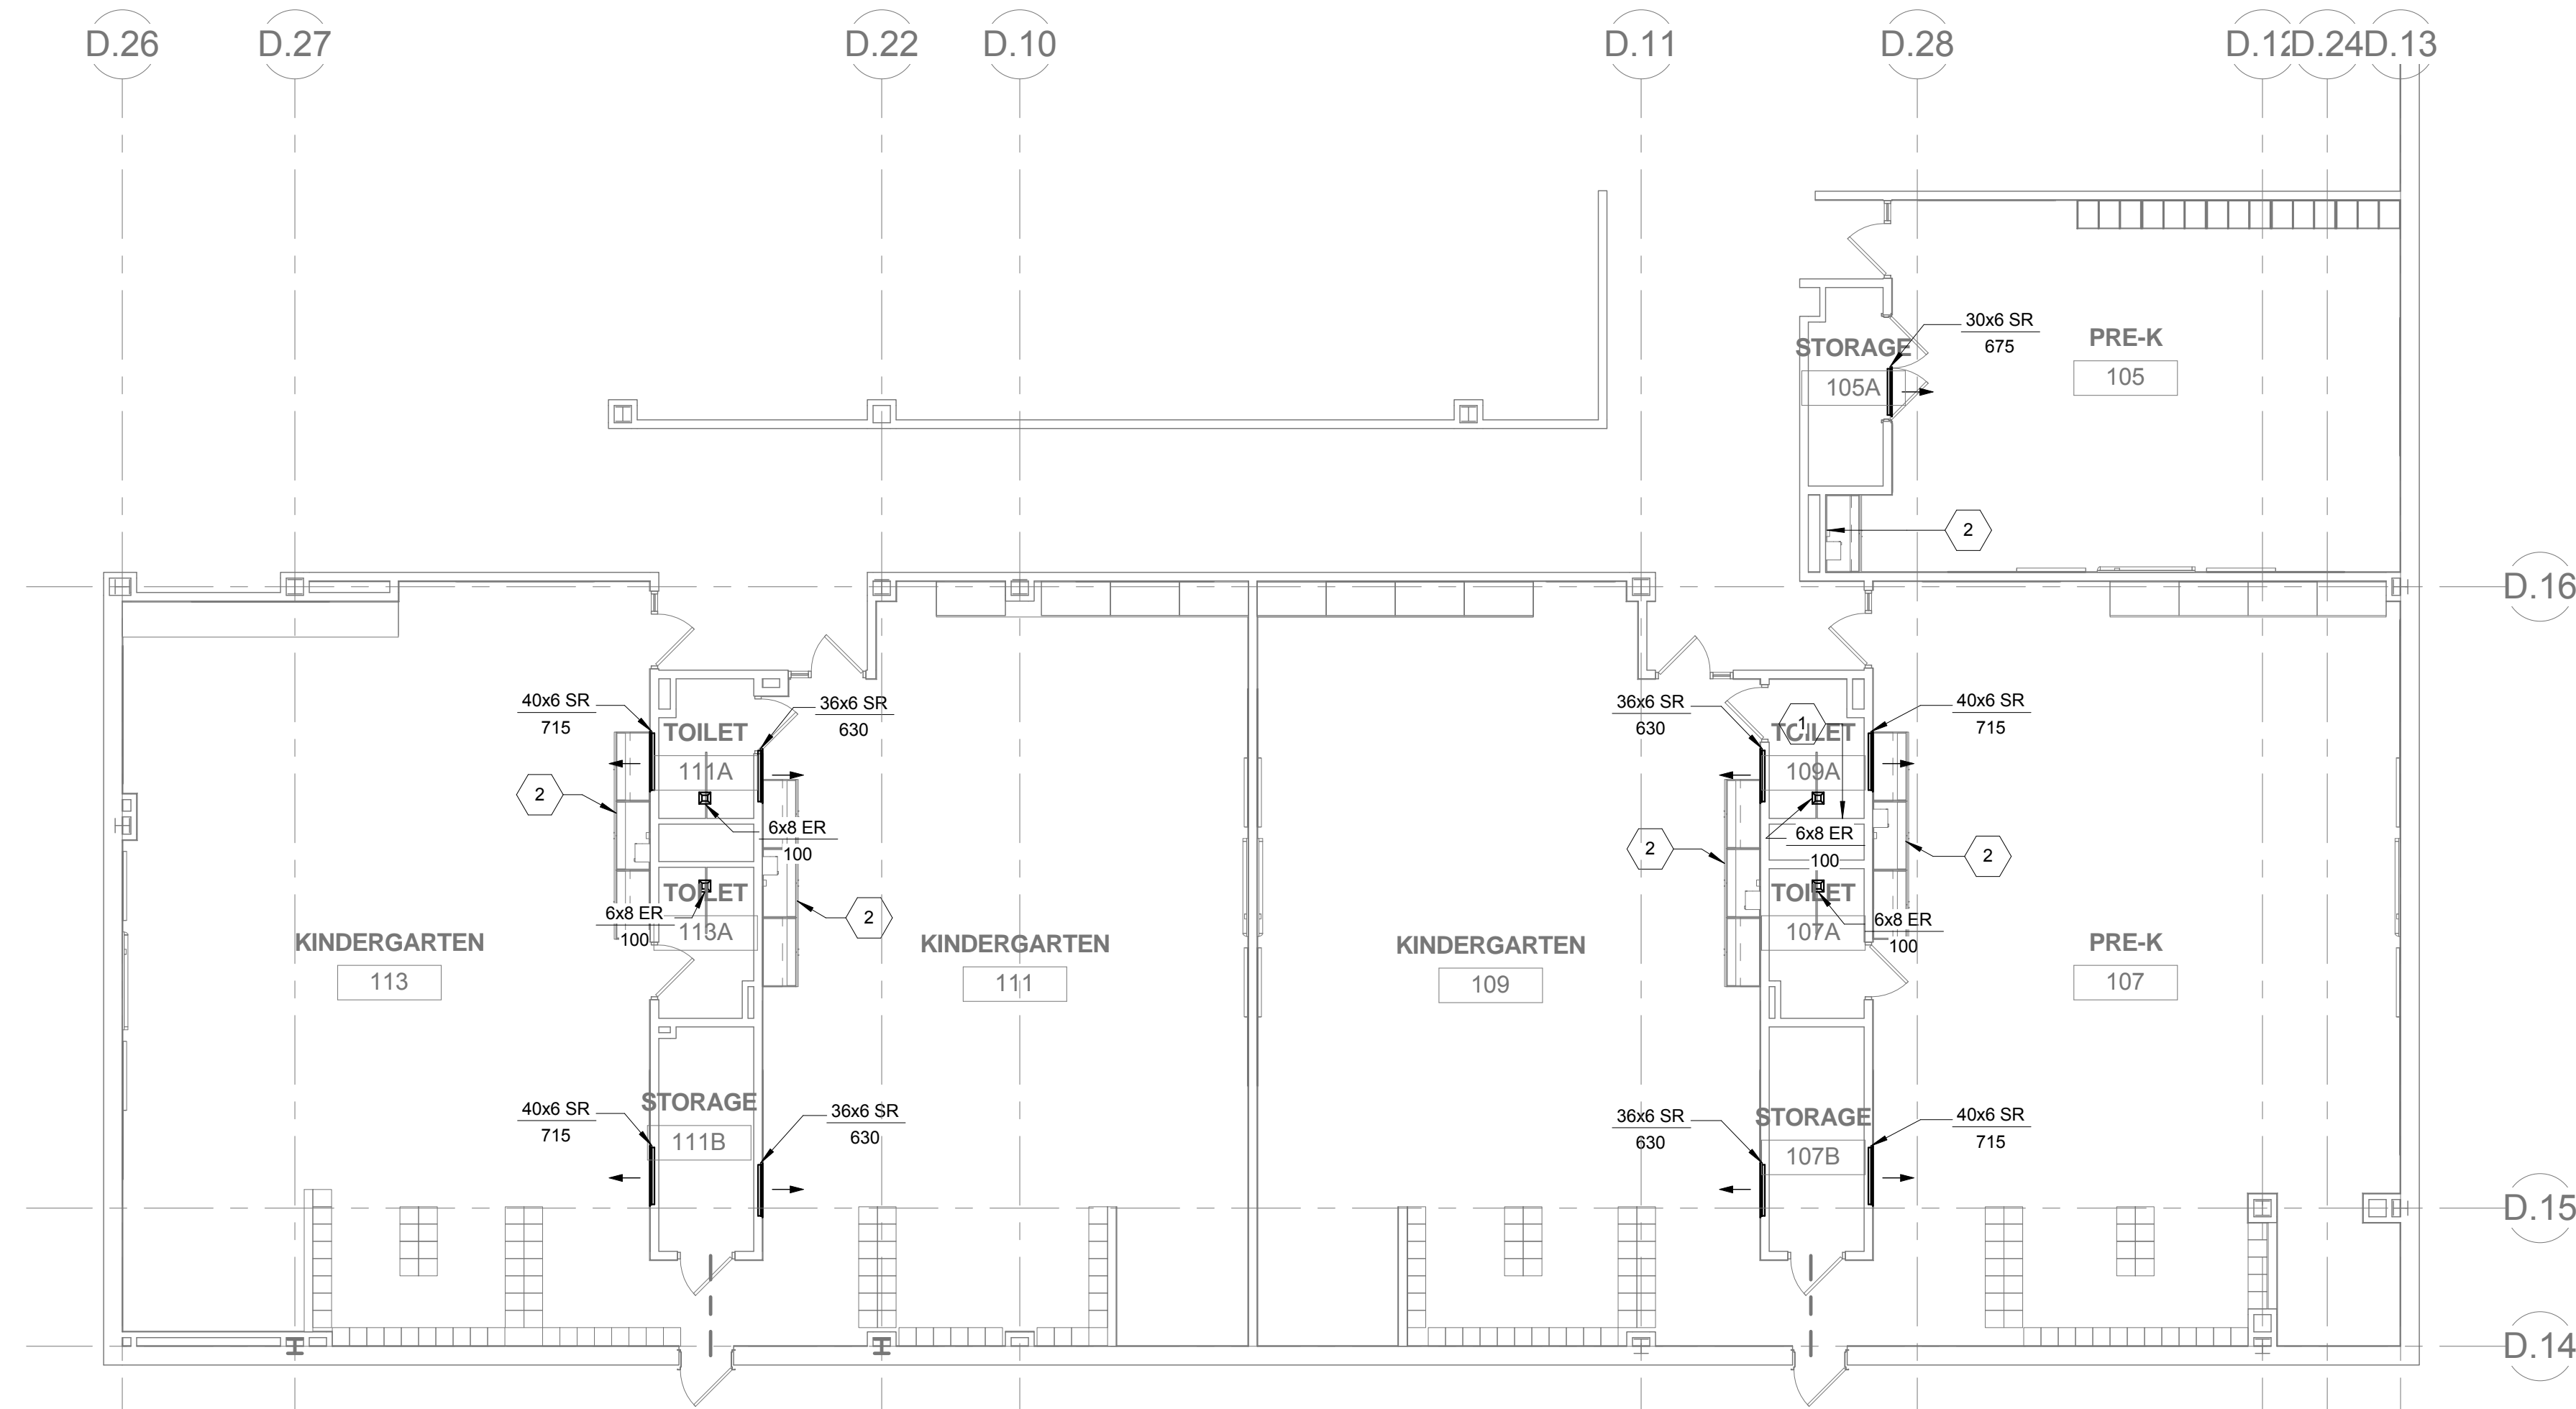

1 FIRST LEVEL - MECHANICAL AND PLUMBING FLOOR PLAN - NEW WORK
1/8" = 1'-0"

SEAL:



Vasilis K. Skordis DATE: 09/30/2019
STATE AND LICENSE NO. PA PEB18186

Architectural:
SCHRADERGROUP Architecture, LLC
Address: 161 Leverington Ave, Suite 105, Philadelphia PA 19127
Phone: 215.482.7440
Fax: 215.482.7441
Email: bgoode@sgarc.com
Attn: Brian Good

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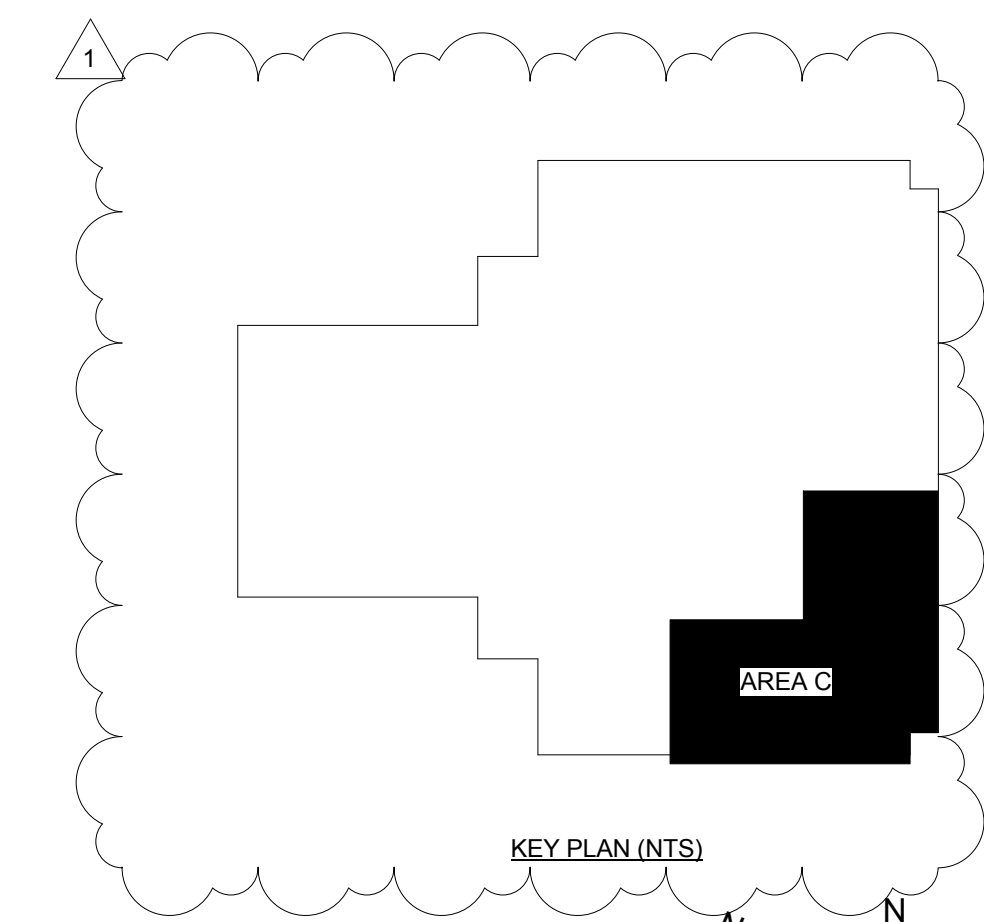
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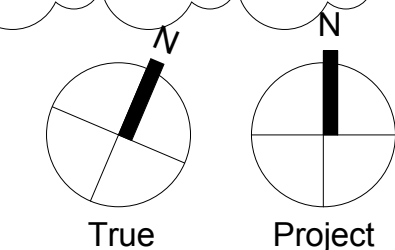
DRAWING TITLE
FIRST LEVEL - MECHANICAL AND PLUMBING FLOOR PLAN - NEW WORK

LOCATION NO.	FILE NO.
XX-XXX	
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OF	OF
2017/18 2017/18	

DRAWING NO.
M111



SCALE: 1/8"=1'-0"



1

2

3

4

5

6

7

8

A


B

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1 SECOND LEVEL - MECHANICAL AND PLUMBING FLOOR PLAN - NEW WORK
 1/8" = 1'-0"


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KEYED NOTES

- PROVIDE STAINLESS STEEL SINK ELKAY LRT171 WITH CHICAGO FAUCET F86-CP OR APPROVED EQUAL. PROVIDE VALVES AND ACCESSORIES FOR FULL FUNCTIONALITY. CONNECT NEW FIXTURE TO EXISTING PIPING. VERIFY SIZE AND LOCATION OF EXISTING PIPING IN FIELD.

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Vassilis K. Stamboulis STATE AND LICENSE NO. PA PE081586 DATE 09/30/2019
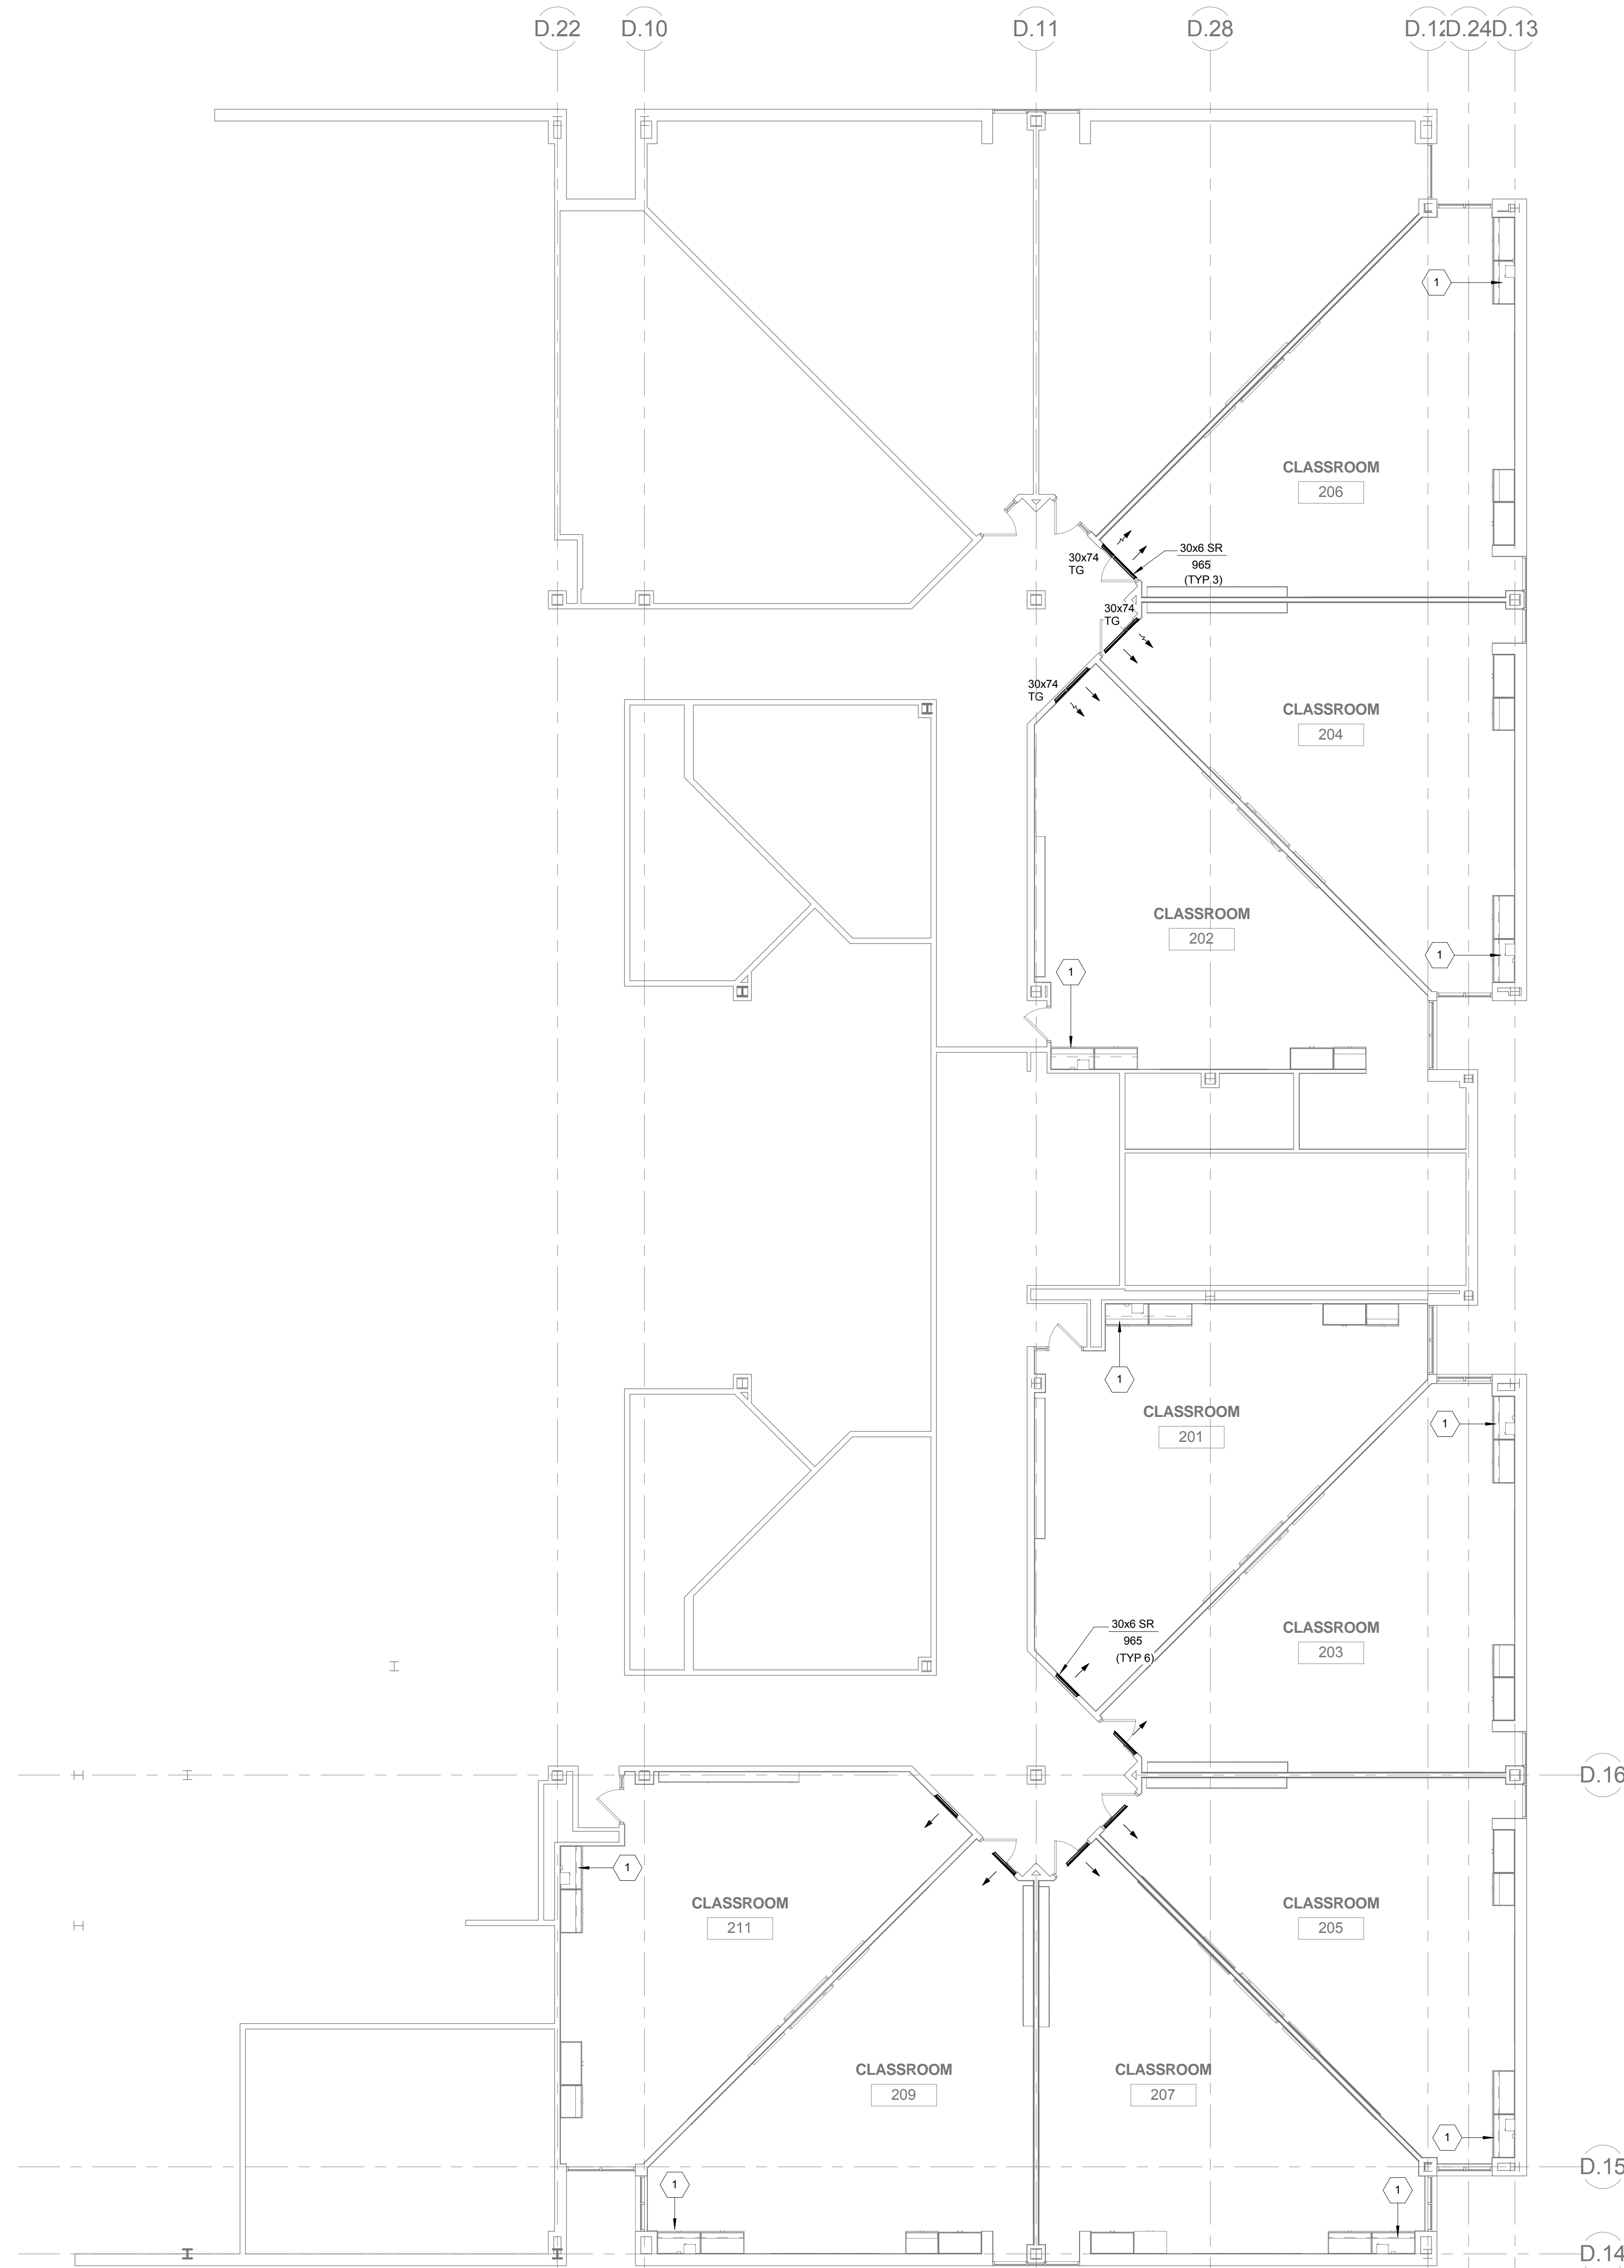
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SECOND LEVEL - MECHANICAL AND PLUMBING FLOOR PLAN - NEW WORK

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DRAWING NO.
M112

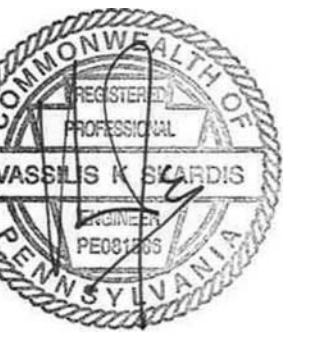