THE SCHOOL DISTRICT OF PHILADELPHIA Office of Capital Programs 440 North Broad Street, 3rd Floor – Suite 371 Philadelphia, PA 19130

TELEPHONE: (215) 400-4730

Addendum No. 01

Subject: John Taggart ES – Classroom Modernization

SDP Contract Nos. B-047C, B-050C, of 2017/18

Location: J Taggart ES

400 West Porter St.

Philadelphia, Pennsylvania 19148

This Addendum, dated 9th of May, 2018, shall modify and become part of the Contract Documents for the work of this project. Any items not mentioned herein, or affected by, shall be performed strictly in accordance with the original documents.

The following items, clarifications and/or revisions are to be included in the Contract Documents:

BIDDER'S QUESTIONS

1. **Question:** Due to the scope of work for all projects, the substantial completion date is unachievable. Along with lost time for moving of furniture and equipment before start of project. Can the date for substantial completion be extended?

Response: No.

2. **Question:** Visual Display Surfaces - in spec there is a note if new boards are not installed in time, to use temporary boards as necessary, how many temporary boards are we to provide per classroom?

Response: Temporary boards do not need to be provided.

3. **Question:** Do we need to provide temporary window shades, if new ones are not installed before start of school?

Response: No. Existing shades are to be removed and salvaged/protected and reinstalled until new shades can be installed.

4. **Question:** Wood Floor Refinishing- some projects call for 2 coats of stain, can we forgo the stain and just use 2 coats of sealer and 2 coats of finish for all projects. You are adding on time to an already accelerated schedule.

Response: Sand, seal, and finish the wood floors in accordance with the specifications. Omit staining of the floor.

5. **Question:** Have you checked on the choices of accent colors for the VCT tile? The colors may be a stock color, but do they have enough on hand, if not they may not be readily available for the substantial completion date.

<u>Response:</u> Armstrong has been made aware of this project and its approximate square footage needs. Contractor to provide updated information on each color's availability immediately after NTP.

6. Question: Can you please include spec for electrostatic painting.

Response: See Electrostatic Paint spec in Addendum #2.

7. Question: Please confirm panelboard 208 is being replaced in kind and feeder is being reutilized.

<u>Response:</u> Yes, Panelboard 208 is being replaced in kind with additional circuit breakers as indicated on contract drawings and existing main feeder is being utilized.

8. Question: Where is existing IT rack shown on the electrical floor plans?

<u>Response:</u> Existing MDF Room is located in closet in room 305 Library. Please see Addendum 1 contract drawing ED122 and E122.

CHANGES TO DRAWINGS

DRAWING CS.1 – COVER SHEET

1. **REVISE** drawing list to add P112 – Third Level – Plumbing Floor Plan – New Work

DRAWING D1.3 - THIRD FLOOR DEMOLITION PLAN

1. **REVISE** demolition note 10.

DRAWING A1.3 - OVERALL THIRD FLOOR PLAN

- REVISE existing wood folding wall trim to remain in Classrooms A303 and A304.
- 2. **ADD** bulkhead to box out existing to remain track.

DRAWING A1.6 - THIRD FLOOR REFLECTED CEILING PLAN

1. REVISE ACT location for existing to remain wood folding wall trim in Classrooms A303 and A304.

DRAWING A6.1 - DOOR SCHEDULE AND ROOM FINISH SCHEDULE

- ADD wall remark R55.
- ADD remark R55 to A107A.

DRAWING I4.1 - LARGE SCALE LAYOUTS - CLASSROOMS

- 1. **ADD** tack strip.
- 2. ADD tack board.
- 3. ADD note to mounting height schedule.
- 4. **REVISE** base cabinet height.

DRAWING 14.2 - LARGE SCALE LAYOUTS - CLASSROOMS

- 1. **ADD** note to mounting height schedule.
- 2. REVISE base cabinet height.

DRAWING 14.3 - LARGE SCALE LAYOUTS - CLASSROOMS

- ADD tack strip and markerboard.
- 2. **REVISE** whiteboards to tack boards.

DRAWING PD111 - FIRST & SECOND LEVEL - PLUMBING FLOOR PLAN - DEMOLITION

1. **ADD** demolition key note 2.

DRAWING P111 - FIRST & SECOND LEVEL - PLUMBING FLOOR PLAN - NEW WORK

1. ADD new work general note 3 and key note 2.

ADD DRAWING P112 - THIRD LEVEL - PLUMBING FLOOR PLAN - NEW WORK

1. **ADD** new work general note 3.

DRAWING ED111 - FIRST & SECOND LEVEL - LIGHTING FLOOR PLANS - DEMOLITION

1. ADD existing lights in toilet and storage.

DRAWING ED112 - THIRD LEVEL - LIGHTING FLOOR PLAN - DEMOLITION

- 1. **ADD** existing lights in toilet and storage.
- 2. ADD MDF room 305.

DRAWING ED122 - THIRD LEVEL - POWER FLOOR PLAN - DEMOLITION

1. **ADD** MDF room 305.

DRAWING E111 - FIRST & SECOND LEVEL - LIGHTING FLOOR PLANS - NEW WORK

1. **ADD** new lights in toilet and storage.

DRAWING E112 - THIRD LEVEL - LIGHTING FLOOR PLAN - NEW WORK

- 1. ADD new lights in toilet and storage.
- 2. ADD MDF room 305.

DRAWING E121 - FIRST & SECOND LEVEL - POWER FLOOR PLANS - NEW WORK

1. ADD receptacles for window AC unit and key notes.

DRAWING E122 - THIRD LEVEL - POWER FLOOR PLAN - NEW WORK

1. **ADD** MDF room 305.


DRAWING E401 - ELECTRICAL PANELBOARD SCHEDULES

- 1. ADD Panelboard schedules 201 existing and new.
- 2. ADD Power riser diagrams existing and new.

ATTACHMENTS

| DRAWING D1.3 | THIRD FLOOR DEMOLITION PLAN |
|---------------|--|
| DRAWING A1.3 | OVERALL THIRD FLOOR PLAN |
| DRAWING A1.6 | THIRD FLOOR REFLECTED CEILING PLAN |
| DRAWING A6.1 | THIRD FLOOR DEMOLITION PLAN |
| DRAWING I4.1 | LARGE SCALE LAYOUTS – CLASSROOMS |
| DRAWING 14.2 | LARGE SCALE LAYOUTS – CLASSROOMS |
| DRAWING I4.3 | LARGE SCALE LAYOUTS - CLASSROOMS |
| DRAWING PD111 | FIRST & SECOND LEVEL – PLUMBING FLOOR PLAN – DEMOLITION |
| DRAWING P111 | FIRST & SECOND LEVEL – PLUMBING FLOOR PLAN – NEW WORK |
| DRAWING P112 | THIRD LEVEL – PLUMBING FLOOR PLAN – NEW WORK |
| DRAWING ED111 | FIRST & SECOND LEVEL – LIGHTING FLOOR PLANS – DEMOLITION |
| DRAWING ED112 | THIRD LEVEL – LIGHTING FLOOR PLAN – DEMOLITION |
| DRAWING ED122 | THIRD LEVEL – POWER FLOOR PLAN – DEMOLITION |
| DRAWING E111 | FIRST & SECOND LEVEL – LIGHTING FLOOR PLANS – NEW WORK |
| DRAWING E112 | THIRD LEVEL – LIGHTING FLOOR PLAN – NEW WORK |
| DRAWING E121 | FIRST & SECOND LEVEL – POWER FLOOR PLANS – NEW WORK |
| DRAWING E122 | THIRD LEVEL – POWER FLOOR PLAN – NEW WORK |
| DRAWING E401 | ELECTRICAL PANELBOARD SCHEDULES |

End of Addendum 01

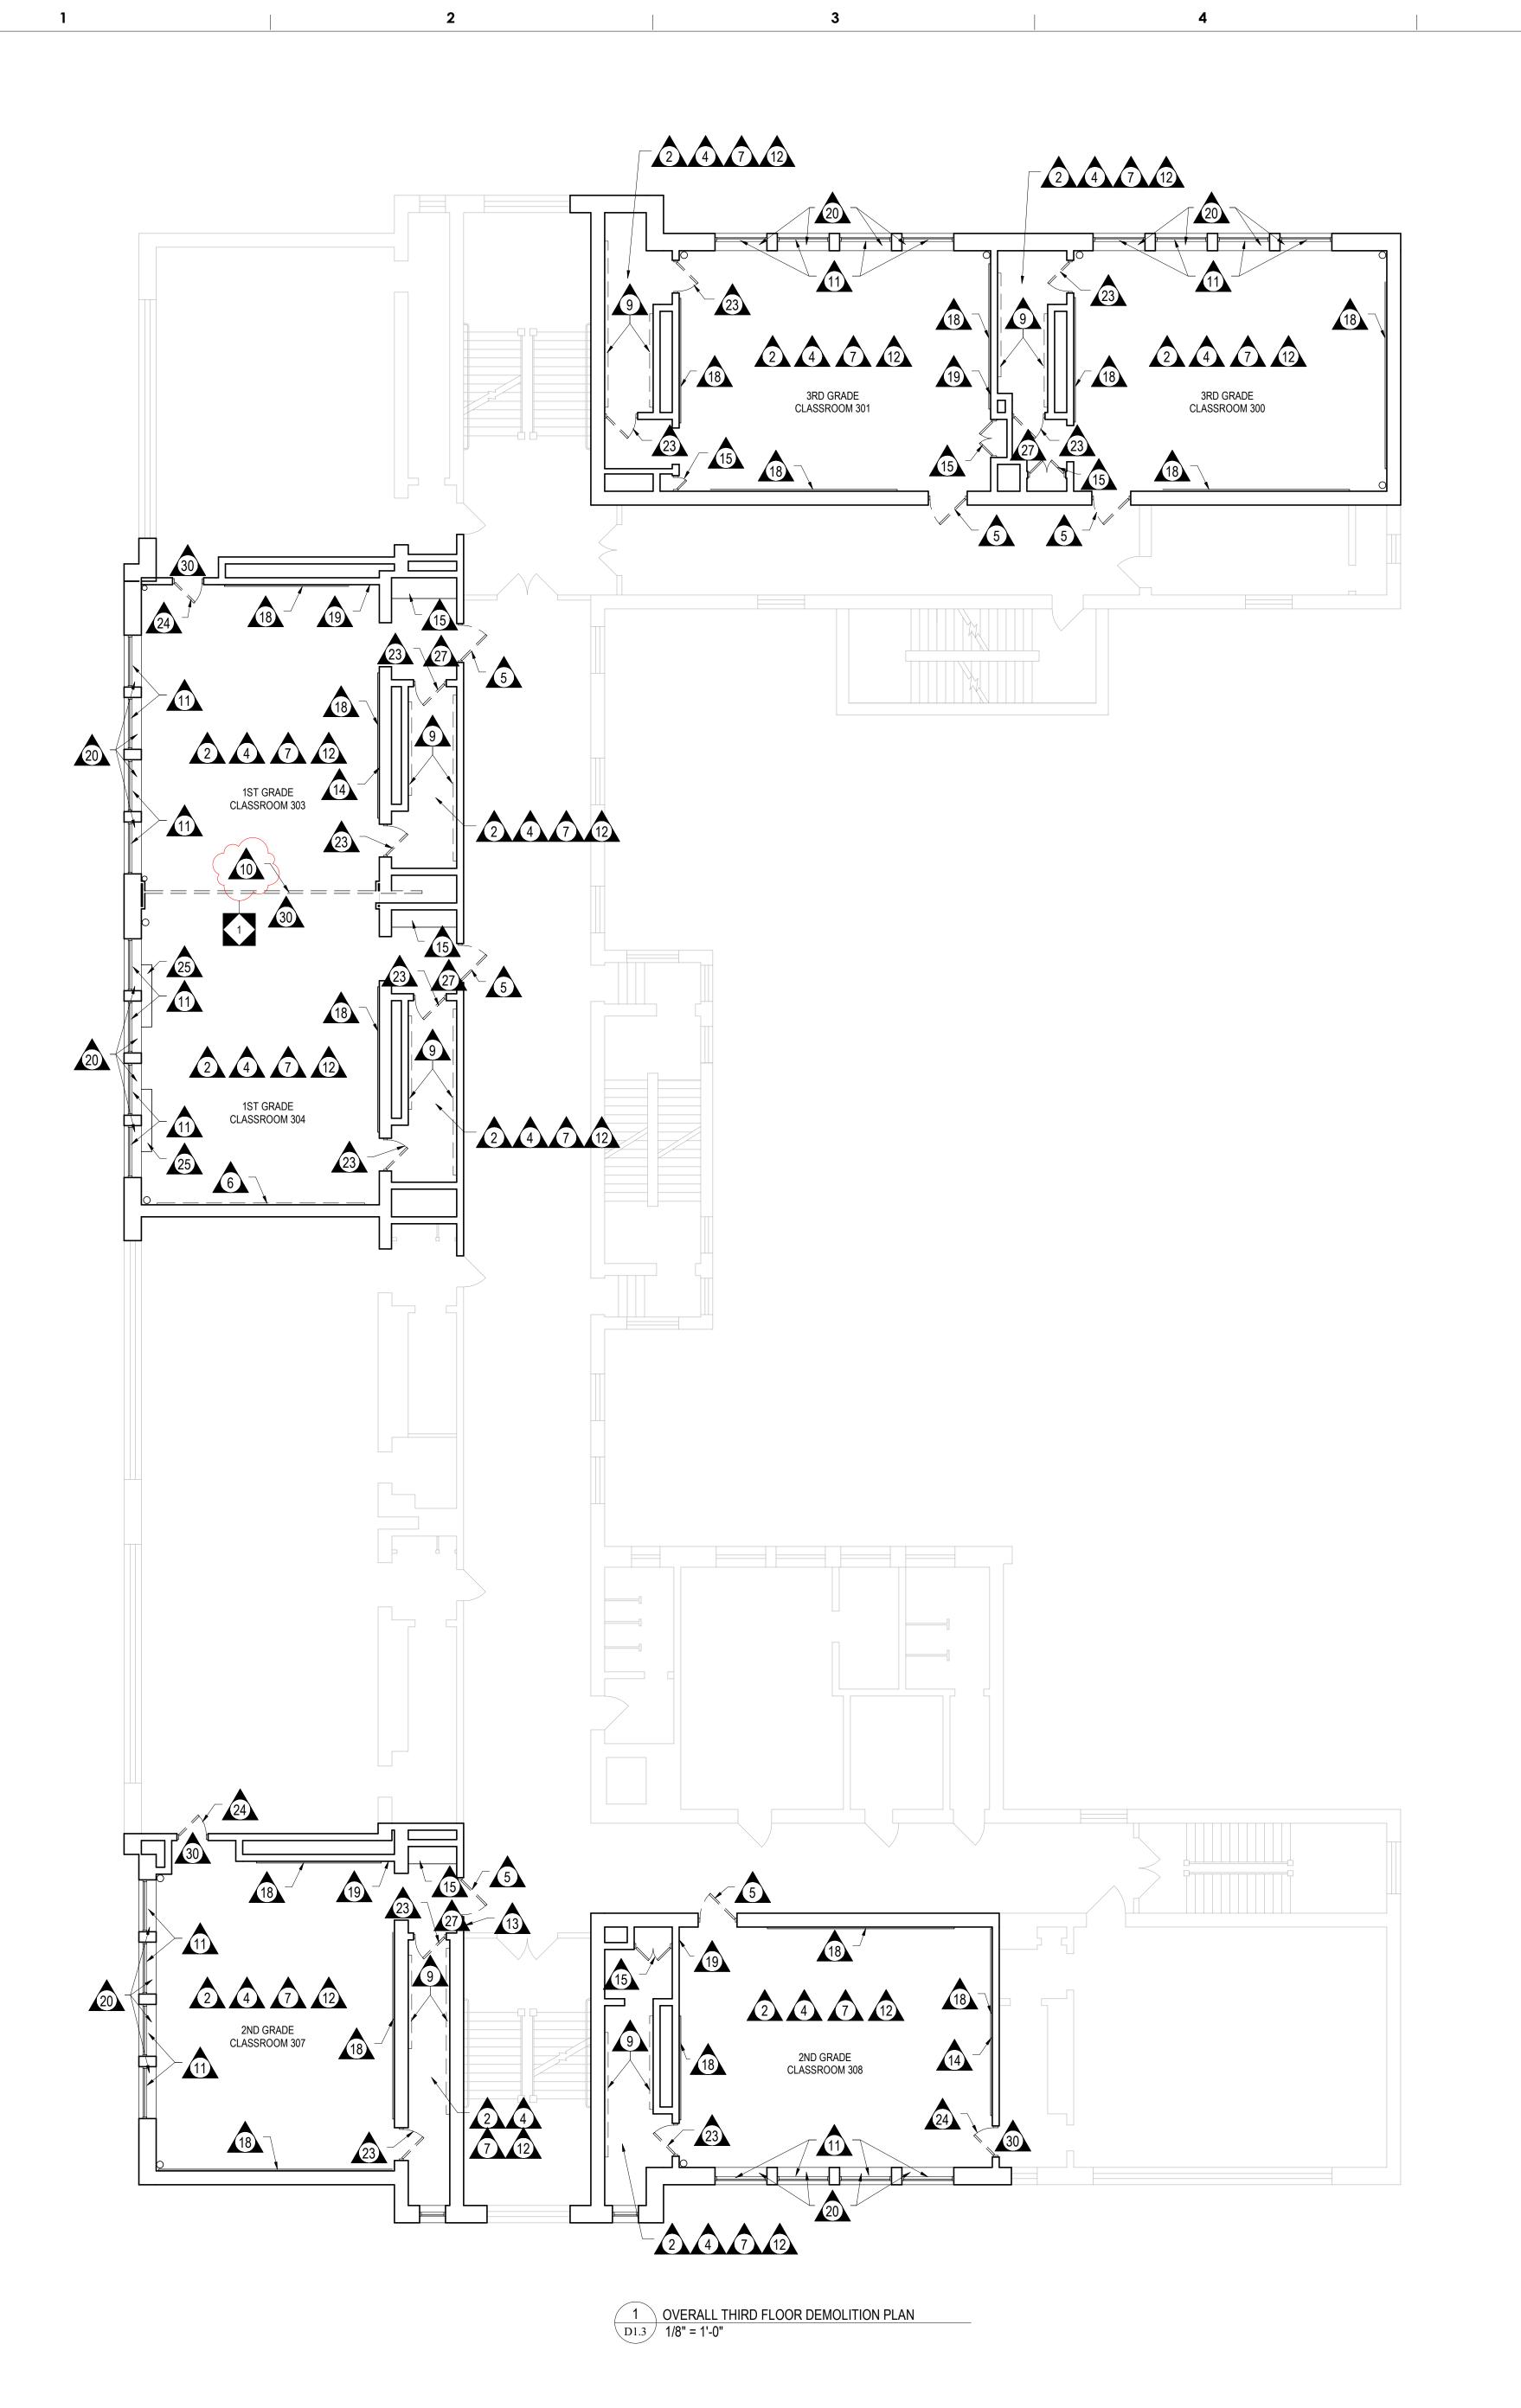

DEMOLITION / ALTERATION NOTES

TAG **DEMOLITION NOTE** REMOVE EXISTING VINYL COMPOSITION TILE, MASTIC TO REMAIN. FLASH PATCH AS REQUIRED, LEVEL AND PREPARE FLOOR TO RECEIVE NEW FINISH. REFER TO ABATEMENT SPECIFICATIONS. REMOVE EXISTING ACOUSTIC TILE CEILING AND SUSPENSION SYSTEM. PATCH AND REPAIR WALL SURFACES TO PREPARE FOR NEW SPECIFIED CEILING. REMOVE EXISTING CASEWORK IN ITS ENTIRETY INCLUDING BASE CABINETS, COUNTERTOPS, BACKSPLASHES, WALL CABINETS, TALL CABINETS, SHELVES, FILLERS & ASSOCIATED EXPOSED BLOCKING. PATCH AT LOCATIONS OF CASEWORK INSTALLATION. FINISH TEMPORARILY EXPOSED WALLS TO SAME LEVEL AS FINISHED WALL SURFACES PRIOR TO SUBSTANTIAL COMPLETION. REPAIR ALL DAMAGE TO WALL THROUGHOUT THE ROOM AS REQUIRED TO MATCH EXISTING ADJACENT SURFACES SUITABLE TO RECEIVE THE NEW SPECIFIED WALL FINISH. REMOVE EXISTING DOOR AND HARDWARE IN THEIR ENTIRETY, PREPARE EXISTING FRAME TO RECEIVE NEW DOOR. CAREFULLY REMOVE EXISTING CHALKBOARD AND/OR TACKBOARD, INCLUDING ALL RELATED HARDWARE AND MASTIC. PATCH AND REPAIR EXISTING WALL AS REQUIRED TO MATCH ADJACENT SURFACES SUITABLE TO RECEIVE NEW SPECIFIED WALL FINISH. REFER TO ABATEMENT SPECIFICATIONS.

AND REPAIR DISTURBED SURFACES TO MATCH ADJACENT EXISTING SURFACES. PREPARE SURFACES FOR NEW WORK. REFER TO FLOOR PLAN FOR NEW WORK. SALVAGE EXISTING SINK TO BE REINSTALLED. www.philasd.org EXISTING WOOD TRIM TO BE LIGHTLY SANDED AND REFINISHED WITH SPECIFIED APPROVED PRODUCT PER MANUFACTURER'S RECOMMENDATIONS AND PREPARED FOR NEW SPECIFIED FINISH. CAREFULLY REMOVE CUBBIES IN THEIR ENTIRETY INCLUDING BASE TRIM AND WALL TRIM AND ASSOCIATED EXPOSED BLOCKING. PATCH AND REPAIR DISTURBED SURFACES TO MATCH ADJACENT EXISTING SURFACES. PREPARE SURFACES FOR NEW WORK, REFER TO FLOOR PLAN FOR NEW WORK. REMOVE COAT HOOKS IN ITS ENTIRETY INCLUDING ANY ASSOCIATED EXPOSED BLOCKING AND/OR WALL MOUNTED BRACKING SYSTEM. PATCH AND REPAIR DISTURBED SURFACES TO MATCH ADJACENT EXISTING SURFACES. REFER TO ALTERATION PLAN FOR NEW WORK. REMOVE EXISTING FOLDING PARTITION IN THEIR ENTIRETY, INCLUDING HARDWARE. EXISTING WOOD JAMB AND HEAD TRIM TO REMAIN. PATCH AND REPAIR ALL REMAINING WALLS TO MATCH ADJACENT WALL

SURFACES. SEE FLOOR PLANS FOR NEW WORK. REMOVE EXISTING WINDOW SHADES IN ITS ENTIRETY INCLUDING ANY ASSOCIATED MOUNTING BRACKETS. PREPARE SURFACE FOR NEW SPECIFIED WINDOW SHADES.

SELECTIVELY REMOVE AND REPLACE 10% OF THE EXISTING WOOD FLOOR TO REPLACE BROKEN AND CRACKED WOOD FLOORING. LOCATION TO BE DETERMINED BY OWNER. EXISTING WOOD FLOORS TO BE STRIPPED, SANDED, SEALED AND REFINISHED WITH SPECIFIED APPROVED PRODUCT PER MANUFACTURER'S RECOMMENDATIONS. PATCH AND REPAIR HOLE IN WALL TO PREPARE FOR NEW SPECIFIED WALL FINISH. REMOVE WOOD TRIM BLOCKING ON WALL. PATCH AND REPAIR DISTURBED SURFACES TO MATCH ADJACENT EXISTING SURFACES. PREPARE SURFACES FOR NEW WORK. REFER TO FLOOR PLANS FOR NEW

EXISTING WOOD BUILT-IN CASEWORK TO BE LIGHTLY SANDED AND REFINISHED WITH SPECIFIED APPROVED PRODUCT PER MANUFACTURER'S RECOMMENDATIONS. REPAIR ALL MINOR DAMAGE AND REMOVE

ALL OBSOLETE HARDWARE. REFER TO PLUMB. DRAWINGS FOR DEMOLITION INFORMATION REGARDING WATER CLOSETS, DRINKING FOUNTAINS AND COUNTERTOP SINK ASSEMBLIES.

CLEAN EXISTING RADIATOR COVERS WITH SPECIFIED APPROVED PRODUCT PER MANUFACTURER'S RECOMMENATIONS. PREPARE EXISTING RADIATOR COVERS FOR NEW FINISH. EXISTING WOOD TRIM CHALKBOARDS AND/ OR TACK BOARDS TO BE STRIPPED, SANDED, SEALED AND REFINISHED WITH SPECIFIED APPROVED PRODUCT PER MANUFACTURER'S RECOMMENDATIONS. ALL HOOKS, ADHESIVES, BRACKETS, MAPS AND PROJECTOR SCREENS TO BE REMOVED. PREPARE CHALKBOARDS / TACK BOARDS TO RECEIVE NEW MARKERBOARD SKIN / FRAMELESS TACKBOARD OVER EXISTING

BOARDS PER MANUFACTURER'S WRITTEN INSTRUCTIONS. REMOVE TV AND TV BRACKET IN THEIR ENTIRETY. PATCH AND REPAIR THE EXISTING WALL TO MATCH ADJACENT SURFACES SUITABLE TO RECEIVE THE NEW SPECIFIED WALL FINISHES.

REPAIR ALL DAMAGE TO WINDOW SILLS. CLEAN WINDOW SILLS WITH SPECIFIED APPROVED PRODUCT PER MANUFACTURER'S RECOMMENDATIONS.

REMOVE EXISTING CERAMIC TILE AND MECHANICALLY SCRAPE ADHESIVE DOWN TO AN ACCEPTABLE RESIDUE IN ORDER TO RECEIVE NEW WORK. PREPARE SURFACE FORE NEW WORK. REPAIR ALL DAMAGE TO DOORS. REMOVE ALL OBSOLETE HARDWARE. STRIP, SAND AND SEAL DOORS WITH SPECIFIED APPROVED PRODUCT PER MANUFACTURER'S RECOMMENDATIONS. REMOVE EXISTING DOOR IN THEIR ENTIRETY, INCLUDING ALL HARDWARE, BRACKETS AND RELATED ITEMS. PREPARE EXISTING FRAME FOR NEW WORK.

REMOVE EXISTING DOOR AND FRAME IN THEIR ENTIRETY, INCLUDING ALL HARDWARE, BRACKETS, TRIM AND RELATED ITEMS. FRAME OPENING AS REQUIRED, AND PATCH AND REPAIR ALL REMAINING WALLS TO MATCH ADJACENT WALL SURFACES. PREPARE WALLS TO RECEIVE THE NEW SPECIFIED WALL FINISHES.

STRIP EXISTING PAINT FROM RADIATOR COVERS. CLEAN COVERS WITH SPECIFIED APPROVED PRODUCT PER MANUFACTURER'S RECOMMENATIONS. PREPARE EXISTING RADIATOR COVERS FOR NEW FINISH. EXISTING WOOD TRIM TO BE LIGHTLY SANDED AND PREPARED FOR NEW SPECIFIED PAINT FINISH.

NEW CUSTOM WOOD TRIM TO BE INSTALLED. REFER TO ACCENT WALL PLAN FOR LOCATIONS. WOOD SPECIES TO MATCH EXISTING PROFILE AND HEIGHT. FINISH WOOD TRIM WITH SPECIFIED APPROVED

REPAIR ALL DAMAGE TO GWB CEILING THROUGHOUT THE ROOM AS REQUIRED TO MATCH EXISTING ADJACENT SURFACES SUITABLE TO RECEIVE THE NEW SPECIFIED CEILING FINISH.

REMOVE EXISTING TOILET PARTITIONS IN THEIR ENTIRETY. PATCH AND REPAIR DISTURBED SURFACES TO MATCH ADJACENT EXISTING SURFACES. PREPARE SURFACE FOR NEW PARTITION. EXISTING WALL MOUNTED ACCESSORIES TO BE REMOVED AND REINSTALLED AT HEIGHTS INDICATED ON ACESSIBILITY STANDARDS ON SHEET A6.1


PRODUCT PER MANUFACTURER'S RECOMMENDATIONS. ARCHITECT TO APPROVE SAMPLE BEFORE PRODUCTION.

THE SCHOOL DISTRICT OF PHILADELPHIA

OFFICE OF CAPITAL PROGRAMS

440 NORTH BROAD STREET PHILADELPHIA, PA 19130 - 4015 (215) 400 - 4730 | (215) 400 - 4731 (fax)

SEAL:

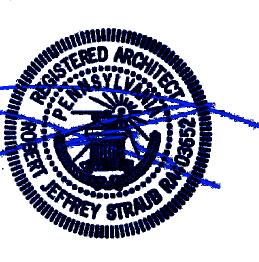

R. JEFFREY STRAUB, AIA

ARCHITECT

CRABTREE, ROHRBAUGH & ASSOCIATES -ARCHITECTS

401, EAST WINDING HILL ROAD MECHANICSBURG, PA 17055 717-458-0272 717-458-0047

DATE 04/20/2018

www.cra-architects.com Attn: R. Jeffrey Straub

MEP ENGINEER

GLOBAL ENGINEERING SOLUTIONS 6700A ROCKLEDGE DR. SUITE 301 BETHESDA, MD 20817 301-216-2871

301-216-9671 www.theges.com Attn: Anil Giri

| 10 | | |
|-----|----------|------------|
| 9 | | |
| 8 | | |
| 7 | | |
| 6 | | |
| 5 | | |
| 4 | | |
| 3 | | |
| 2 | | |
| 1 | 05/09/18 | ADDENDUM 1 |
| NO. | DATE | REVISION |

SCHOOL & LOCATION

JOHN H. TAGGART 400 W. PORTER STREET, PHILADELPHIA, PA 19148

PROJECT TITLE

CLASSROOM **MODERNIZATION**

DRAWING TITLE

THIRD FLOOR DEMOLITION PLAN

| DRAWN BY | CHI | ECKED BY |
|----------|-----|-----------|
| B-047C | OF | 2017 / 18 |
| B-050C | OF | 2017 / 18 |

DRAWING NO.

1 OVERALL THIRD FLOOR PLAN
A1.3 1/8" = 1'-0"

GENERAL NOTES:

1. COORDINATE LOCATION OF MEP EQUIPMENT, DEVICES, OUTLET BOXES, ETC. WITH OTHER EQUIPMENT AND FINISH SCHEDULE PRIOR TO INSTALLATION.

2. ALL WALL LAYOUT DIMENSIONS ARE FROM FACE OF STUD & FACE OF CMU UNLESS OTHERWISE NOTED.

THE SCHOOL DISTRICT OF PHILADELPHIA OFFICE OF CAPITAL PROGRAMS

440 NORTH BROAD STREET PHILADELPHIA, PA 19130 - 4015 (215) 400 - 4730 | (215) 400 - 4731 (fax)

SEAL:

www.philasd.org



R. JEFFREY STRAUB, AIA PENNSYLVANIA

ARCHITECT

Attn: R. Jeffrey Straub

CRABTREE, ROHRBAUGH & ASSOCIATES -ARCHITECTS 401, EAST WINDING HILL ROAD MECHANICSBURG, PA 17055 717-458-0272 717-458-0047 www.cra-architects.com

DATE 04/20/2018

MEP ENGINEER

GLOBAL ENGINEERING SOLUTIONS 6700A ROCKLEDGE DR. SUITE 301 BETHESDA, MD 20817 301-216-2871 301-216-9671 www.theges.com Attn: Anil Giri

1 05/09/18 ADDENDUM 1 NO. DATE REVISION

SCHOOL & LOCATION

JOHN H. TAGGART 400 W. PORTER STREET, PHILADELPHIA, PA 19148

PROJECT TITLE

CLASSROOM **MODERNIZATION**

DRAWING TITLE

OVERALL THIRD FLOOR PLAN

LOCATION NO. FILE NO. CHECKED BY DRAWN BY B-047C OF 2017 / 18 B-050C OF 2017 / 18 DRAWING NO.

1ST GRADE

CLASSROOM

FOLDING WALL

- 3 5/8" METAL STUDS

SOUND ATTENUATION

- 5/8" ABUSE RESISTANT GYPSUM WALL BOARD

1ST GRADE

CLASSROOM

BLANKET


(BOTH SIDES)

ALIGN FINISHES

NEW CUSTOM WOOD TRIM

2 WALL SECTION A1.3 1/2" = 1'-0"

5/8" GYPSUM WALL BOARD

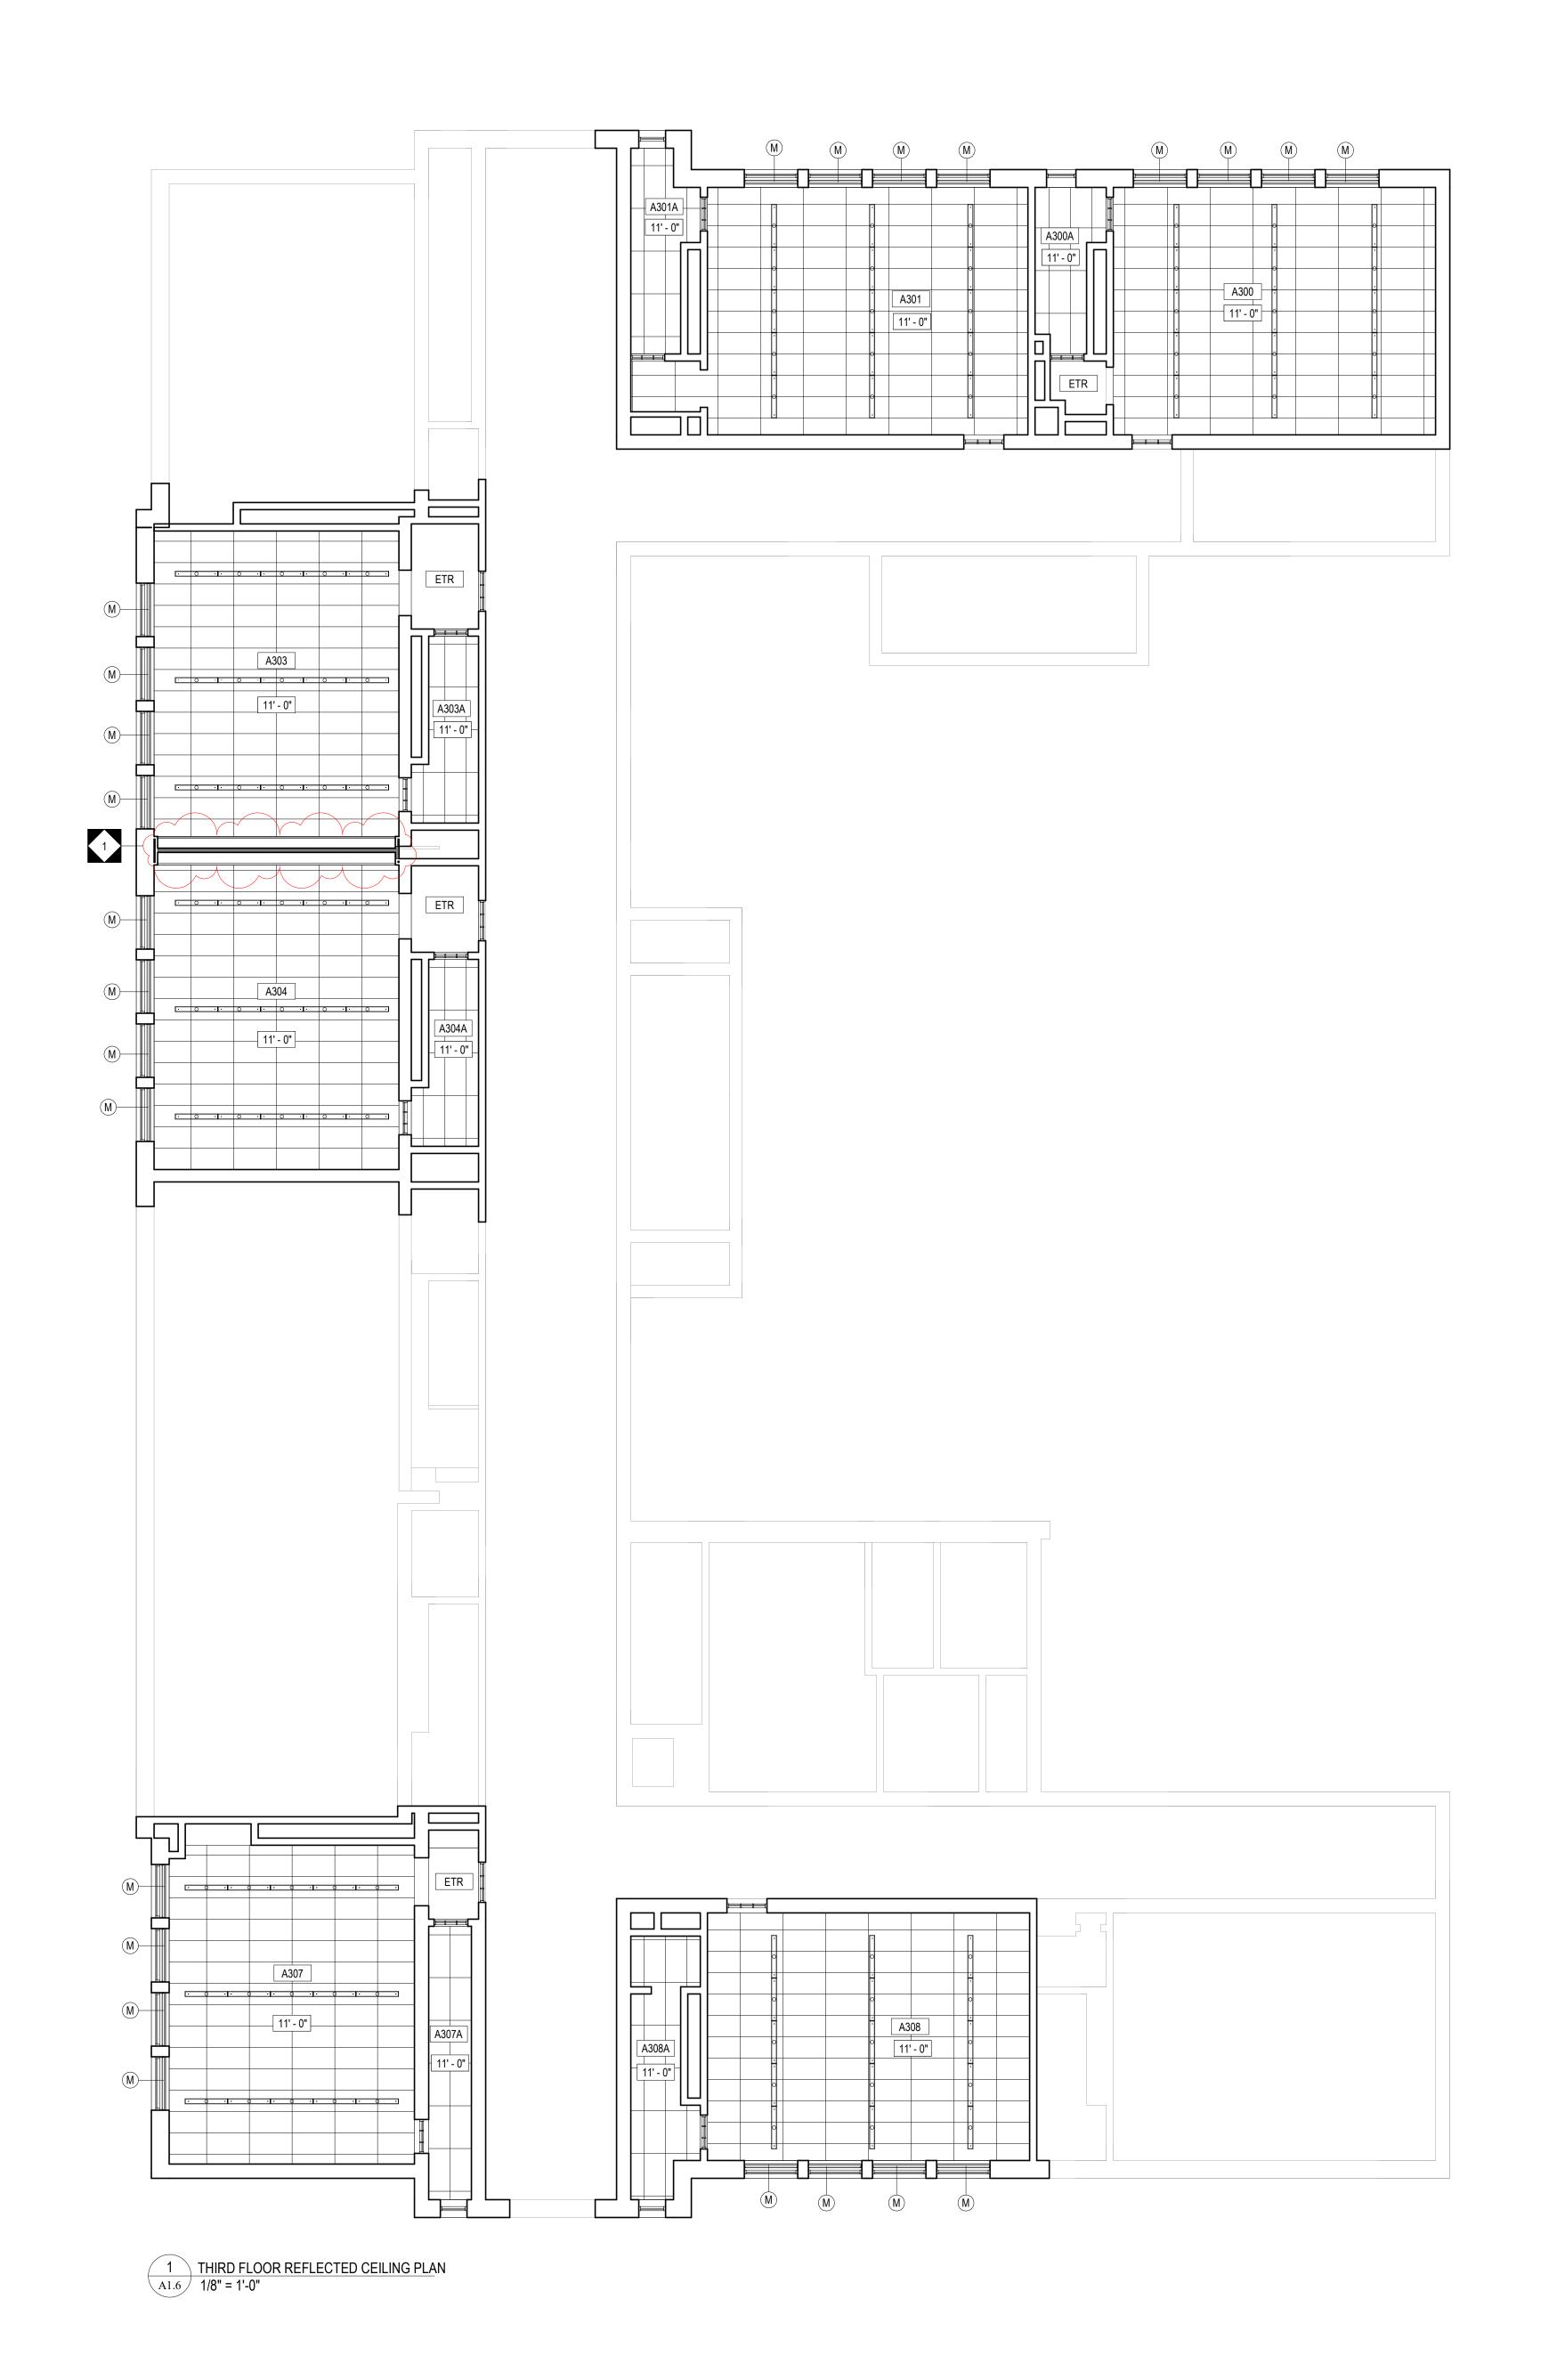

THE SCHOOL DISTRICT OF PHILADELPHIA

OFFICE OF CAPITAL PROGRAMS

440 NORTH BROAD STREET
PHILADELPHIA, PA 19130 - 4015
(215) 400 - 4730 | (215) 400 - 4731 (fax)
www.philasd.org

SEAL:



R. JEFFREY STRAUB, AIA PENNSYLVANIA

ARCHITECT

CRABTREE, ROHR

CRABTREE, ROHRBAUGH & ASSOCIATES -ARCHITECTS 401, EAST WINDING HILL ROAD MECHANICSBURG, PA 17055 717-458-0272 717-458-0047

DATE 04/20/2018

MEP ENGINEER

Attn: Anil Giri

www.cra-architects.com Attn: R. Jeffrey Straub

GLOBAL ENGINEERING SOLUTIONS 6700A ROCKLEDGE DR. SUITE 301 BETHESDA, MD 20817 301-216-2871 301-216-9671 www.theges.com

SCHOOL & LOCATION

JOHN H. TAGGART

400 W. PORTER STREET, PHILADELPHIA, PA 19148

PROJECT TITLE

CLASSROOM MODERNIZATION

DRAWING TITLE


THIRD FLOOR REFLECTED
CEILING PLAN

DRAWN BY

B-047C OF 2017 / 18
B-050C OF 2017 / 18

DRAWING NO.

A 1.6

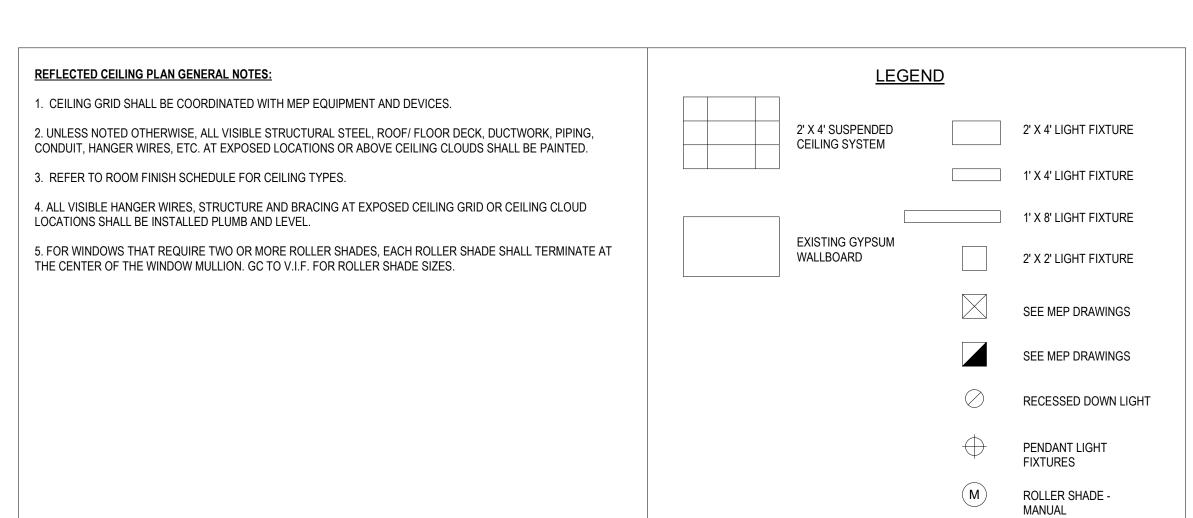



| | | | | ROOM FIN | ISH SCHEDI | JLE | | | |
|--------|---------------------------|----------|-------|----------|------------|--------|--------|----------|--------------------|
| | WALLS | | | | | | | | |
| | | COLOR | | | WALL | WAIN | ISCOT | CEILING | |
| NUMBER | NAME | SCHEME | FLOOR | BASE | FINISH | FINISH | HEIGHT | FINISH | REMARKS |
| A407 | DDE I/ OL A CODOCIA | - | VOT | \ /D | DNT | | | DOTD/AOT | DEO |
| A107 | PRE-K CLASSROOM | E | VCT | VB | PNT | | | PSTR/ACT | R53 |
| A107A | TOILET | G | CT | CT | EPX | | | PSTR | R55 1 |
| A107B | CLOSET | E | VCT | VB | PNT | | | PSTR | |
| A200 | KINDERGARTEN CLASSROOM | E | VCT | SLR | PNT | | | ACT/EPX | R29, R53 |
| A200A | TOILET | G | CT | CT | EPX | | | EPX | |
| A200B | CLOSET | E | VCT | SLR | PNT | | | ETR | |
| A201 | KINDERGARTEN CLASSROOM | Е | SLR | PNT | PNT | | | ACT | R14, R29, R53 |
| A201A | CLOSET | Е | SLR | SLR | PNT | | | ACT | R14, R29 |
| A202 | AS CLASSROOM | Е | SLR | SLR/WD | PNT | | | ACT | R14, R29, R53, R54 |
| A202A | CLOSET | Е | SLR | SLR | PNT | | | ACT | R14, R29 |
| A203 | EXISTING ROOM | | ETR | ETR/WD | ETR/PNT | | | ETR | R54 |
| A208 | PRE-K CLASSROOM | Е | VCT | SLR | PNT | | | ACT/EPX | R29, R53, R77 |
| A208A | CLOSET | Е | VCT | SLR | PNT | | | ACT | R29 |
| A208B | CLOSET | Е | VCT | SLR | PNT | | | ETR | |
| A209 | PRE-K CLASSROOM | Е | SLR | SLR | PNT | | | ACT/EPX | R14, R29, R53, R77 |
| A209A | TOILET | G | СТ | СТ | EPX | | | EPX | , , |
| A300 | 3RD GRADE CLASSROOM | F | SLR | SLR | PNT | | | ACT/EPX | R14, R29, R53 |
| A300A | CLOSET | F | SLR | SLR | PNT | | | ACT | R14, R29 |
| A301 | 3RD GRADE CLASSROOM | F | SLR | SLR | PNT | | | ACT | R14, R29, R53 |
| A301A | CLOSET | F | SLR | SLR | PNT | | | ACT | R14, R29 |
| A302 | EXISTING ROOM | | ETR | ETR/WD | ETR/PNT | | | ETR | R54 |
| A303 | 1ST GRADE CLASSROOM | F | SLR | SLR/WD | PNT | | | ACT/EPX | R14, R29, R53, R77 |
| A303A | CLOSET | F | SLR | SLR | PNT | | | ACT | R14, R29 |
| A304 | 1ST GRADE CLASSROOM | F | SLR | SLR/WD | PNT | | | ACT/EPX | R14, R29, R53, R77 |
| A304A | CLOSET | F | SLR | SLR | PNT | | | ACT | R14, R29 |
| A305 | EXISTING ROOM | | ETR | ETR/WD | ETR/PNT | | | ETR | R54 |
| A307 | 2ND GRADE CLASSROOM | F | SLR | SLR/WD | PNT | | | ACT/EPX | R14, R29, R53, R77 |
| A307A | CLOSET | F | SLR | SLR | PNT | | | ACT | R14, R29 |
| A308 | 2ND GRADE CLASSROOM | F | SLR | SLR/WD | PNT | | | ACT | R14, R29, R53 |
| A308A | CLOSET | F | SLR | SLR | PNT | | | ACT | R14, R29 |
| A309 | EXISTING ROOM | | ETR | ETR/WD | ETR/PNT | | | ETR | R54 |

| | | | | | | | | | DOOR SCHE | DULE | | | | | | |
|-------------------|----------------|--------------|-------------------|---------------|---------------|----------|--------------|---------------|-------------------|-------|----------|------|-----------------|-----------------|-------------------|------------------|
| | DOOR & | | | D | OOR | | | | | FRAME | | | | | | |
| | FRAME | | | | DIME | NSIONS | | | | | DETAILS | | | | | |
| OPENING NUMBER | U.L. RATING | DOOR TYPE | DOOR MATERIAL | WIE LEAF 1 | OTH LEAF 2 | HEIGHT | THICKNESS | FRAME TYPE | FRAME MATERIAL | HEAD | JAMB | SILL | GLAZING TYPE | HARDWARE SET | SPECIAL DETAIL | REMARKS |
| First Floor | 1011110 | 111 - | IVII (I LI (II (L | | | TILIOITI | 111101414200 | 1111 | IVII (I LI (II (L | | O/ TIVID | OILL | 111 = | OLI | DETAIL | TALIVII II II II |
| A107 | 20 MIN | N | WD | 3' - 0" | | 6' - 10" | 2" | ETR | ETR | ETR | ETR | ETR | RATED | 01 | 2, 5 | |
| 4107A | | F | ETR | 2' - 8" | | 7' - 0" | 2" | ETR | ETR | ETR | ETR | ETR | | 02 | 1,2 | |
| 4107B | | N | ETR | 2' - 8" | | 7' - 0" | 2" | ETR | ETR | ETR | ETR | ETR | | ETR | 1,2 | |
| Second Floor | | | | | | | | | | | | | | | | |
| 4200 | 20 MIN | N | WD | 3' - 5" | | 7' - 0" | 2" | ETR | ETR | ETR | ETR | ETR | RATED | 01 | 2, 5 | |
| A200A | | F | ETR | 2' - 10" | | 7' - 0" | 2" | ETR | ETR | ETR | ETR | ETR | | 02 | 1,2 | |
| A200B | | F | ETR | 2' - 10" | | 7' - 0" | 2" | ETR | ETR | ETR | ETR | ETR | | ETR | 1,2 | |
| A201 | 20 MIN | N | WD | 3' - 5" | | 7' - 0" | 2" | ETR | ETR | ETR | ETR | ETR | RATED | 01 | 3, 5 | |
| A201A | | F | ETR | 2' - 8" | | 7' - 0" | 2" | ETR | ETR | ETR | ETR | ETR | | 02 | 3,4 | |
| A202 | 20 MIN | N | WD | 2' - 10" | | 7' - 0" | 2" | ETR | ETR | ETR | ETR | ETR | RATED | 01 | 3, 5 | |
| A208 | 20 MIN | N | WD | 3' - 5" | | 7' - 0" | 2" | ETR | ETR | ETR | ETR | ETR | RATED | 01 | 2, 5 | |
| A208A | | N | ETR | 2' - 10" | | 7' - 0" | 2" | ETR | ETR | ETR | ETR | ETR | | ETR | 1,2 | |
| A208B | | N | ETR | 2' - 10" | | 7' - 0" | 2" | ETR | ETR | ETR | ETR | ETR | | ETR | 1,2 | |
| A208C | | F | ETR | 2' - 8" | | 7' - 0" | 2" | ETR | ETR | ETR | ETR | ETR | | 02 | 1,2 | |
| A209 | 20 MIN | N | WD | 3' - 5" | | 7' - 0" | 2" | ETR | ETR | ETR | ETR | ETR | RATED | 01 | 3, 5 | |
| A209A | | F | ETR | 2' - 8" | | 7' - 0" | 2" | ETR | ETR | ETR | ETR | ETR | | 02 | 3,4 | |
| Third Floor | | | | | | | | | | | | | | | | |
| 4300 | 20 MIN | N | WD | 3' - 5" | | 7' - 0" | 2" | ETR | ETR | ETR | ETR | ETR | RATED | 01 | 2, 5 | |
| A301 | 20 MIN | N | WD | 3' - 5" | | 7' - 0" | 2" | ETR | ETR | ETR | ETR | ETR | RATED | 01 | 2, 5 | |
| A303 | 20 MIN | N | WD | 3' - 5" | | 7' - 0" | 2" | ETR | ETR | ETR | ETR | ETR | RATED | 01 | 2, 5 | |
| \ 304 | 20 MIN | N | WD | 3' - 5" | | 7' - 0" | 2" | ETR | ETR | ETR | ETR | ETR | RATED | 01 | 2, 5 | |
| \307 | 20 MIN | N | WD | 3' - 5" | | 7' - 0" | 2" | ETR | ETR | ETR | ETR | ETR | RATED | 01 | 2, 5 | |
| A308 | 20 MIN | N | WD | 3' - 5" | | 7' - 0" | 2" | ETR | ETR | ETR | ETR | ETR | RATED | 01 | 2, 5 | |

DOOR TYPES

* - RECOMMENDED MOUNTING HEIGHT FROM FINISHED FLOOR TO CENTER LINE OF FIRE EXIT DEVICE ** - COORDINATE WITH DOOR MANUFACTURE REQUIREMENTS

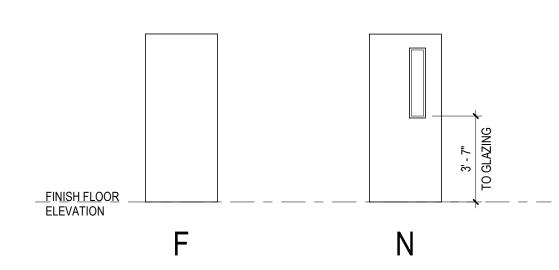

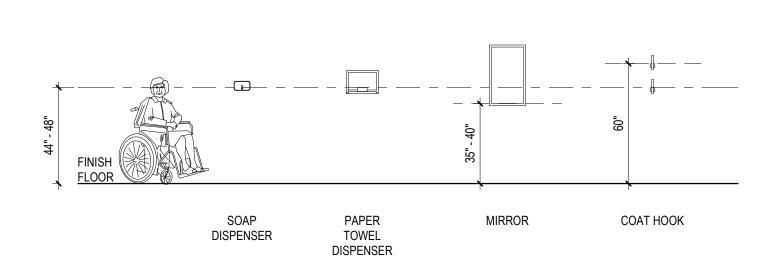

ACCESSIBILITY STANDARDS

- COLOR SCHEME E **CLASSROOMS-BLUE**
- 1. WALL PAINT: SHERWIN WILLIAMS, NO. SW9135 WHIRLPOOL
- 2. ACCENT PAINT 'A' TEACHING WALL: SHERWIN WILLIAMS, NO. SW6774 FRESHWATER 3. VINYL COMPOSITION TILE, FIELD: ARMSTRONG, NO. 52514 JUBILEE WHITE
- 4. VINYL COMPOSITION TILE, ACCENT '1': ARMSTRONG, NO. 51879 ETRUSCAN RED 5. VINYL COMPOSITION TILE, ACCENT '2': ARMSTRONG, NO. 51915 CHARCOAL
- 6. VINYL BASE: JOHNSONITE, NO. 262 DRIZZLE
- 7. VERTICAL CASEWORK LAMINATE: WILSONART, NO. D25 ATLANTIS
- SEE FLOOR FINISH PLAN FOR FLOOR PATTERN, VINYL BASE, ACCENT WALL COLOR LOCATIONS.

COLOR SCHEME F

CLASSROOMS-TAN & PINK

- 1. WALL PAINT: SHERWIN WILLIAMS, NO. SW1015 SKYLINE STEEL 2. ACCENT PAINT 'A' TEACHING WALL: SHERWIN WILLIAMS, NO. SW6627 EMBERGLOW
- 3. VINYL COMPOSITION TILE, FIELD: ARMSTRONG, NO. 51803 PEARL WHITE
- 4. VINYL COMPOSITION TILE, ACCENT '1': ARMSTRONG, NO. 51867 CANTALOUPE
- 5. VINYL COMPOSITION TILE, ACCENT '2': ARMSTRONG, NO. 51813 PUMPKIN ORANGE 6. VINYL BASE: JOHNSONITE, NO. 469 MYSTIFY
- 7. VERTICAL CASEWORK LAMINATE: WILSONART, NO. D96 SHADOW SEE FLOOR FINISH PLAN FOR FLOOR PATTERN, VINYL BASE, ACCENT WALL COLOR LOCATIONS.

COLOR SCHEME G

BATHROOMS

1. WALL PAINT: SHERWIN WILLIAMS, NO. SW7029 AGREEABE GRAY 2. PORCELAIN FLOOR TILE: DALTILE, EVER PORCELIAN, COLOR: EV03 ARCTIC UNPOLISHED SEE FLOOR FINISH PLAN FOR FLOOR PATTERN, VINYL BASE, ACCENT WALL COLOR LOCATIONS.

- THE FOLLOWING MATERIALS ARE TO BE APPLIED AT ALL LOCATIONS WHERE SPECIFIED
- <u>UNLESS OTHERWISE NOTED:</u> 1. TACK BOARDS: CLARIDGE FABRICORK, KL498 WINTHROPE
- 2. ROLLER WINDOW SHADES: MERMET, GREENSCREEN REVIVE, 5% OPEN, COLOR: 0.22 STONE 3. SOLID SURFACE COUNTERTOP & SIDE/BACK SPLASH: CORIAN, COLOR: DEEP CAVIAR
- 4. CEILING PAINT: SHERWIN WILLIAMS, NO. SW7006 EXTRA WHITE
- 5. MISC PAINT 'DOOR FRAMES, METAL DOORS, HVAC EQUIP': SHERWIN WILLIAMS, NO. SW7068 GRIZZLE GRAY

NOTES: A. IF ROOM IS NOT INDICATED TO RECEIVE A FLOOR PATTERN, FIELD COLOR VCT SHALL BE USED. B. VCT ORIENTATION SHALL BE MATCHED TO EXISTING ADJACENT ROOM.

C. ARCHITECT REQUIRES AN ON-SITE MOCK-UP FOR EACH PAINT COLOR. PROVIDE A MINIMUM 8'x10' AREA, A DOOR FRAME. CONTRACTOR MUST RECEIVE ARCHITECT'S APPROVAL BEFORE ORDERING.

E. COORDINATE ROOM FINISH SCHEDULE AND COLOR SCHEME SCHEDULE WITH DEMO/ALTERATION NOTES.

D. VERTICAL AND HORIZONTAL PLANES OF SOFFIT AND BULKHEAD SHALL BE PAINTED TO MATCH THE ADJACENT WALL COLOR, UNLESS OTHERWISE NOTED.

THE SCHOOL DISTRICT OF PHILADELPHIA **OFFICE OF CAPITAL PROGRAMS**

440 NORTH BROAD STREET PHILADELPHIA, PA 19130 - 4015 (215) 400 - 4730 | (215) 400 - 4731 (fax) www.philasd.org



R. JEFFREY STRAUB, AIA PENNSYLVANIA

ARCHITECT

CRABTREE, ROHRBAUGH & ASSOCIATES -ARCHITECTS 401, EAST WINDING HILL ROAD MECHANICSBURG, PA 17055 717-458-0272

DATE 04/20/2018

717-458-0047 www.cra-architects.com Attn: R. Jeffrey Straub

MEP ENGINEER

Attn: Anil Giri

GLOBAL ENGINEERING SOLUTIONS 6700A ROCKLEDGE DR. SUITE 301 BETHESDA, MD 20817 301-216-2871 301-216-9671 www.theges.com

ROOM FINISH SCHEDULE LEGEND FLOOR FINISH CERAMIC TILE SLR CLEAR SEALER VCT VINYL COMPOSITION TILE FLOOR REMARKS R1-R13. NOT USED R14: EXISTING WOOD FLOORS TO BE STRIPPED, SANDED, SEALED AND REFINISHED WITH SPECIFIED PRODUCT. R15-R25: NOT USED BASE FINISH CERAMIC TILE VINYL BASE PNT PAINTED CLEAR SEALER WOOD BASE BASE REMARKS R26-28: NOT USED R29: EXISTING WOOD TRIM TO BE STRIPPED, SANDED, SEALED AND REFINISHED WITH SPECIFIED PRODUCT. R30-R50: NOT USED WALL FINISH PNT PAINT EPX EPOXY PAINT WALL REMARKS R51-52: NOT USED R53: PROVIDE ACCENT WALL. PAINT WALL IN ITS ENTIRETY ONLY AT NEW R54: WORK. GC TO MATCH EXISTING. PROVIDE TEXTURED FINISH TO EXISTING WALLS. FINISH TO BE CGC TEXTURA "ORANGE PEEL" BY U.S. GYPSUM INC. OR EQUAL. R56-R75: NOT USED

DOOR REMARKS KEY

PRODUCT PER MANUFACTURER'S RECOMMENDATIONS.

PRIMER AND PAINT FINISHES ARE APPLIED.

FINISHES ARE APPLIED.

1. DOOR TO BE STRIPPED, SANDED AND SEALED WITH SPECIFIED APPROVED

3. AT EXISTING METAL DOOR FRAMES TO REMAIN, REMOVE ALL DIRT, LOOSE PAINT, RUST, AND ANY OTHER FOREIGN ITEMS. SAND ENTIRE FRAME AND TRANSOM, PRIME AND PAINT. EXISTING CHIPPED, DETERIORATED AND UNEVEN PAINT COATINGS SHALL BE COMPLETELY REMOVED BEFORE NEW


4. AT EXISTING METAL DOORS TO REMAIN, REMOVE ALL DIRT, LOOSE PAINT, RUST, AND ANY OTHER FOREIGN ITEMS. SAND ENTIRE DOOR, PRIME AND PAINT. EXISTING CHIPPED, DETERIORATED AND UNEVEN PAINT COATINGS SHALL BE COMPLETELY REMOVED BEFORE NEW PRIMER AND PAINT

5. GC TO V.I.F. EXISTING DOOR SIZE FOR NEW DOOR REPLACEMENT.

2. WOOD TRIM TO BE STRIPPED, SANDED AND SEALED WITH SPECIFIED APPROVED PRODUCT PER MANUFACTURER'S RECOMMENDATIONS.

> CEILING FINISH ACT ACOUSTICAL CEILING TILE EPX EPOXY PAINT PSTR PAINTED STRUCTURE CEILING REMARKS R76: NOT USED R77: SEE REFLECTED CEILING PLANS FOR VARYING CEILING MATERIALS AND HEIGHTS.

1 05/09/18 ADDENDUM 1 NO. DATE REVISION SCHOOL & LOCATION JOHN H. TAGGART 400 W. PORTER STREET, PHILADELPHIA, PA 19148 PROJECT TITLE CLASSROOM **MODERNIZATION** DRAWING TITLE DOOR SCHEDULE AND **ROOM FINISH SCHEDULE** LOCATION NO. FILE NO. R78-R100: NOT USED DRAWN BY CHECKED BY GENERAL NOTES 1. REFER TO SPECIFICATIONS FOR DETAILED B-047C OF 2017 / 18 DESCRIPTION OF FINISH SYSTEM/TYPES. B-050C OF 2017 / 18 2. GYPSUM WALLBOARD BULKHEADS AND SOFFITS SHALL BE PAINTED. 3. ALL FERROUS METAL SHALL BE PAINTED INCLUDING LINTELS, GRILLES AND LOUVERS. 4. SEE I7 DRAWINGS FOR BASE TRANSITIONS, MATERIAL DRAWING NO. TRANSITIONS & FLOOR FINISH PLANS. 5. ETR = EXISTING TO REMAIN 6. EXIST = EXISTING 7. PAINT ALL EXISTING EXPOSED PIPES TO MATCH NEW SHEET OF WALL FINISH COLOR.

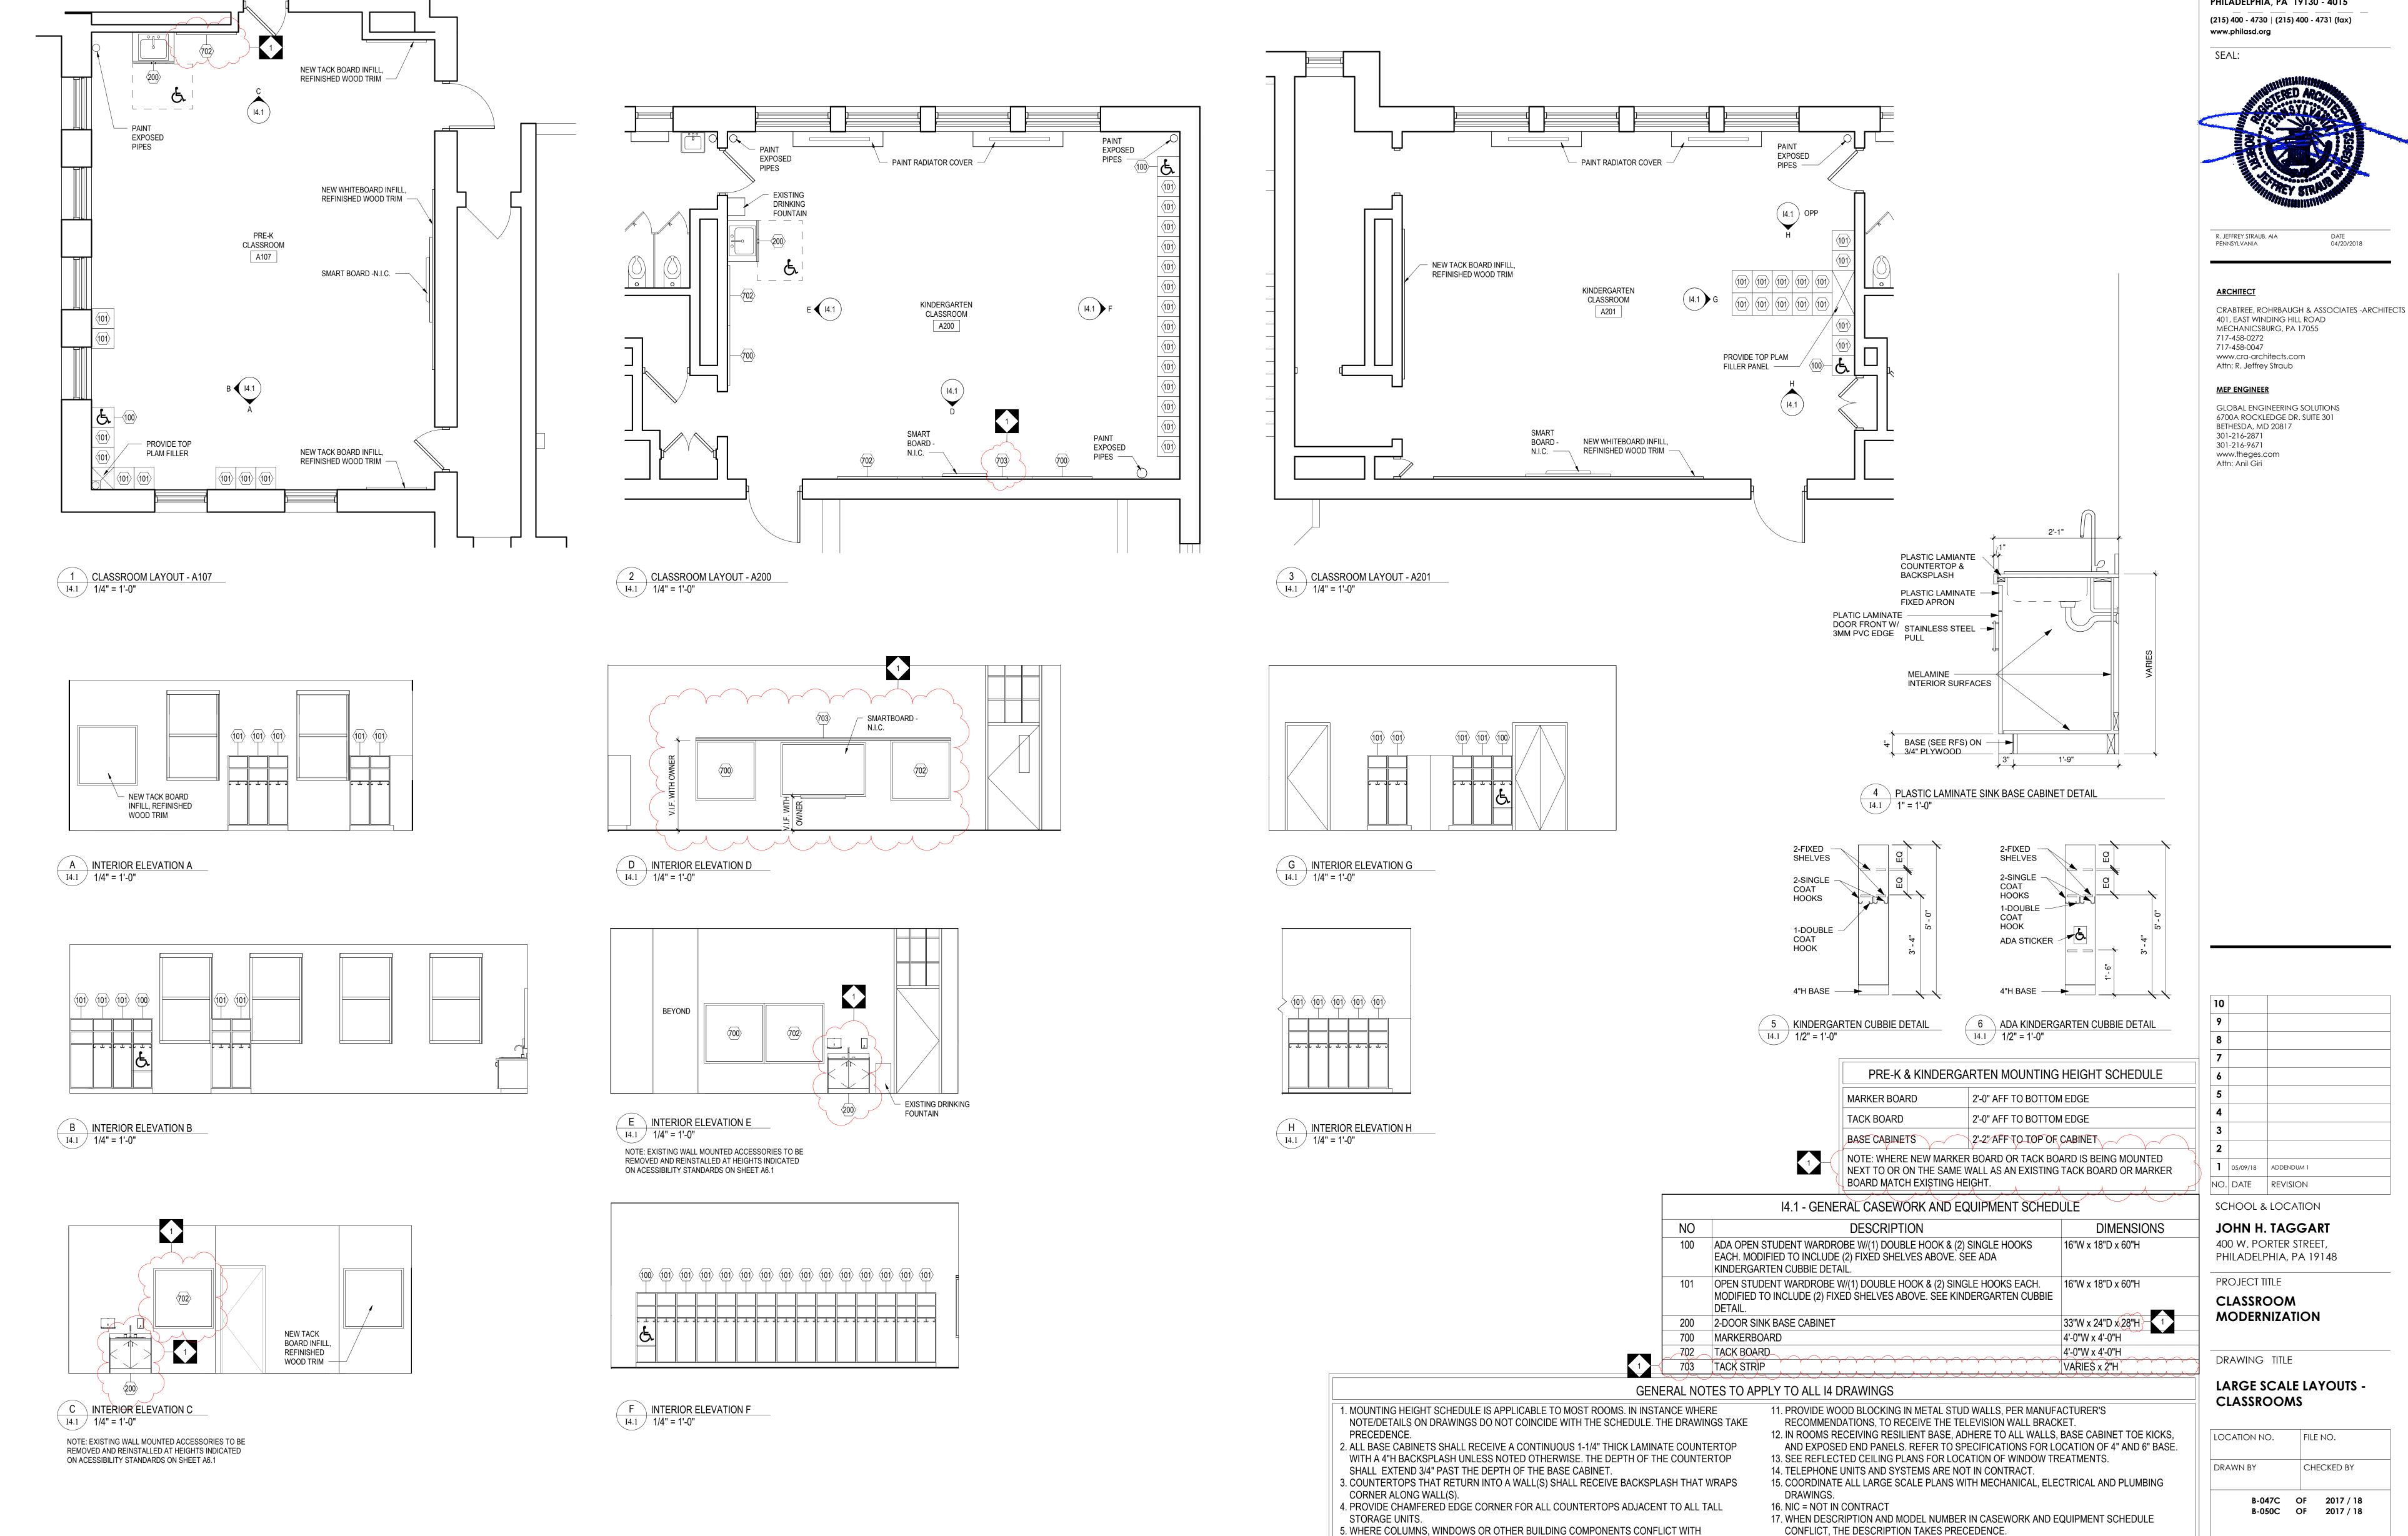

CASEWORK DIMENSIONAL REQUIREMENTS. FIELD VERIFY DIMENSIONS AND PROVIDE

7. LAMINATE COLOR FOR INTERIOR OF OPEN CABINETS SHALL MATCH EXTERIOR LAMINATE

8. STAINLESS STEEL SINKS, FAUCETS, AND BUBBLERS SHALL BE PROVIDED AND INSTALLED BY

6. ALL EXPOSED ENDS OF CASEWORK SHALL RECEIVE FINISHES END PANELS.

CUSTOM UNIT TO ALLOW PROPER FITTING.


PLUMBING CONTRACTOR.

18. OPP = OPPOSITE HAND.

THE SCHOOL DISTRICT OF PHILADELPHIA


OFFICE OF CAPITAL PROGRAMS


440 NORTH BROAD STREET PHILADELPHIA, PA 19130 - 4015

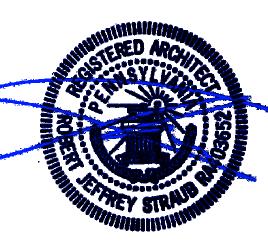


B-047C OF 2017 / 18 B-050C OF 2017 / 18

DRAWING NO. 14.7 SHEET OF

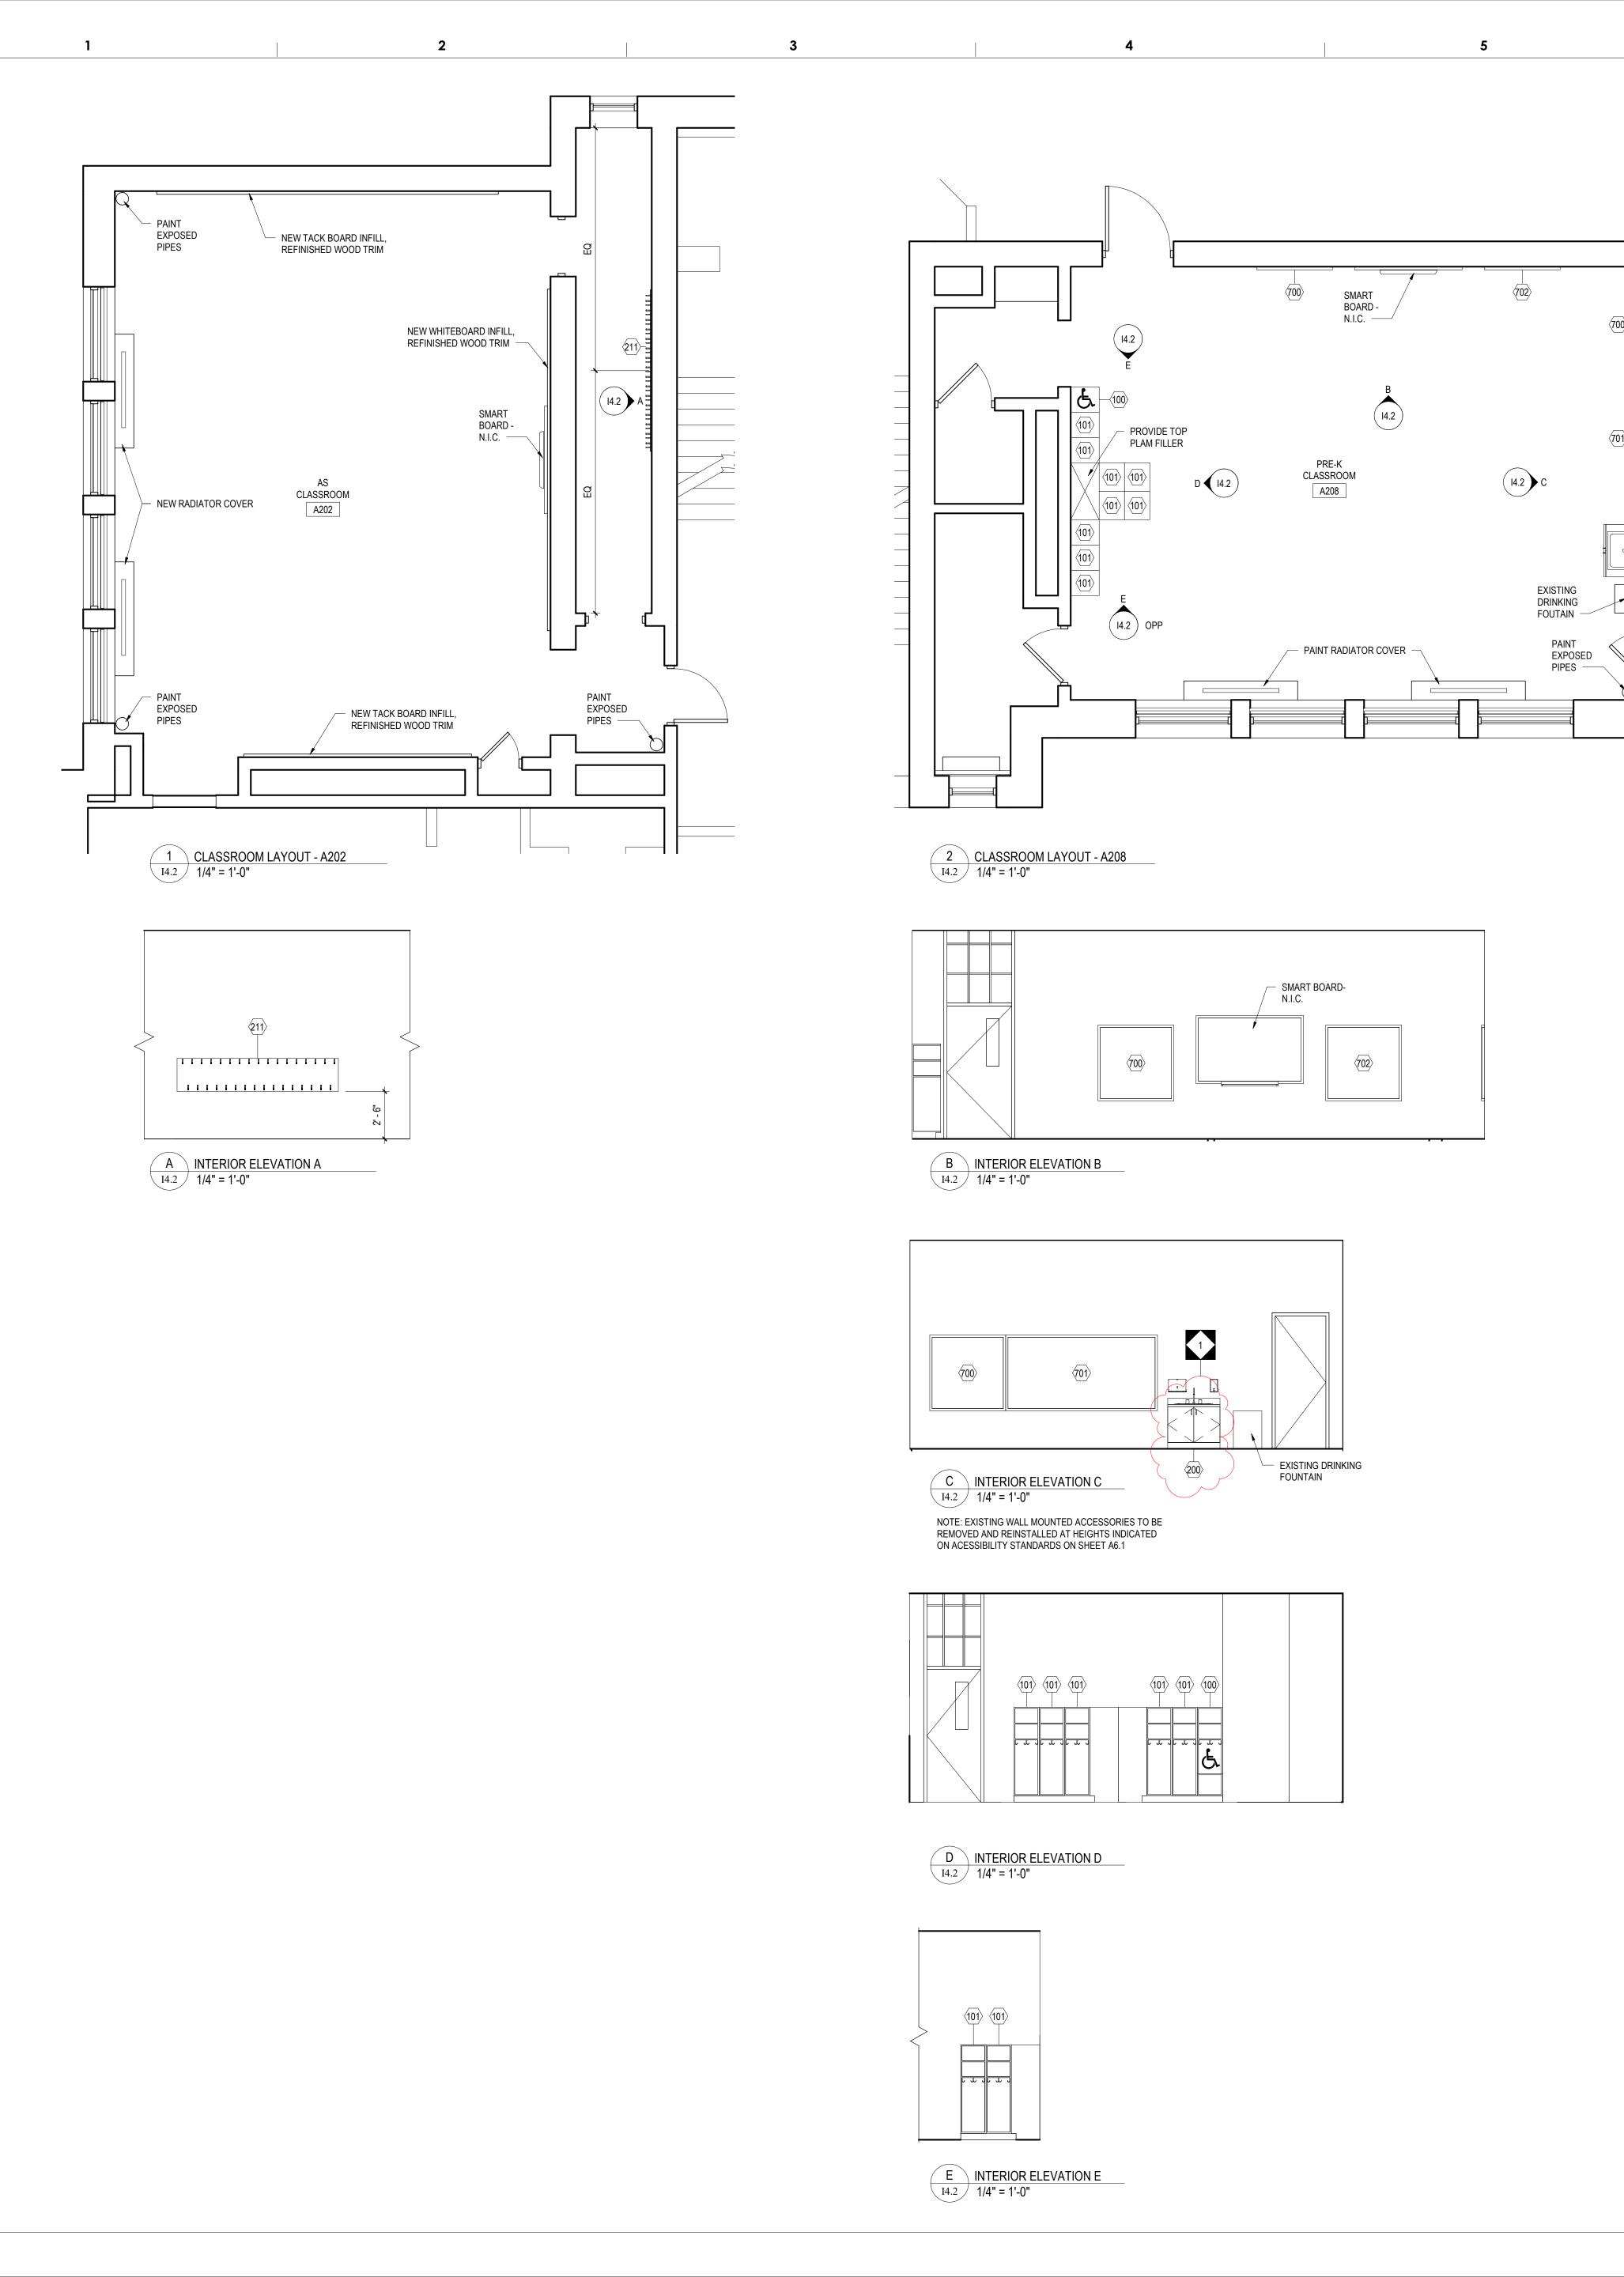


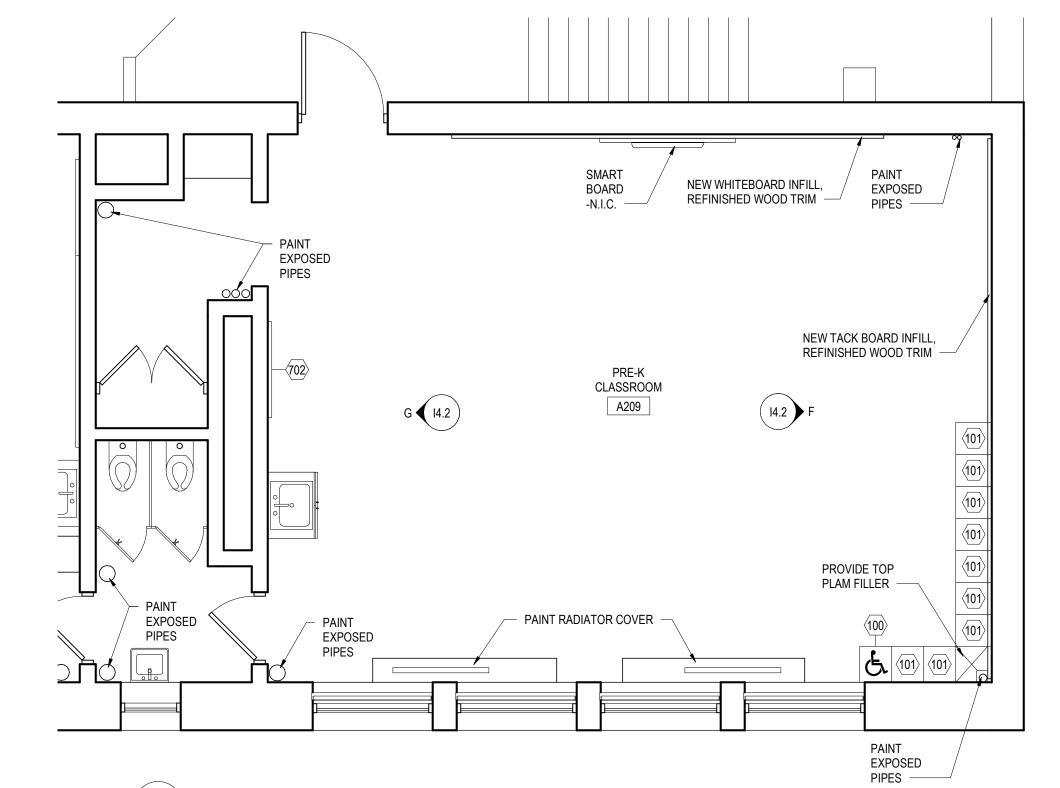

3 CLASSROOM LAYOUT - A209 1/4" = 1'-0"

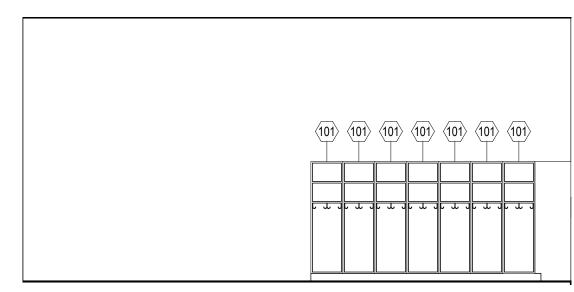

F INTERIOR ELEVATION F
14.2 1/4" = 1'-0"

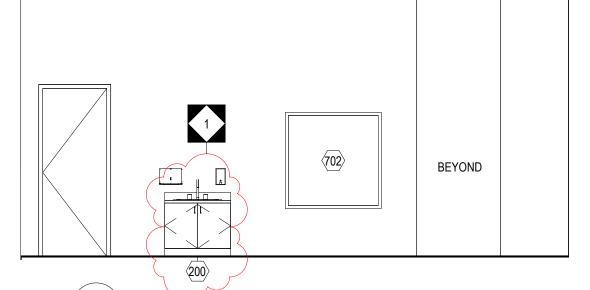

G INTERIOR ELEVATION G
14.2 1/4" = 1'-0"

ON ACESSIBILITY STANDARDS ON SHEET A6.1

NOTE: EXISTING WALL MOUNTED ACCESSORIES TO BE REMOVED AND REINSTALLED AT HEIGHTS INDICATED



BASE CABINETS

2'-2" AFF TO TOP OF CABINET

NOTE: WHERE NEW MARKER BOARD OR TACK BOARD IS BEING MOUNTED NEXT TO OR ON THE SAME WALL AS AN EXISTING TACK BOARD OR MARKER BOARD MATCH EXISTING HEIGHT.

| | | BOARD WATCH EXISTING HEIGHT. | , , , , , , , , , , , , , , , , , , , |
|---|-----|---|---|
| | | 14.2 - GENERAL CASEWORK AND EQUIPMENT SCHEDULE | |
| | NO | DESCRIPTION | DIMENSIONS |
| - | 211 | STUDENT COAT HOOKS - MODIFIED TO INCLUDE PLYWOOD W/ HIGH PRESSURE LAMINATE ON ALL EXPOSED SURFACE W/ (30) COAT HOOKS AND HEAVY DUTY SUPPORT BRACKETS PER MANF. RECOMMENDATIONS. | 8'-6"W x 1'-9"H |
| - | 100 | ADA OPEN STUDENT WARDROBE W/(1) DOUBLE HOOK & (2) SINGLE HOOKS EACH. MODIFIED TO INCLUDE (2) FIXED SHELVES ABOVE. SEE ADA KINDERGARTEN CUBBIE DETAIL. | 16"W x 18"D x 60"H |
| | 101 | OPEN STUDENT WARDROBE W/(1) DOUBLE HOOK & (2) SINGLE HOOKS EACH. MODIFIED TO INCLUDE (2) FIXED SHELVES ABOVE. SEE KINDERGARTEN CUBBIE DETAIL. | 16"W x 18"D x 60"H |
| | 200 | 2-DOOR SINK BASE CABINET | 33"W x 24"D x 28"H 1 |
| | 700 | MARKERBOARD | 4'-0"W x 4'-0"H |
| | 701 | TACK BOARD | 8'-0"W x 4'-0"H |
| | 702 | TACK BOARD | 4'-0"W x 4'-0"H |

THE SCHOOL DISTRICT OF PHILADELPHIA

OFFICE OF CAPITAL PROGRAMS

440 NORTH BROAD STREET
PHILADELPHIA, PA 19130 - 4015
(215) 400 - 4730 | (215) 400 - 4731 (fax)
www.philasd.org

SEAL:



R. JEFFREY STRAUB, AIA DATE PENNSYLVANIA 04/20/2018

<u>ARCHITECT</u>

CRABTREE, ROHRBAUGH & ASSOCIATES -ARCHITECTS
401, EAST WINDING HILL ROAD
MECHANICSBURG, PA 17055
717-458-0272
717-458-0047
www.cra-architects.com

MEP ENGINEER

Attn: R. Jeffrey Straub

GLOBAL ENGINEERING SOLUTIONS 6700A ROCKLEDGE DR. SUITE 301 BETHESDA, MD 20817 301-216-2871 301-216-9671 www.theges.com Attn: Anil Giri

SCHOOL & LOCATION

JOHN H. TAGGART 400 W. PORTER STREET, PHILADELPHIA, PA 19148


PROJECT TITLE

CLASSROOM MODERNIZATION

DRAWING TITLE

LARGE SCALE LAYOUTS -CLASSROOMS

| LOCATION NO. | FILE | ENO. |
|------------------|------|------------------------|
| DRAWN BY | СН | ECKED BY |
| B-047C B-050C | | 2017 / 18 2017 / 18 |
| | | |
| DRAWING NO. | | |
| DRAWING NO. | | |

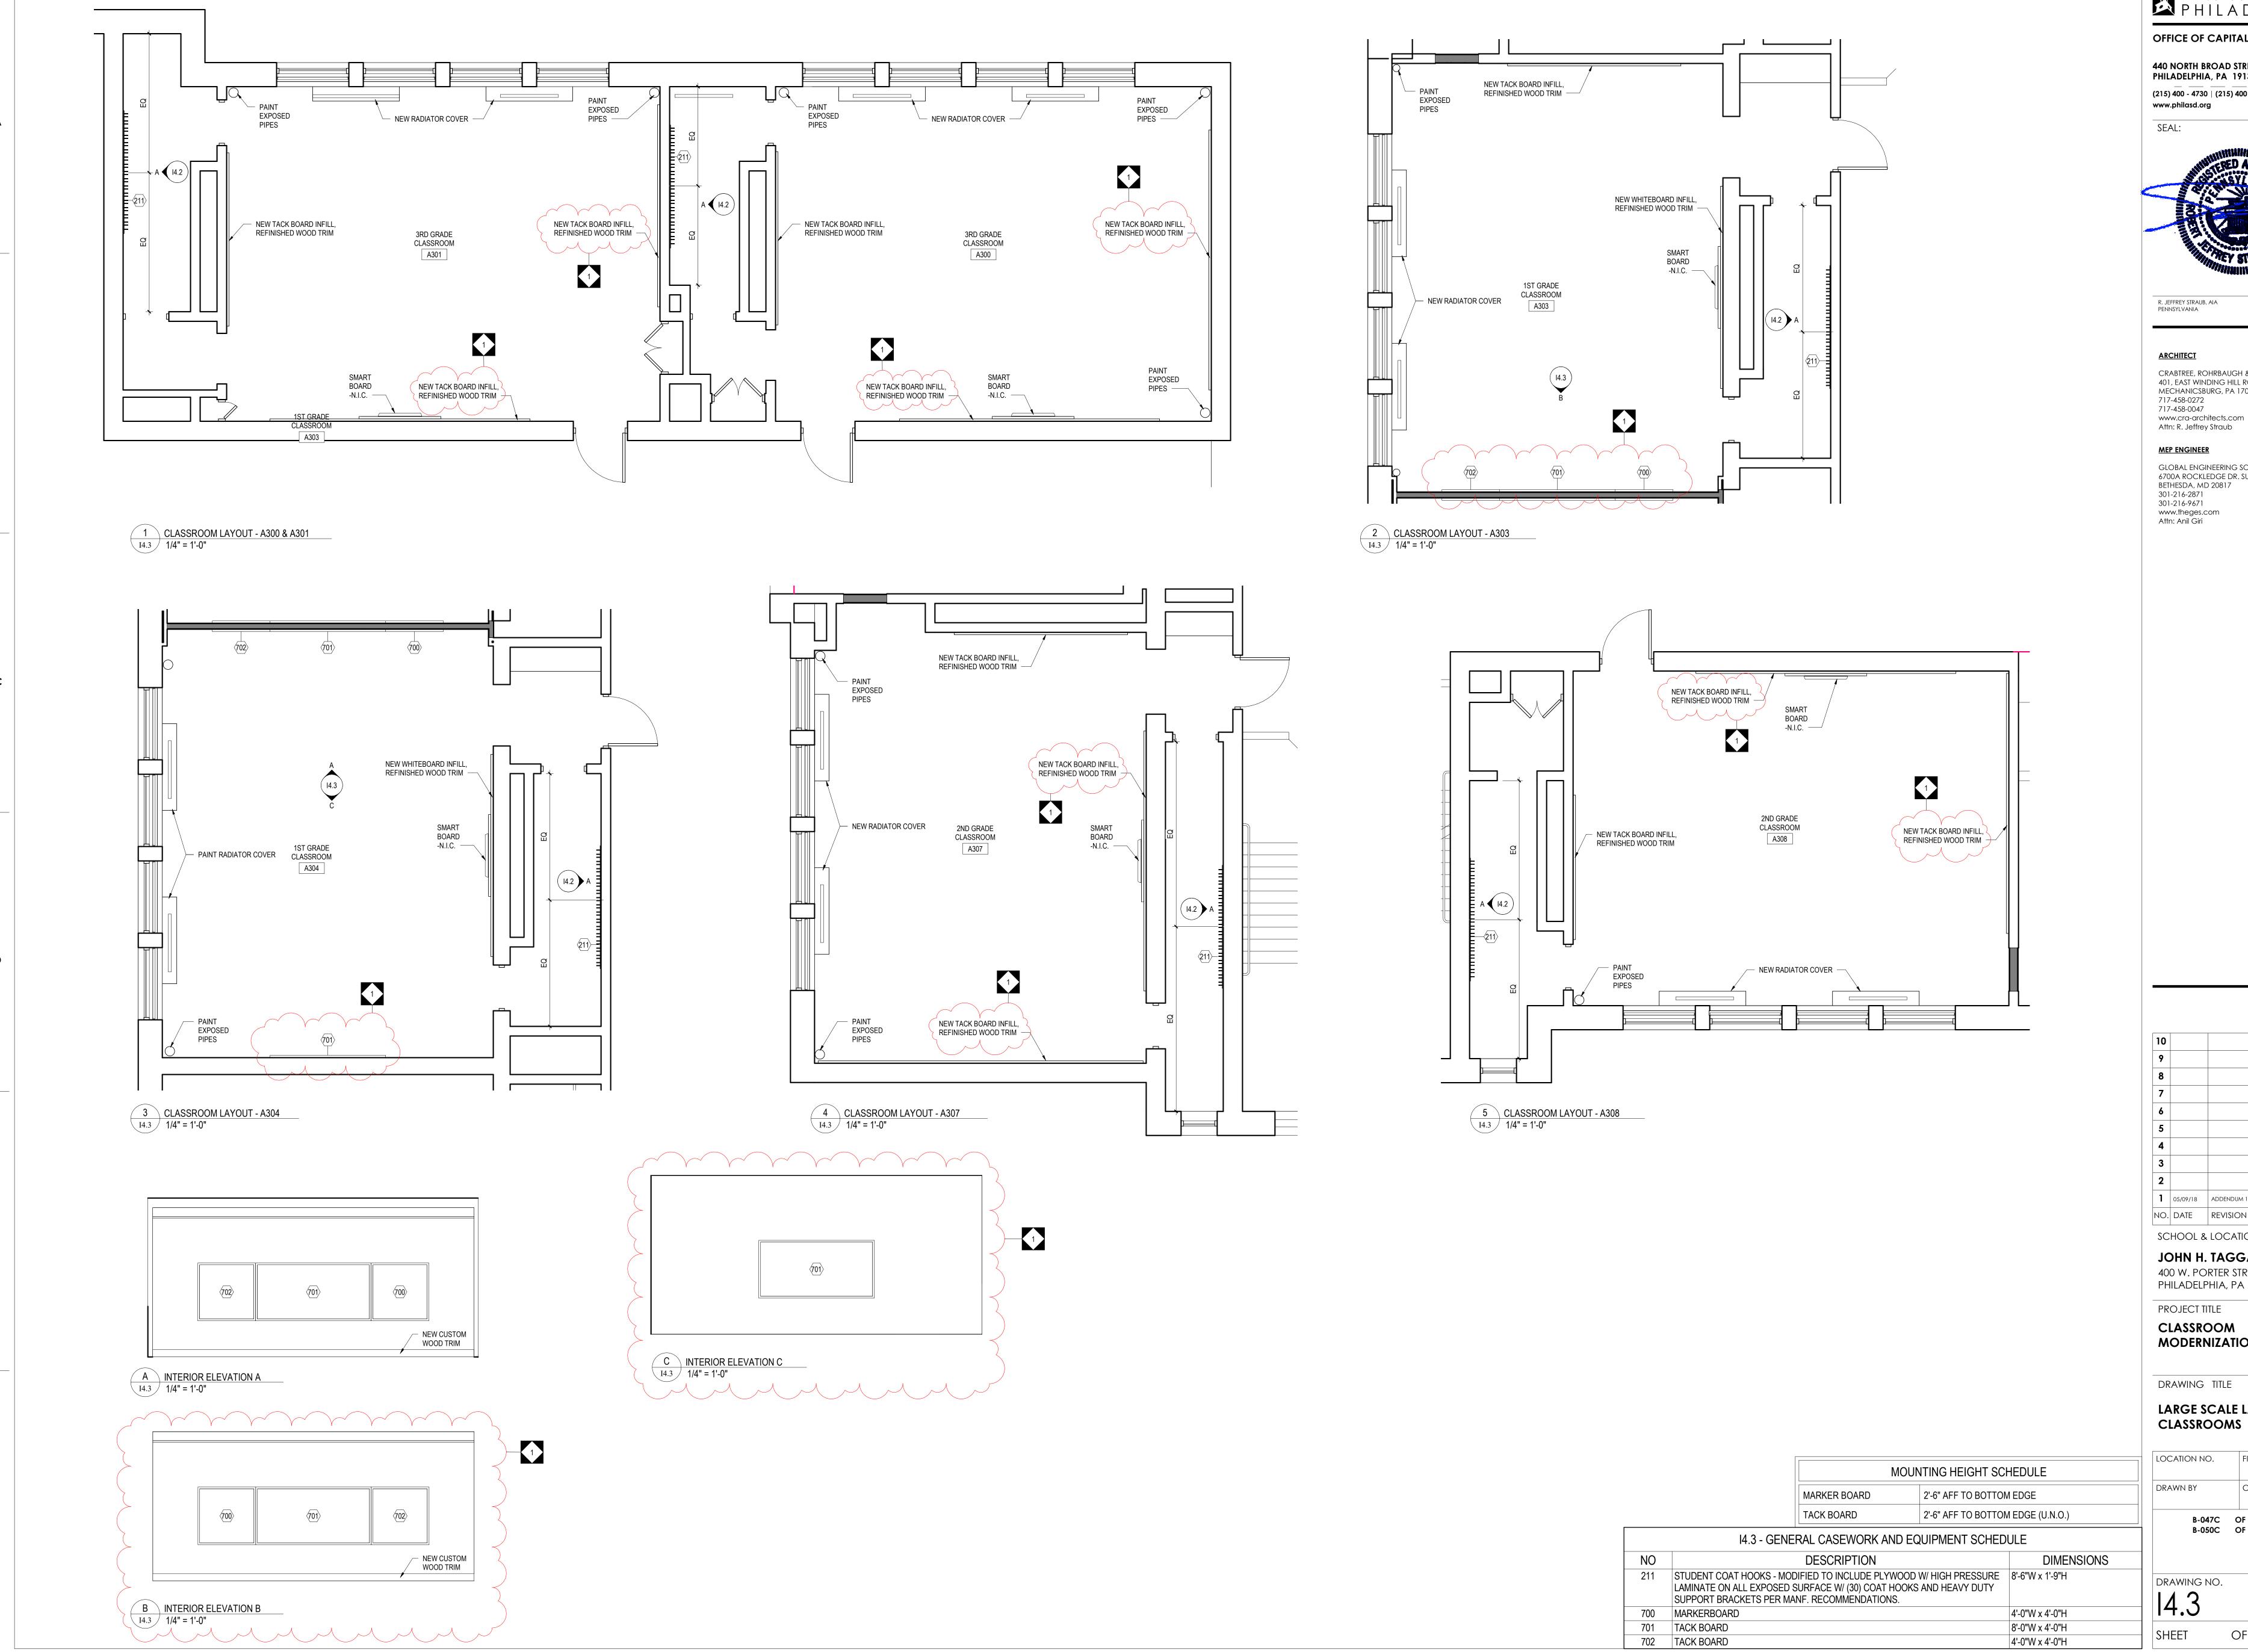

THE SCHOOL DISTRICT OF PHILADELPHIA

OFFICE OF CAPITAL PROGRAMS

440 NORTH BROAD STREET **PHILADELPHIA, PA 19130 - 4015** (215) 400 - 4730 | (215) 400 - 4731 (fax)



R. JEFFREY STRAUB, AIA PENNSYLVANIA

CRABTREE, ROHRBAUGH & ASSOCIATES -ARCHITECTS 401, EAST WINDING HILL ROAD MECHANICSBURG, PA 17055 717-458-0272 717-458-0047

DATE 04/20/2018

MEP ENGINEER

GLOBAL ENGINEERING SOLUTIONS 6700A ROCKLEDGE DR. SUITE 301 BETHESDA, MD 20817 301-216-2871 301-216-9671 www.theges.com

1 05/09/18 ADDENDUM 1 NO. DATE REVISION

SCHOOL & LOCATION JOHN H. TAGGART

400 W. PORTER STREET, PHILADELPHIA, PA 19148

MODERNIZATION

DRAWING TITLE

8'-0"W x 4'-0"H


4'-0"W x 4'-0"H

701 TACK BOARD

702 TACK BOARD

LARGE SCALE LAYOUTS -CLASSROOMS

| LOCATION NO. | FILE | NO. | |
|--------------|----------|----------|--|
| DRAWN BY | СНІ | ECKED BY | |
| | OF OF | • | |
| | | | |
| DRAWING NO. | | | |
| DRAWING NO. | | | |

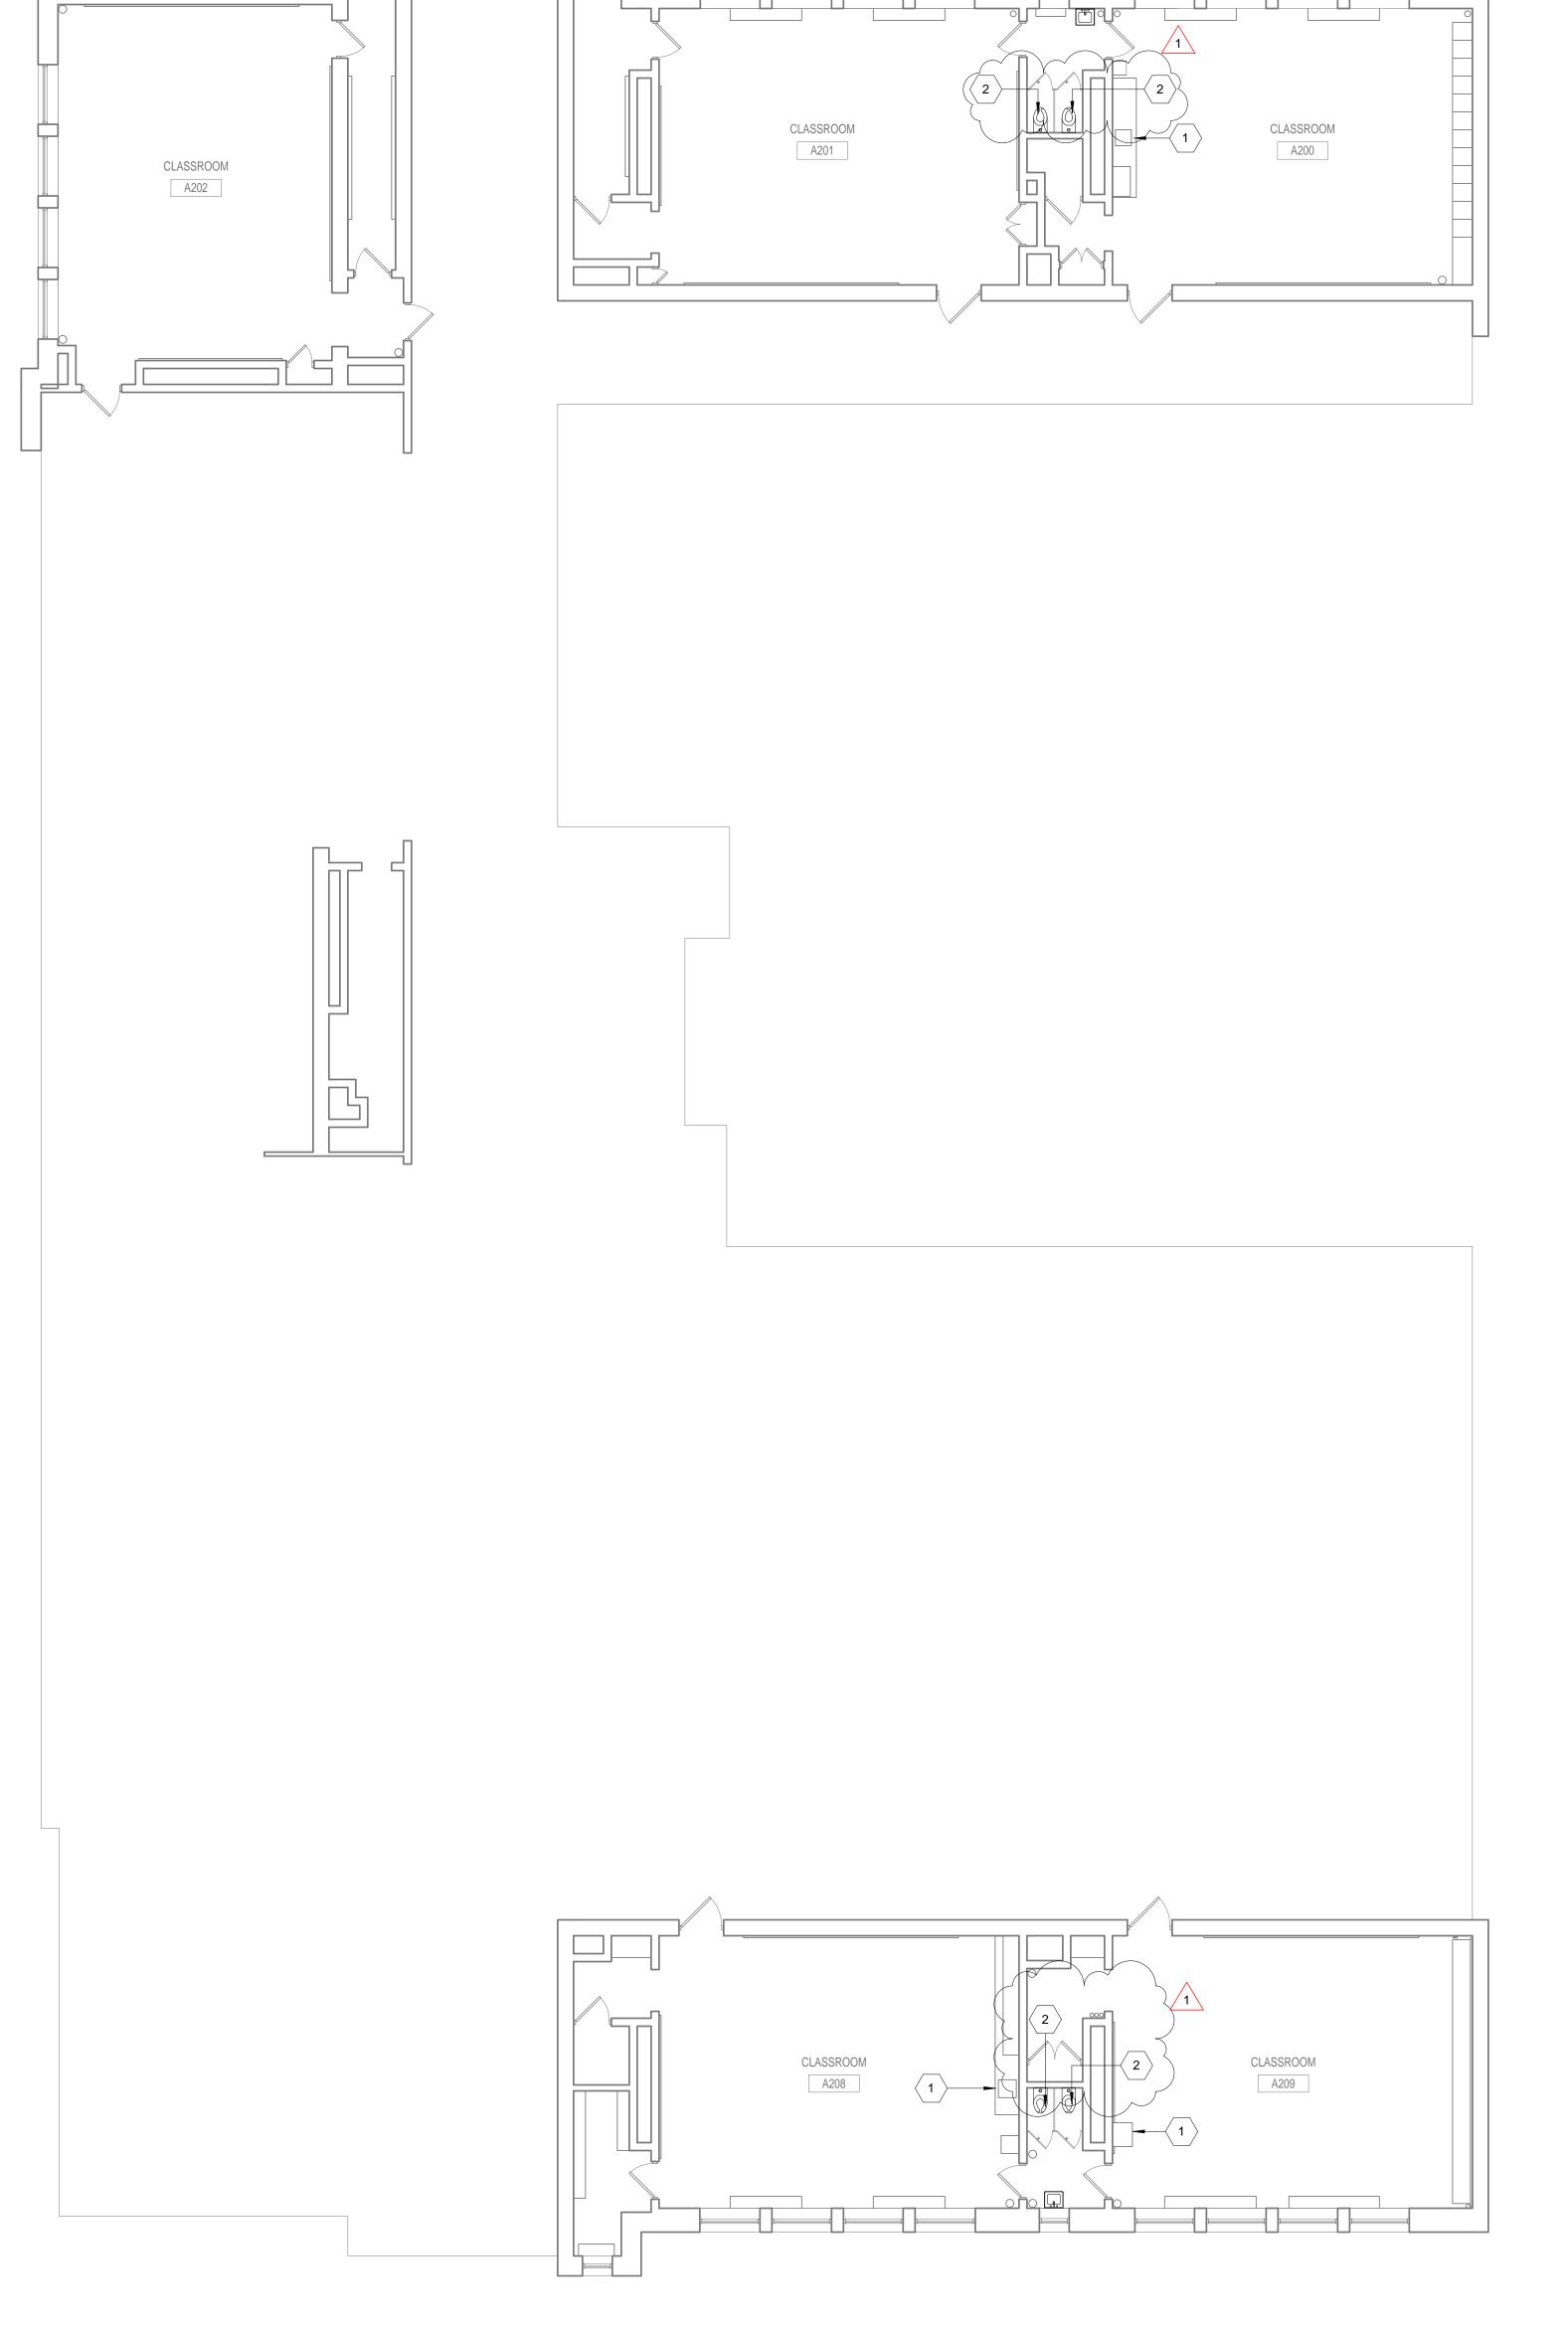



REFER TO P001 FOR GENERAL NOTES,
SYMBOL LEGEND AND LIST OF
ABBREVIATIONS.
INSTALL NEW VALVES AND CAP WATER AND
DRAIN LINES SECURELY PRIOR TO
SUBSTANTIAL COMPLETION OF SINK INSTALLATION.

OFFICE OF CAPITAL PROGRAMS

THE SCHOOL DISTRICT OF PHILADELPHIA

440 NORTH BROAD STREET PHILADELPHIA, PA 19130 - 4015 (215) 400 - 4730 | (215) 400 - 4731 (fax)

SEAL:

www.philasd.org



R. JEFFREY STRAUB, AIA PENNSYLVANIA

CRABTREE, ROHRBAUGH & ASSOCIATES -ARCHITECTS 401, EAST WINDING HILL ROAD MECHANICSBURG, PA 17055 717-458-0272 717-458-0047 www.cra-architects.com

MEP ENGINEER

Attn: R. Jeffrey Straub

Global Engineering Solutions® 6700A ROCKLEDGE DR. SUITE 301 BETHESDA, MARYLAND 20817 (T) 301-216-2871 (F) 301-216-9671 www.THEGES.com Attn: Anil Giri

***** KEYED NOTES

REMOVE AND DISPOSE OF PLUMBING FIXTURE. CAP EXISTING STUB-OUTS FOR CONNECTION TO NEW FIXTURE. REMOVE THE TOILET, STORE PROPERLY FOR REINSTALLATION.

FIRST LEVEL - PLUMBING FLOOR PLAN - DEMOLITION

1/8" = 1'-0"

CLASSROOM

A107

1 05/09/18 ADDENDUM 1 NO. DATE REVISION SCHOOL & LOCATION

JOHN H. TAGGART 400 W. PORTER STREET

PHILADELPHIA, PA 19148

PROJECT TITLE **CLASSROOM**

MODERNIZATION

DRAWING TITLE

FIRST & SECOND LEVEL -PLUMBING FLOOR PLANS -

DEMOLITION FILE NO. LOCATION NO. CHECKED BY


B-047C OF 2017 / 18 B-050C OF 2017 / 18


DRAWING NO. PD111 SHEET OF

SCALE: 1/8"=1'-0"

SECOND LEVEL - PLUMBING FLOOR PLAN - DEMOLITION

1/8" = 1'-0"

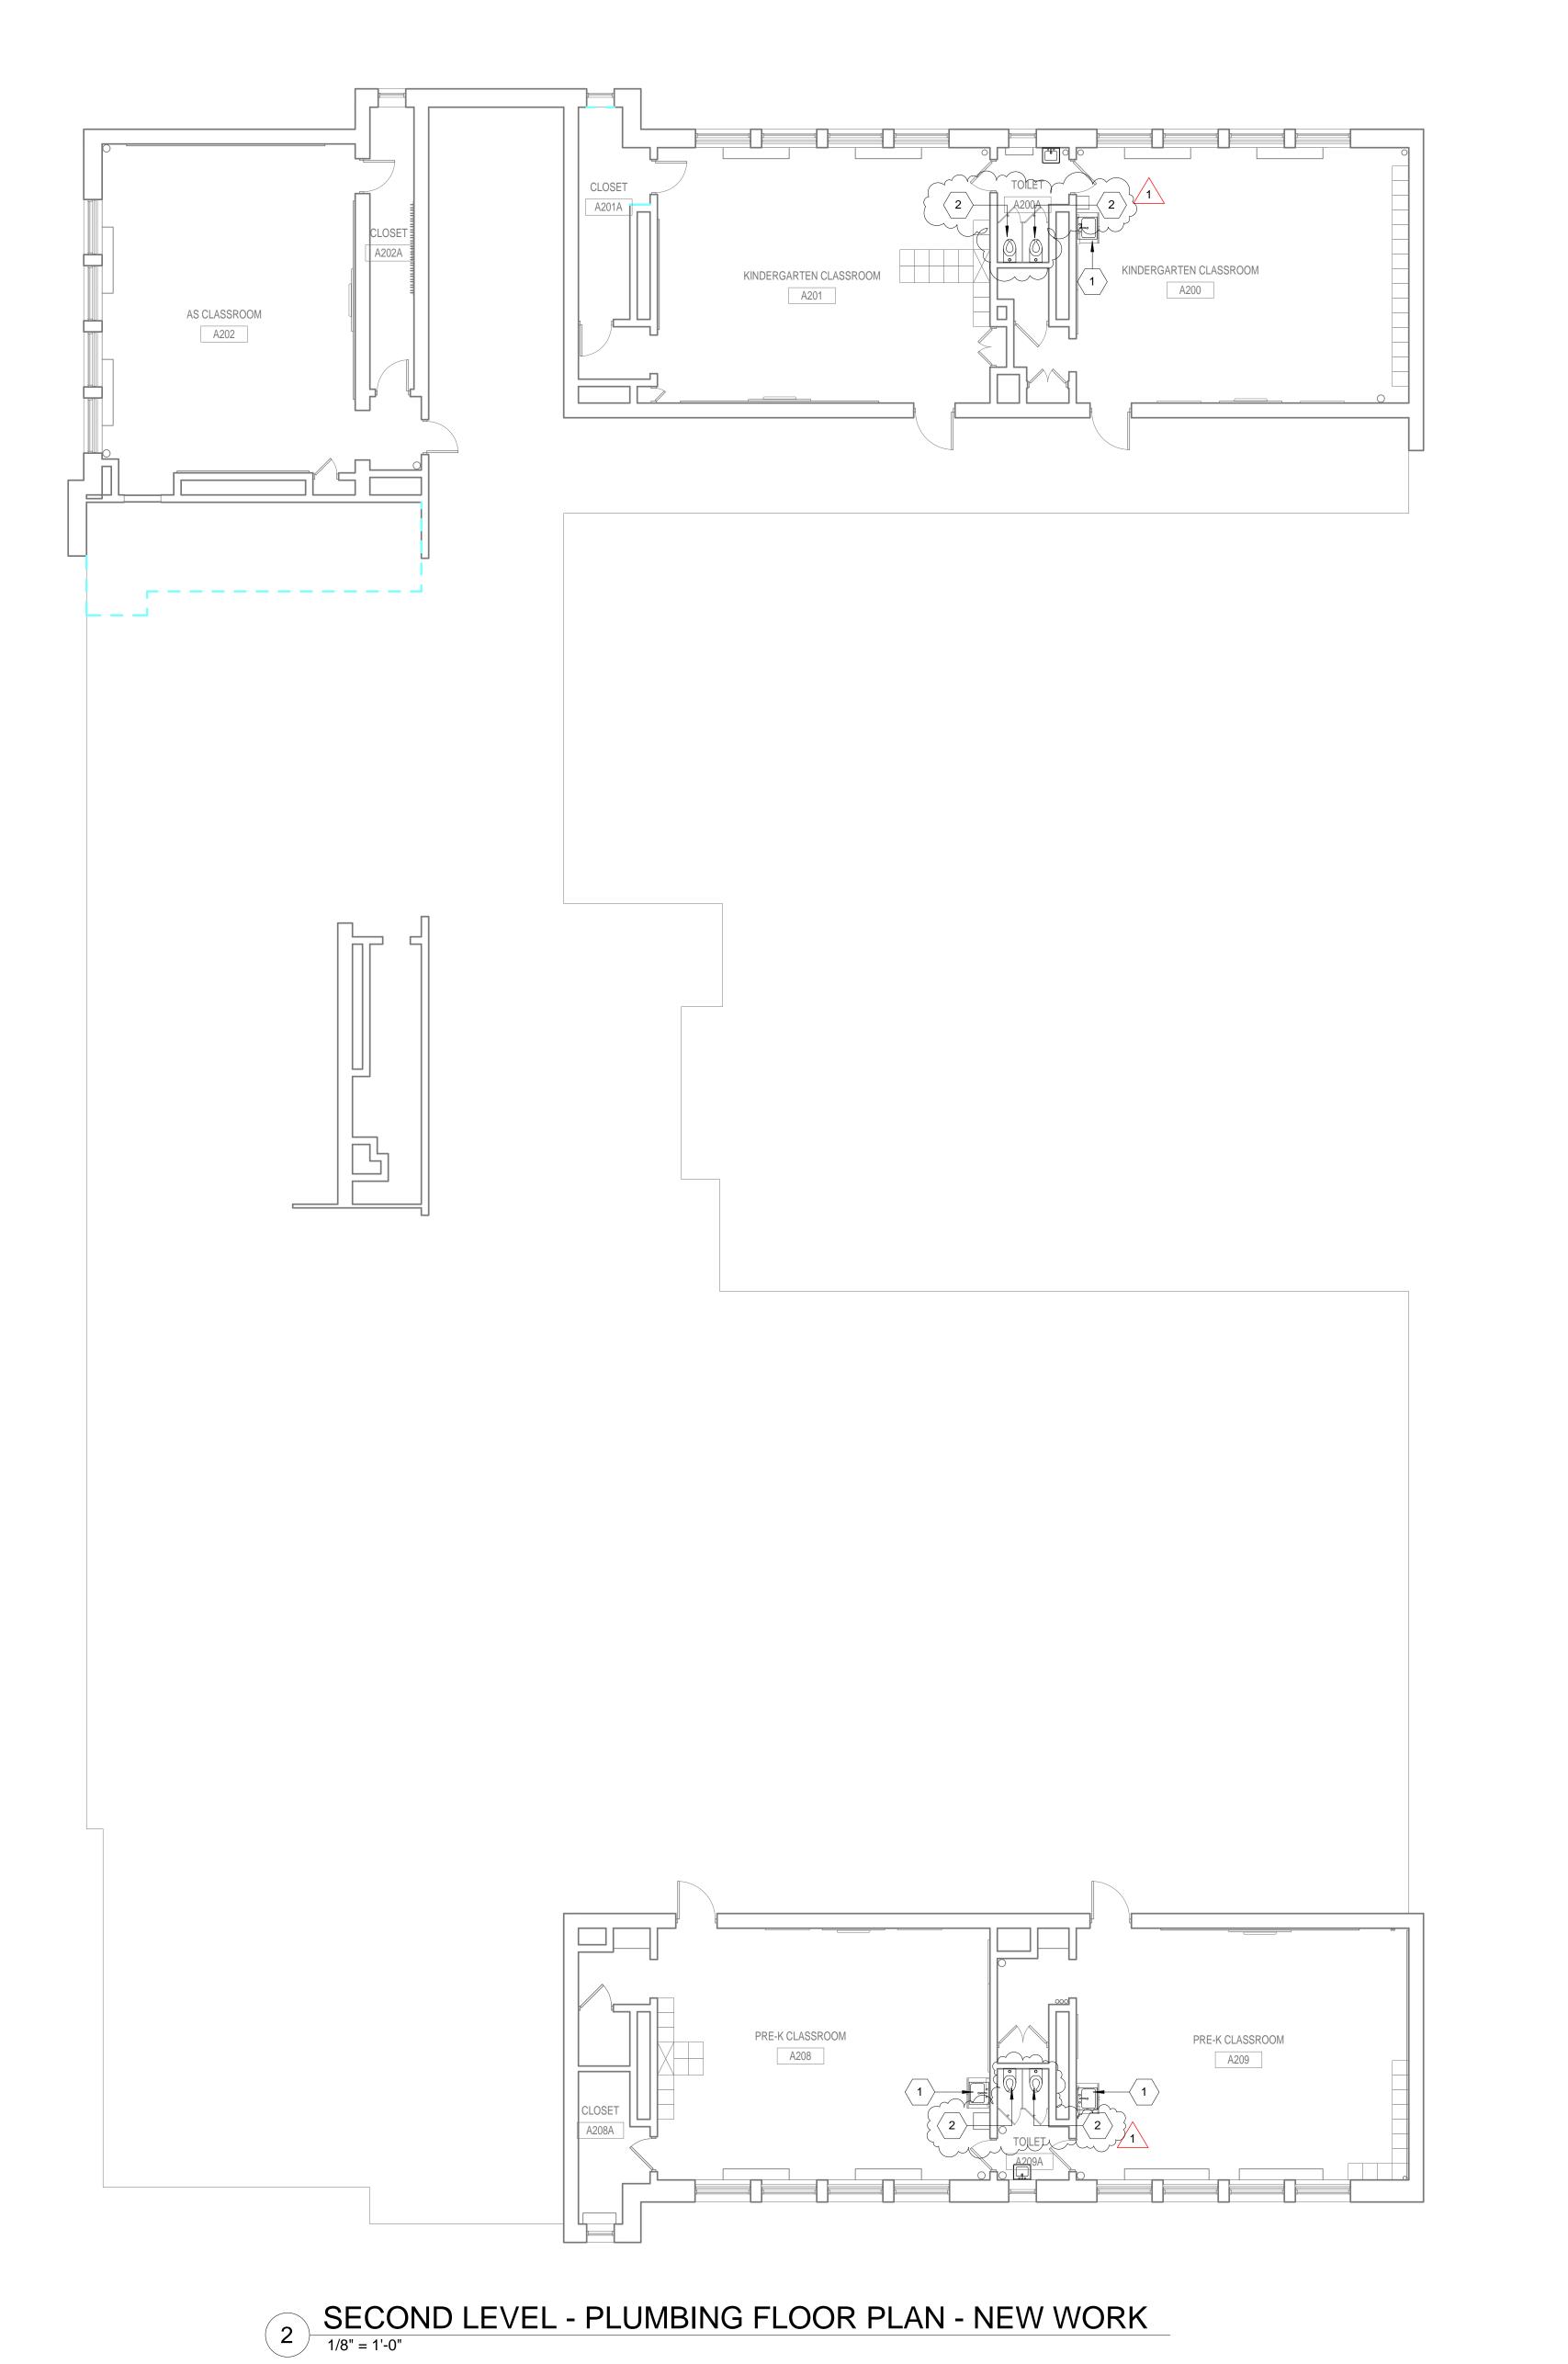

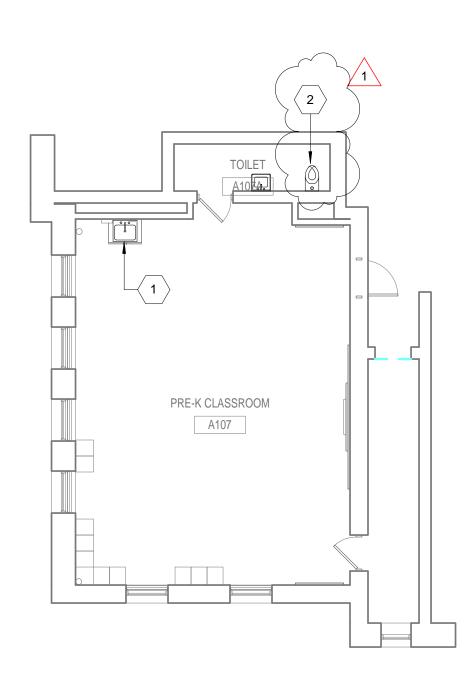

FIRST LEVEL - PLUMBING FLOOR PLAN - NEW WORK

GENERAL NOTES

1. REFER TO P001 FOR GENERAL NOTES, SYMBOL LEGEND AND LIST OF

ABBREVIATIONS.

2. INSTALL NEW VALVES AND CAP WATER AND DRAIN LINES SECURELY PRIOR TO SUBSTANTIAL COMPLETION OF SINK INSTALLATION.

3. PROVIDE INSULATION FOR PIPE ON RISERS WHERE ORIGINAL INSULATION WERE REMOVED PER ABATEMENT SPECS. MATCH WITH EXISTING INSULATION MATERIAL.

***** KEYED NOTES

PROVIDE STAINLESS STEEL SINK ELKAY LR1517 WITH CHICAGO

FUNCTIONALITY. CONNECT NEW

VERIFY SIZE AND LOCATION OF

REINSTALL THE TOILET, ADJUST THE FLANGE AND TAIL PIECE FOR

PROVIDE ACCESSARIES FOR A

FAUCET 786-CP OR APPROVED

EQUAL. PROVIDE VALVES AND

FIXTURE TO EXISTING PIPING.

ACCESSORIES FOR FULL

EXISTING PIPNIG IN FIELD

THE NEW FLOOR HEIGHT.

COMPLETE INSTALLATION.

SEAL:



PHILADELPHIA

OFFICE OF CAPITAL PROGRAMS

440 NORTH BROAD STREET

www.philasd.org

PHILADELPHIA, PA 19130 - 4015

(215) 400 - 4730 | (215) 400 - 4731 (fax)

R. JEFFREY STRAUB, AIA DATE PENNSYLVANIA 03/24

ARCHITECT

CRABTREE, ROHRBAUGH & ASSOCIATES -ARCHITECTS 401, EAST WINDING HILL ROAD MECHANICSBURG, PA 17055 717-458-0272 717-458-0047 www.cra-architects.com Attn: R. Jeffrey Straub

MEP ENGINEER GES

Global Engineering Solutions®
6700A ROCKLEDGE DR. SUITE 301
BETHESDA, MARYLAND 20817
(T) 301-216-2871 (F) 301-216-9671
www.THEGES.com
Attn: Anil Giri

1 05/09/18 ADDENDUM 1
NO. DATE REVISION

SCHOOL & LOCATION

JOHN H. TAGGART

PHILADELPHIA, PA 19148

PROJECT TITLE

400 W. PORTER STREET

MODERNIZATION

CLASSROOM

FIRST & SECOND LEVEL -


PLUMBING FLOOR PLAN NEW WORK

LOCATION NO. FILE NO.

B-047C OF 2017 / 18
B-050C OF 2017 / 18

P111
SHEET OF

0' 4' 8' 16' SCALE: 1/8"=1'-0"

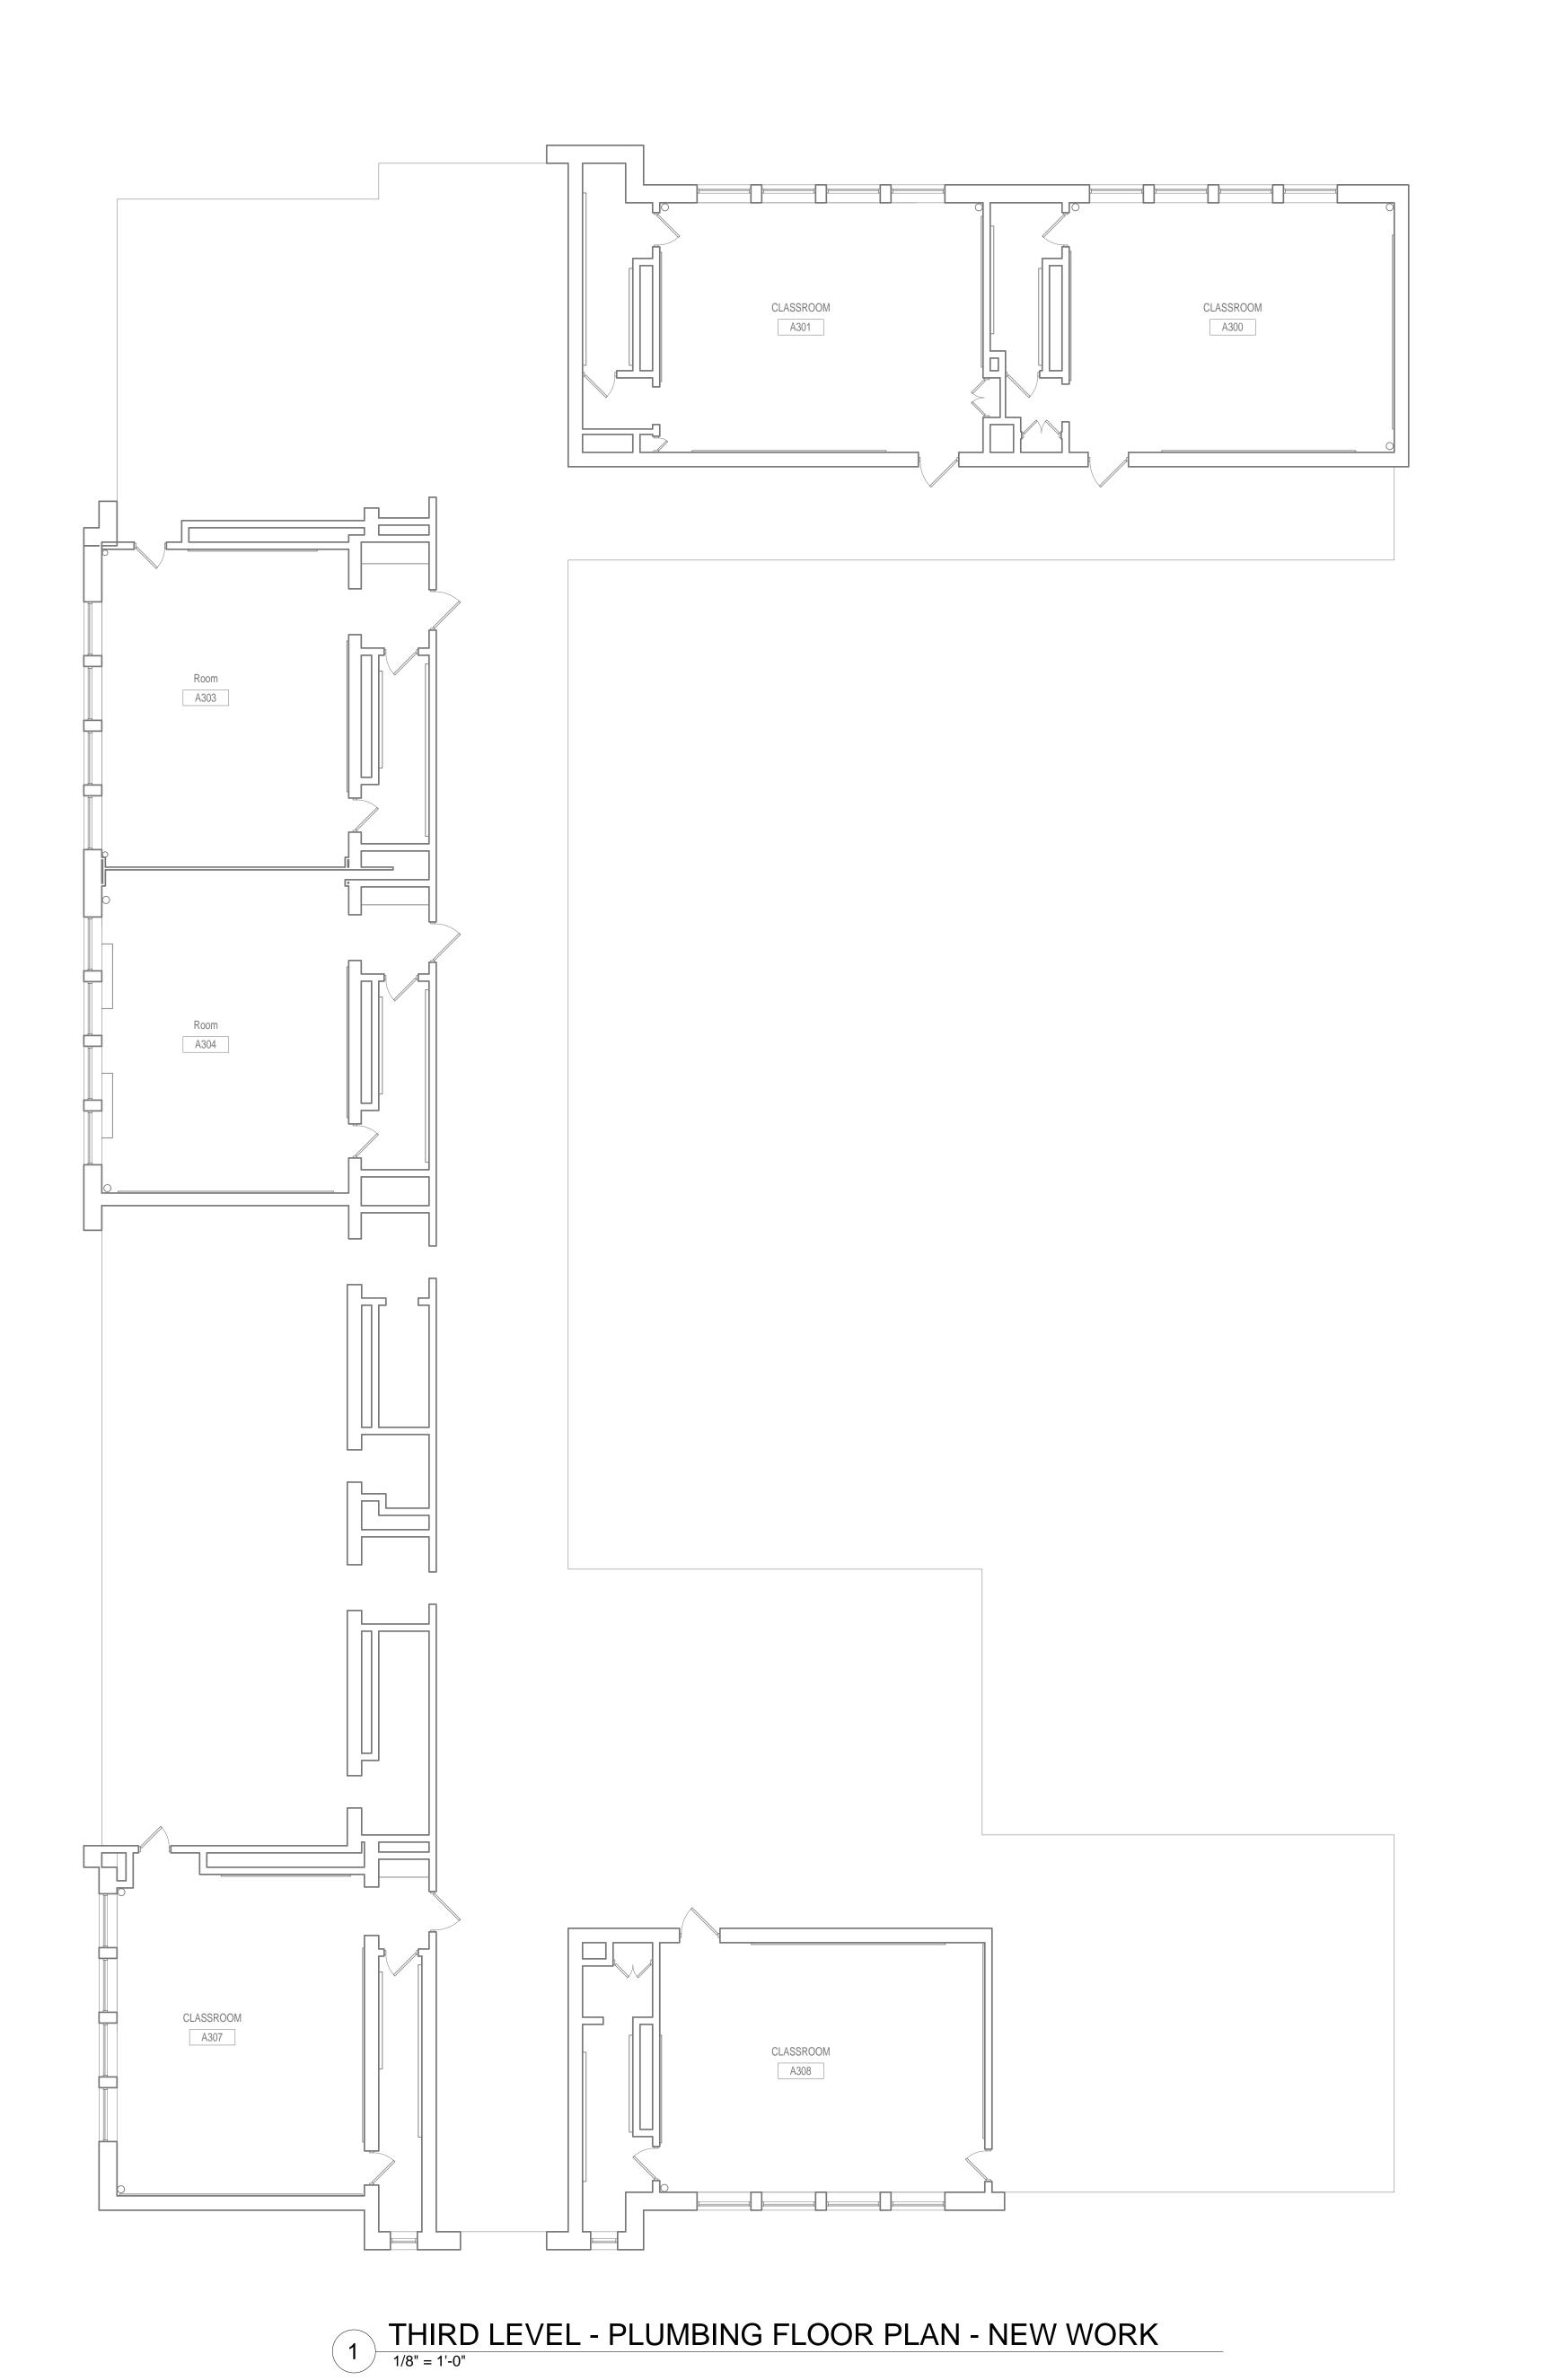

GENERAL NOTES

REFER TO P001 FOR GENERAL NOTES, SYMBOL LEGEND AND LIST OF

SYMBOL LEGEND AND LIST OF
ABBREVIATIONS.

2. INSTALL NEW VALVES AND CAP WATER AND
DRAIN LINES SECURELY PRIOR TO
SUBSTANTIAL COMPLETION OF SINK
INSTALLATION.

3. PROVIDE INSULATION FOR PIPE ON RISERS
WHERE ORIGINAL INSULATION WERE
REMOVED PER ABATEMENT SPECS. MATCH
WITH EXISTING INSULATION MATERIAL.

OFFICE OF CAPITAL PROGRAMS

440 NORTH BROAD STREET PHILADELPHIA, PA 19130 - 4015 (215) 400 - 4730 | (215) 400 - 4731 (fax)

THE SCHOOL DISTRICT OF PHILADELPHIA

SEAL:

www.philasd.org



KEYED NOTES

ARCHITECT


R. JEFFREY STRAUB, AIA PENNSYLVANIA

CRABTREE, ROHRBAUGH & ASSOCIATES -ARCHITECTS
401, EAST WINDING HILL ROAD
MECHANICSBURG, PA 17055
717-458-0272
717-458-0047
www.cra-architects.com

MEP ENGINEER

Attn: R. Jeffrey Straub

Global Engineering Solutions®
6700A ROCKLEDGE DR. SUITE 301
BETHESDA, MARYLAND 20817
(T) 301-216-2871 (F) 301-216-9671
www.THEGES.com
Attn: Anil Giri

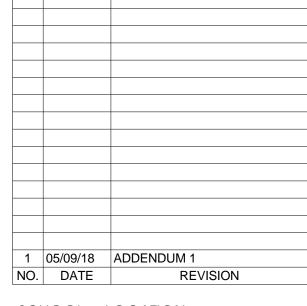

SCHOOL & LOCATION

John H. Taggart 400 W. Porter Street Philadelphia, pa 19148

PROJECT TITLE

CLASSROOM MODERNIZATION

DRAWING TITLE

THIRD LEVEL - PLUMBING FLOOR PLAN - NEW WORK


DRAWN BY

CHECKED BY

B-047C OF 2017 / 18
B-050C OF 2017 / 18

DRAWING NO.

0' 15' 30'\' 60' SCALE: 1"=30''-0"\"

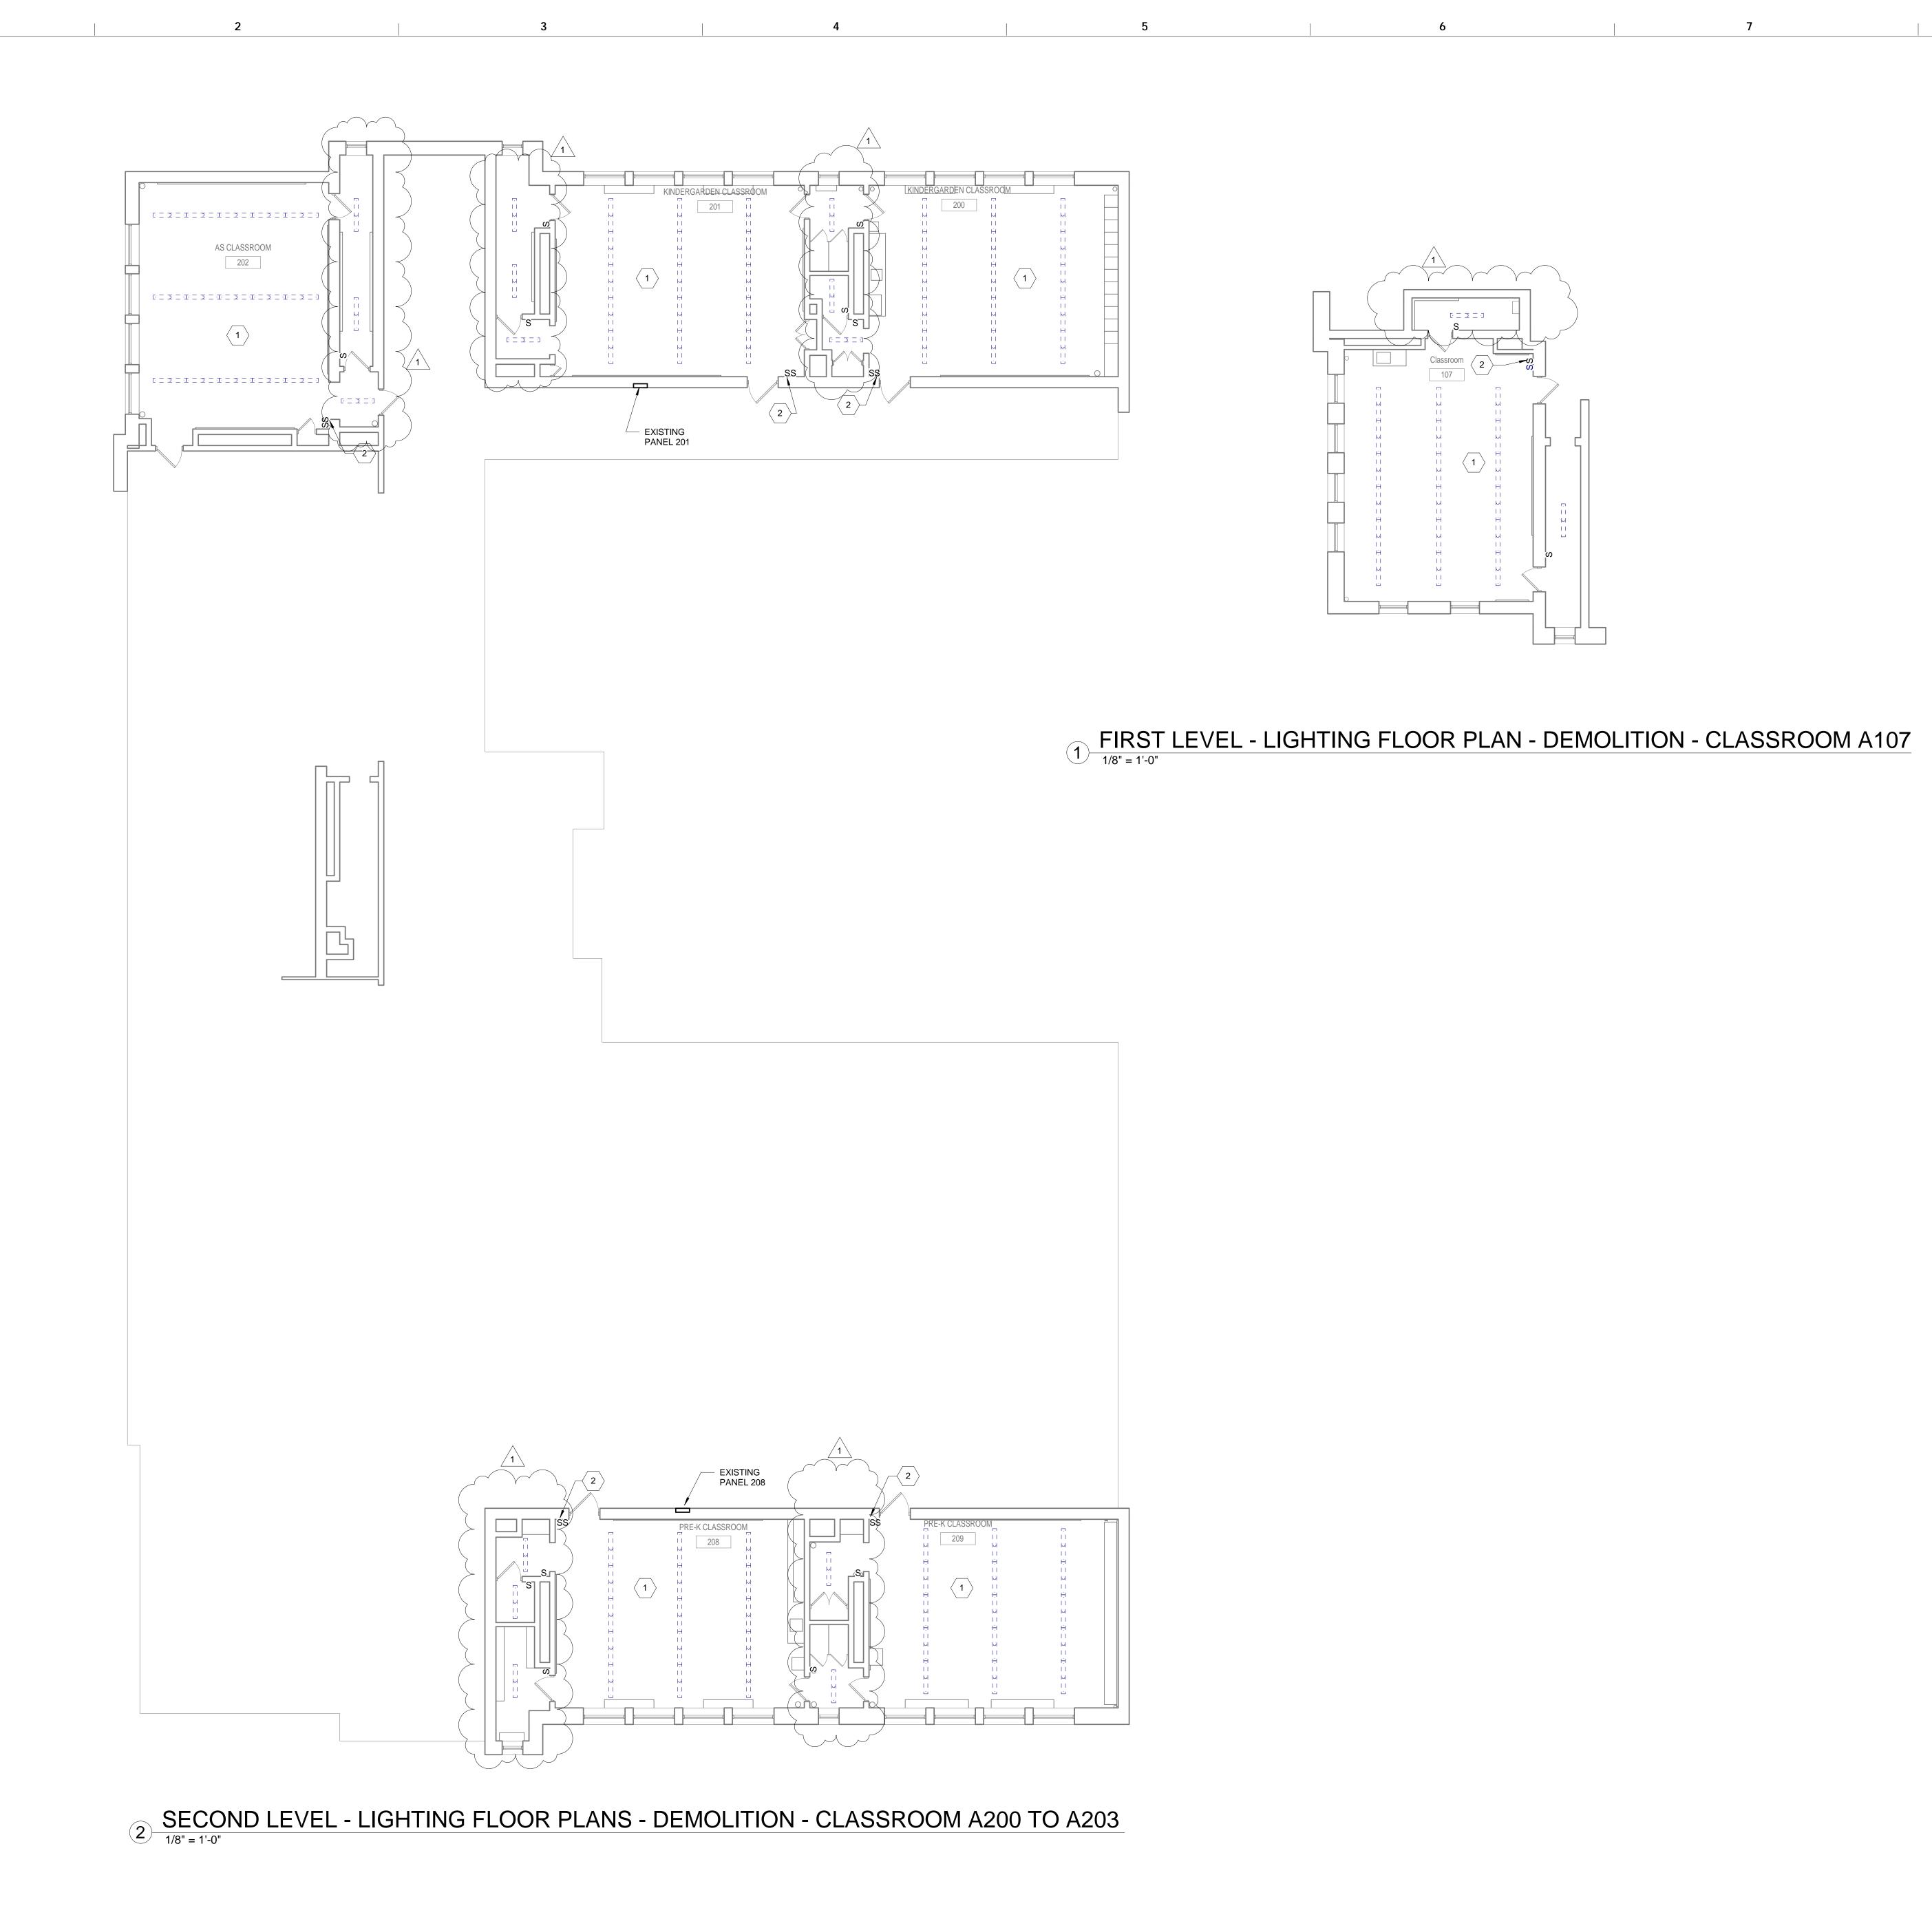

GENERAL NOTES

NEW CIRCUIT.

REFER TO E001 FOR GENERAL NOTES, SYMBOL LEGEND AND LIST OF ABBREVIATIONS.

CONTRACTOR SHALL UPDATE EXISTING PANELBOARD DIRECTORY FOR ADDITIONAL

440 NORTH BROAD STREET PHILADELPHIA, PA 19130 - 4015

THE SCHOOL DISTRICT OF PHILADELPHIA

OFFICE OF CAPITAL PROGRAMS

(215) 400 - 4730 | (215) 400 - 4731 (fax) www.philasd.org



KEYED NOTES

1 DISCONNECT AND REMOVE ALL EXISTING LIGHT FIXTURES FROM NOTED AREAS. EXISTING LIGHTING CIRCUIT TO REMAIN

TO REMAIN.

LIGHTING CIRCUIT TO REMAIN.

2 DISCONNECT AND REMOVE ALL EXISTING LIGHT SWITCH WITH COVER PLATE, EXISTING CIRCUIT

R. JEFFREY STRAUB, AIA DATE
PENNSYLVANIA 03/29/2018

<u>ARCHITECT</u>

CRABTREE, ROHRBAUGH & ASSOCIATES -ARCHITECTS 401, EAST WINDING HILL ROAD MECHANICSBURG, PA 17055 717-458-0272 717-458-0047 www.cra-architects.com

MEP ENGINEER

Attn: R. Jeffrey Straub

Global Engineering Solutions®
6700A ROCKLEDGE DR. SUITE 301
BETHESDA, MARYLAND 20817
(T) 301-216-2871 (F) 301-216-9671
www.THEGES.com
Attn: Anil Giri

1 05/09/18 ADDENDUM 1
NO. DATE REVISION

SCHOOL & LOCATION

John H. Taggart 400 W. Porter Street Philadelphia, pa 19148

PROJECT TITLE

CLASSROOM

MODERNIZATION

DRAWING TITLE


FIRST & SECOND LEVEL -LIGHTING FLOOR PLANS -DEMOLITION

DRAWN BY

B-047C OF 2017 / 18
B-050C OF 2017 / 18

DRAWING NO.
ED111

SCALE: 1"=30''-0")"

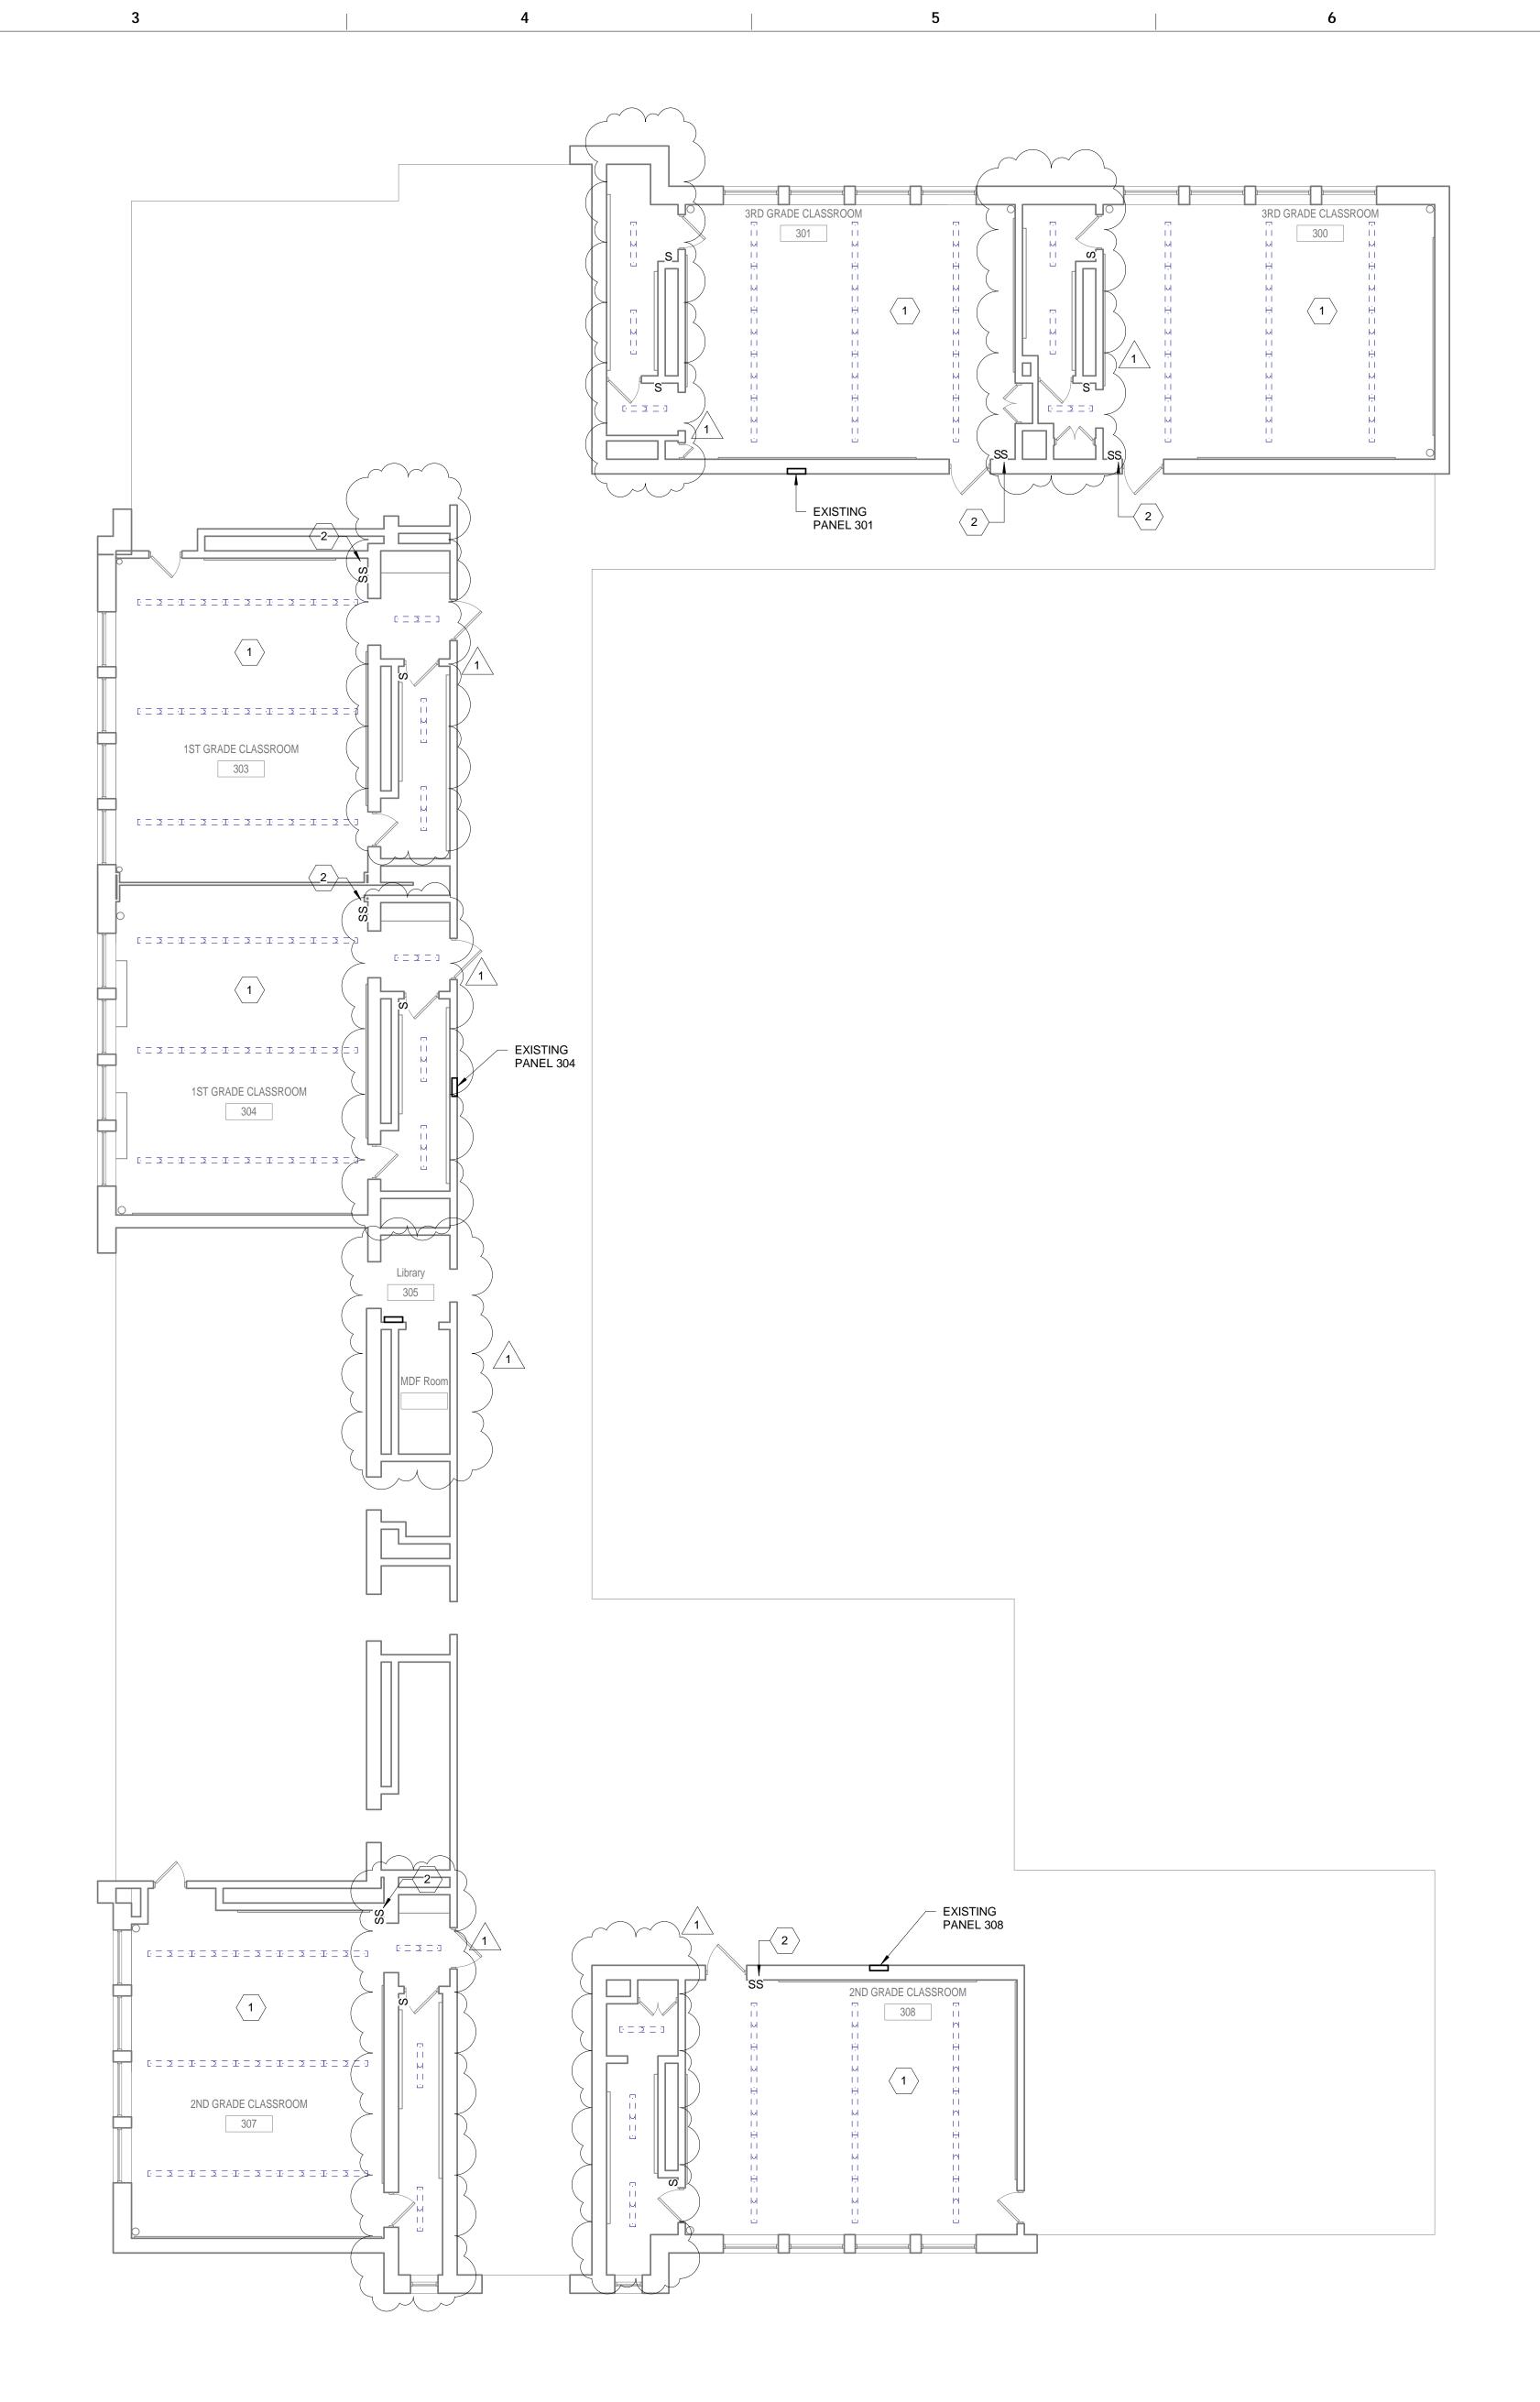

THIRD LEVEL - LIGHTING FLOOR PLAN - DEMOLITION - CLASSROOM A300 TO A308

GENERAL NOTES

REFER TO E001 FOR GENERAL NOTES, SYMBOL LEGEND AND LIST OF ABBREVIATIONS.

CONTRACTOR SHALL UPDATE EXISTING PANELBOARD DIRECTORY FOR ADDITIONAL NEW CIRCUIT.

THE SCHOOL DISTRICT OF PHILADELPHIA OFFICE OF CAPITAL PROGRAMS

440 NORTH BROAD STREET PHILADELPHIA, PA 19130 - 4015

(215) 400 - 4730 | (215) 400 - 4731 (fax)

SEAL:

www.philasd.org



KEYED NOTES

DISCONNECT AND REMOVE ALL EXISTING LIGHT FIXTURES FROM NOTED AREAS. EXISTING LIGHTING CIRCUIT TO REMAIN. DISCONNECT AND REMOVE ALL EXISTING LIGHT SWITCH WITH COVER PLATE, EXISTING CIRCUIT


TO REMAIN.

R. JEFFREY STRAUB, AIA PENNSYLVANIA

CRABTREE, ROHRBAUGH & ASSOCIATES -ARCHITECTS 401, EAST WINDING HILL ROAD MECHANICSBURG, PA 17055 717-458-0272 717-458-0047 www.cra-architects.com Attn: R. Jeffrey Straub

MEP ENGINEER

Global Engineering Solutions® 6700A ROCKLEDGE DR. SUITE 301 BETHESDA, MARYLAND 20817 (T) 301-216-2871 (F) 301-216-9671 www.THEGES.com Attn: Anil Giri

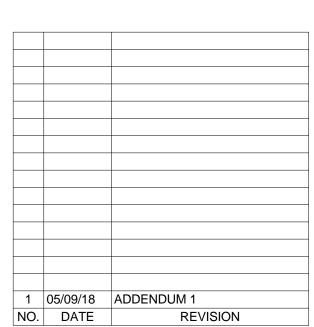

SCHOOL & LOCATION

JOHN H. TAGGART 400 W. PORTER STREET PHILADELPHIA, PA 19148


PROJECT TITLE **CLASSROOM**


MODERNIZATION


DRAWING TITLE

THIRD LEVEL - LIGHTING FLOOR PLAN - DEMOLITION

| LOCATION NO. | FILE | E NO. |
|------------------|----------|------------------------|
| DRAWN BY | СН | ECKED BY |
| B-047C B-050C | OF OF | 2017 / 18 2017 / 18 |

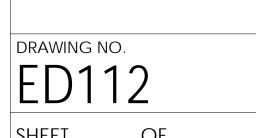

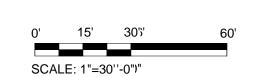

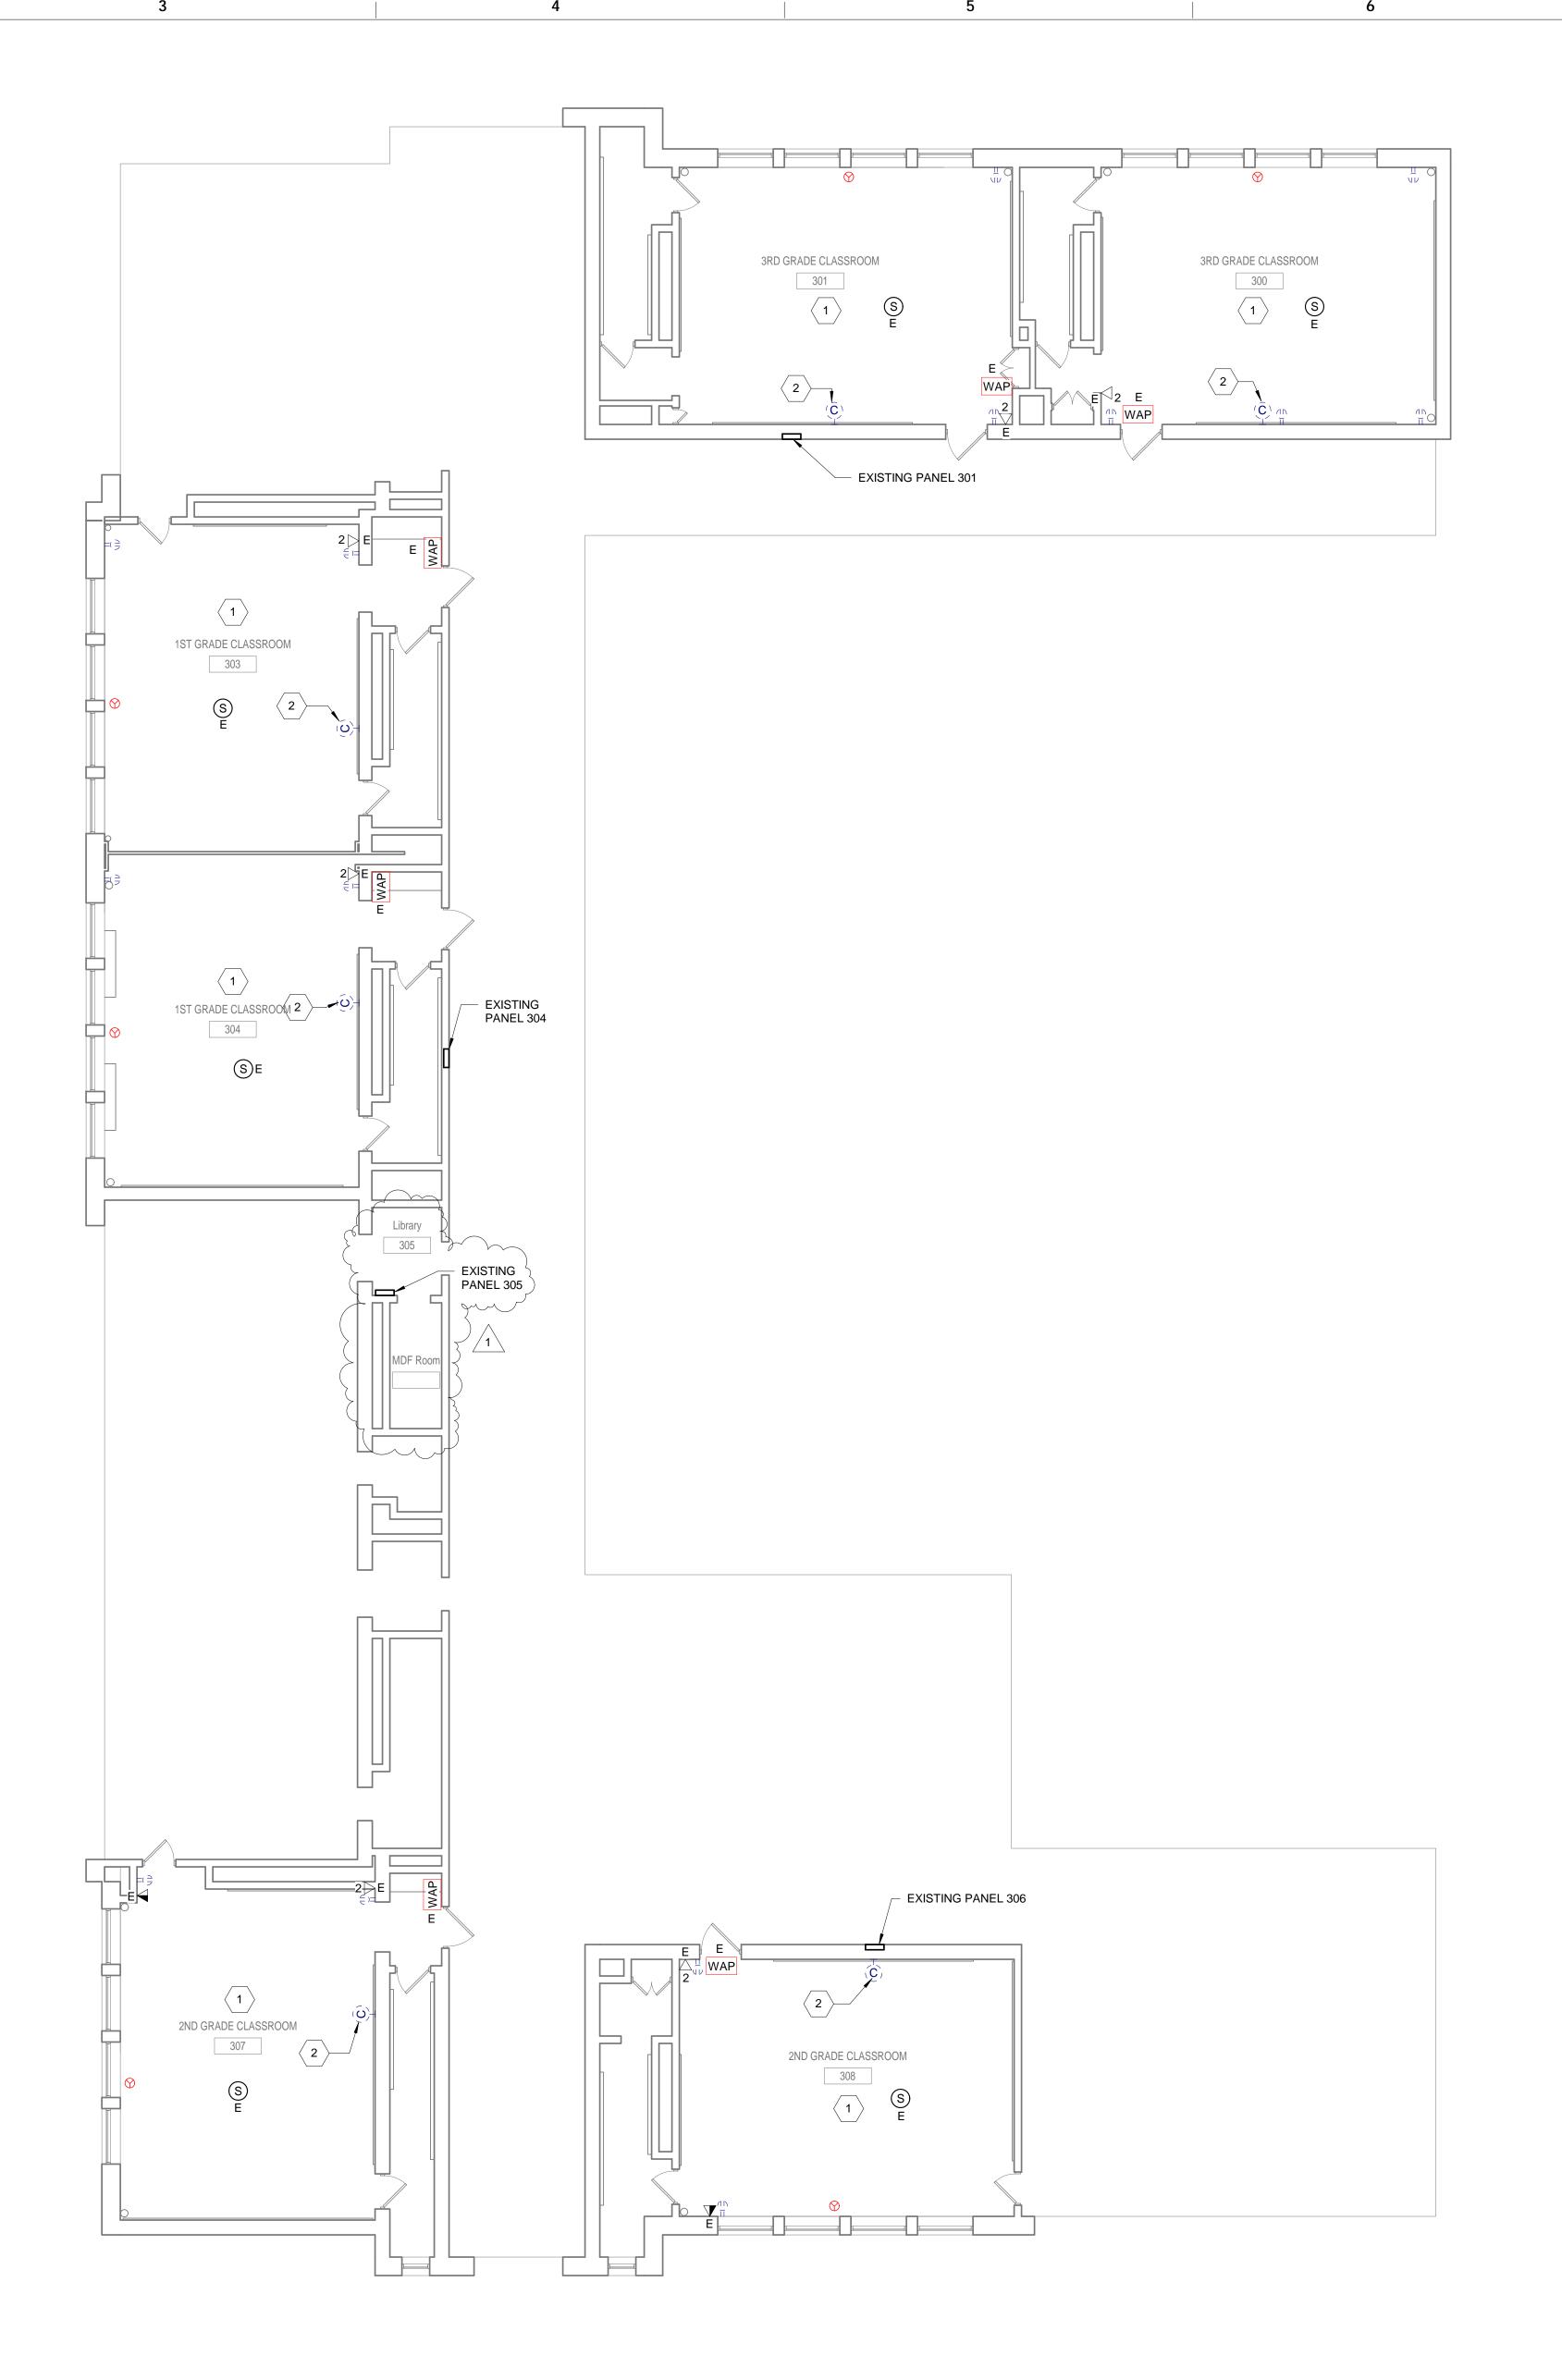

THIRD LEVEL - POWER FLOOR PLAN - DEMOLITION - CLASSROOM A300 TO A308

GENERAL NOTES

 REFER TO E001 FOR GENERAL NOTES, SYMBOL LEGEND AND LIST OF ABBREVIATIONS.

2. CONTRACTOR SHALL UPDATE EXISTING PANELBOARD DIRECTORY FOR ADDITIONAL NEW CIRCUIT.

PHILADELPHIA

OFFICE OF CAPITAL PROGRAMS

OFFICE OF CAPITAL PROGRAMS

440 NORTH BROAD STREET
PHILADELPHIA, PA 19130 - 4015
(215) 400 - 4730 | (215) 400 - 4731 (fax)

SEAL:

www.philasd.org



KEYED NOTES

1 DISCONNECT AND REMOVE ALL EXISTING
RECEPTACLES WITH COVER PLATE FROM
NOTED AREAS. EXISTING CIRCUIT TO REMAIN.
2 DISCONNECT AND REMOVE ALL EXISTING
SYNCHRONOUS CLOCKS. PATCH AND PAINT TO
MATCH EXISTING SURFACES.


ARCHITECT

R. JEFFREY STRAUB, AIA PENNSYLVANIA

CRABTREE, ROHRBAUGH & ASSOCIATES -ARCHITECTS 401, EAST WINDING HILL ROAD MECHANICSBURG, PA 17055 717-458-0272 717-458-0047 www.cra-architects.com Attn: R. Jeffrey Straub

MEP ENGINEER

Global Engineering Solutions®
6700A ROCKLEDGE DR. SUITE 301
BETHESDA, MARYLAND 20817
(T) 301-216-2871 (F) 301-216-9671
www.THEGES.com
Attn: Anil Giri

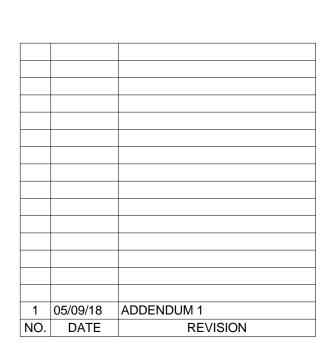

SCHOOL & LOCATION

JOHN H. TAGGART 400 W. PORTER STREET PHILADELPHIA, PA 19148

PROJECT TITLE

CLASSROOM


MODERNIZATION


DRAWING TITLE

THIRD LEVEL - POWER FLOOR PLAN - DEMOLITION

| DRAWN BY CHECKED BY B-047C OF 2017 / 18 B-050C OF 2017 / 18 | LOCATION NO. | FILE | E NO. |
|--|--------------|------|----------|
| | DRAWN BY | СН | ECKED BY |
| | | • | |

DRAWING NO.
ED122

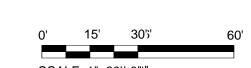

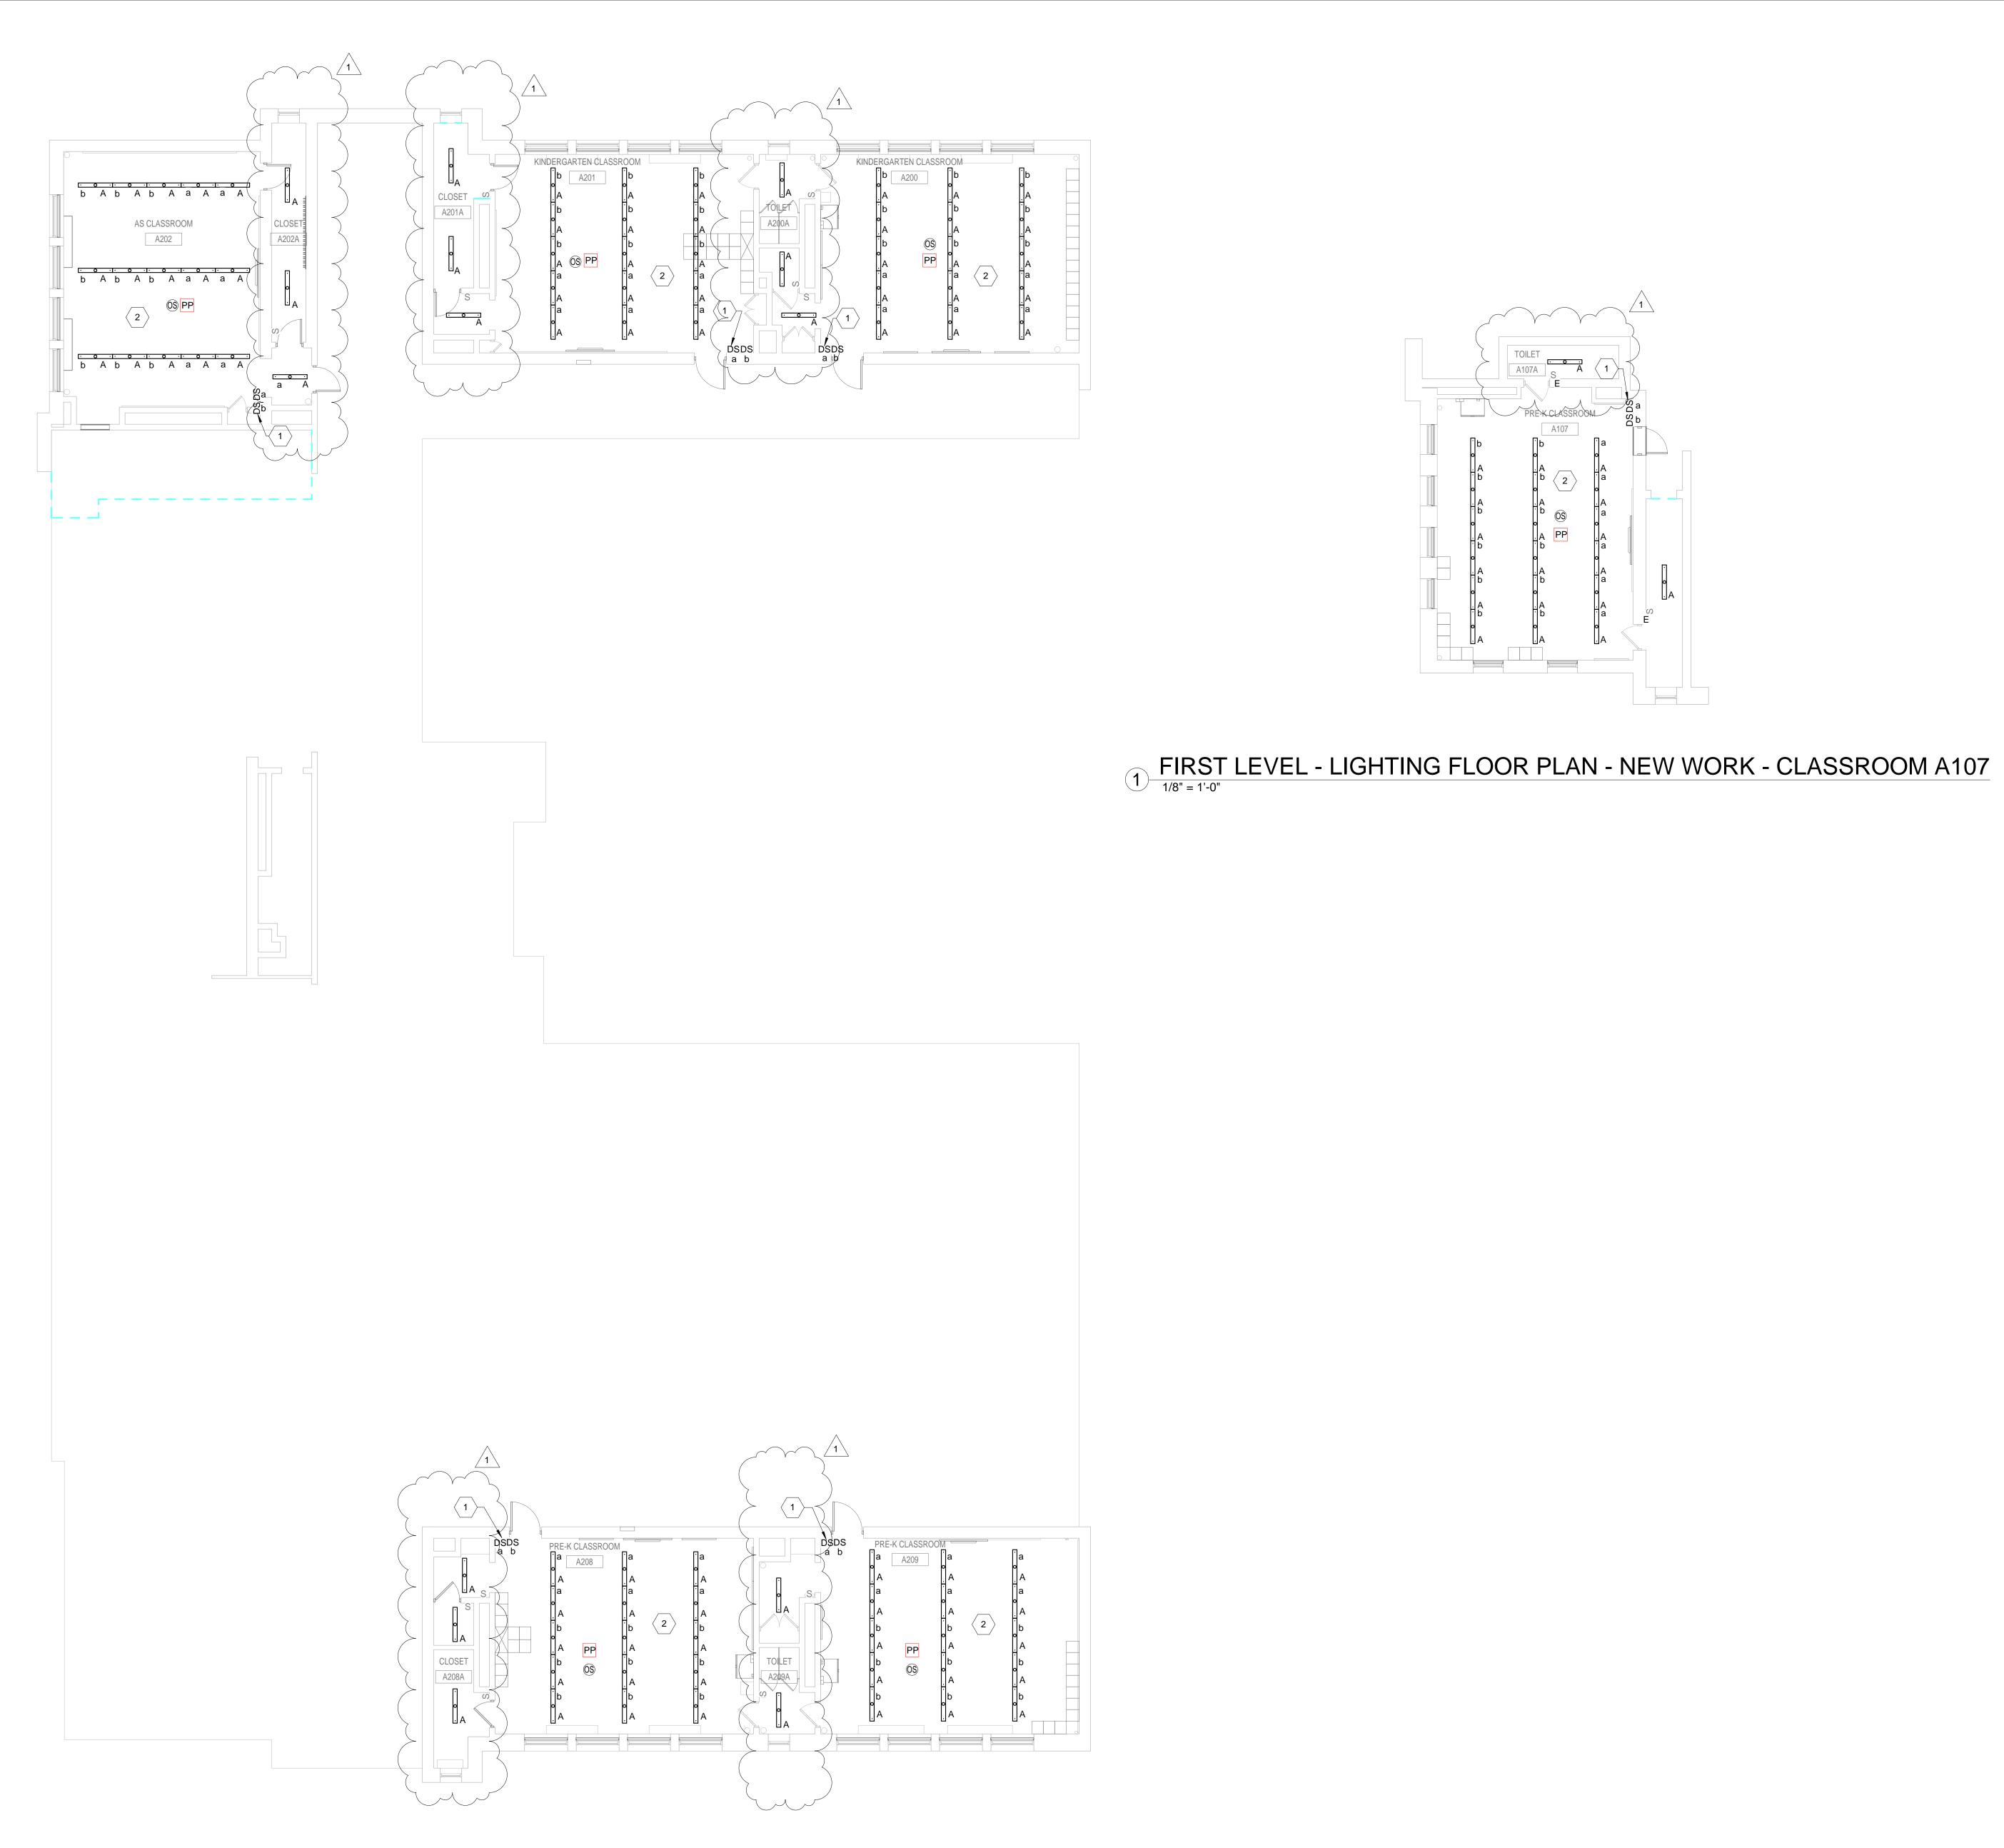

SECOND LEVEL - LIGHTING FLOOR PLAN - NEW WORK - CLASSROOMS A200 TO A203

1/8" = 1'-0"

GENERAL NOTES

NEW CIRCUIT.

REFER TO E001 FOR GENERAL NOTES, SYMBOL LEGEND AND LIST OF ABBREVIATIONS. CONTRACTOR SHALL UPDATE EXISTING

PANELBOARD DIRECTORY FOR ADDITIONAL

OFFICE OF CAPITAL PROGRAMS

440 NORTH BROAD STREET PHILADELPHIA, PA 19130 - 4015 (215) 400 - 4730 | (215) 400 - 4731 (fax)

THE SCHOOL DISTRICT OF PHILADELPHIA

SEAL:

www.philasd.org



***** KEYED NOTES

PROVIDE NEW DIMMER SWITCHES WITH COVER PLATE.COORDINATE EXACT REQUIREMENTS

SENSOR AS SHOWN.


WITH LIGHTING MANUFACTURER 2 CONTRACTOR SHALL VERIFY SOURCE OF EXISTING LIGHTING CIRCUIT PRIOR TO COMMENCING OF NEW LIGHTING INSTALLATION. REUSE EXISTING CIRCUIT IN THE AREA. PROVIDE NEW OCCUPANCY

R. JEFFREY STRAUB, AIA PENNSYLVANIA

CRABTREE, ROHRBAUGH & ASSOCIATES -ARCHITECTS 401, EAST WINDING HILL ROAD MECHANICSBURG, PA 17055 717-458-0272 717-458-0047 www.cra-architects.com Attn: R. Jeffrey Straub

MEP ENGINEER

Global Engineering Solutions® 6700A ROCKLEDGE DR. SUITE 301 BETHESDA, MARYLAND 20817 (T) 301-216-2871 (F) 301-216-9671 www.THEGES.com Attn: Anil Giri

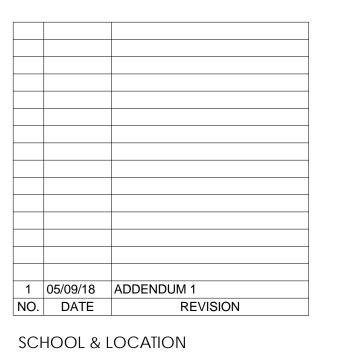

CLASSROOM **MODERNIZATION**

JOHN H. TAGGART 400 W. PORTER STREET PHILADELPHIA, PA 19148


DRAWING TITLE


DRAWING NO.

PROJECT TITLE

FIRST & SECOND LEVEL -LIGHTING FLOOR PLANS -**NEW WORK**

| LOCATION NO. | FILE NO. | |
|------------------|----------|------------------|
| DRAWN BY | CHECKED | BY |
| B-047C B-050C | | 7 / 18 7 / 18 |

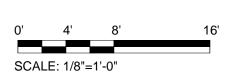

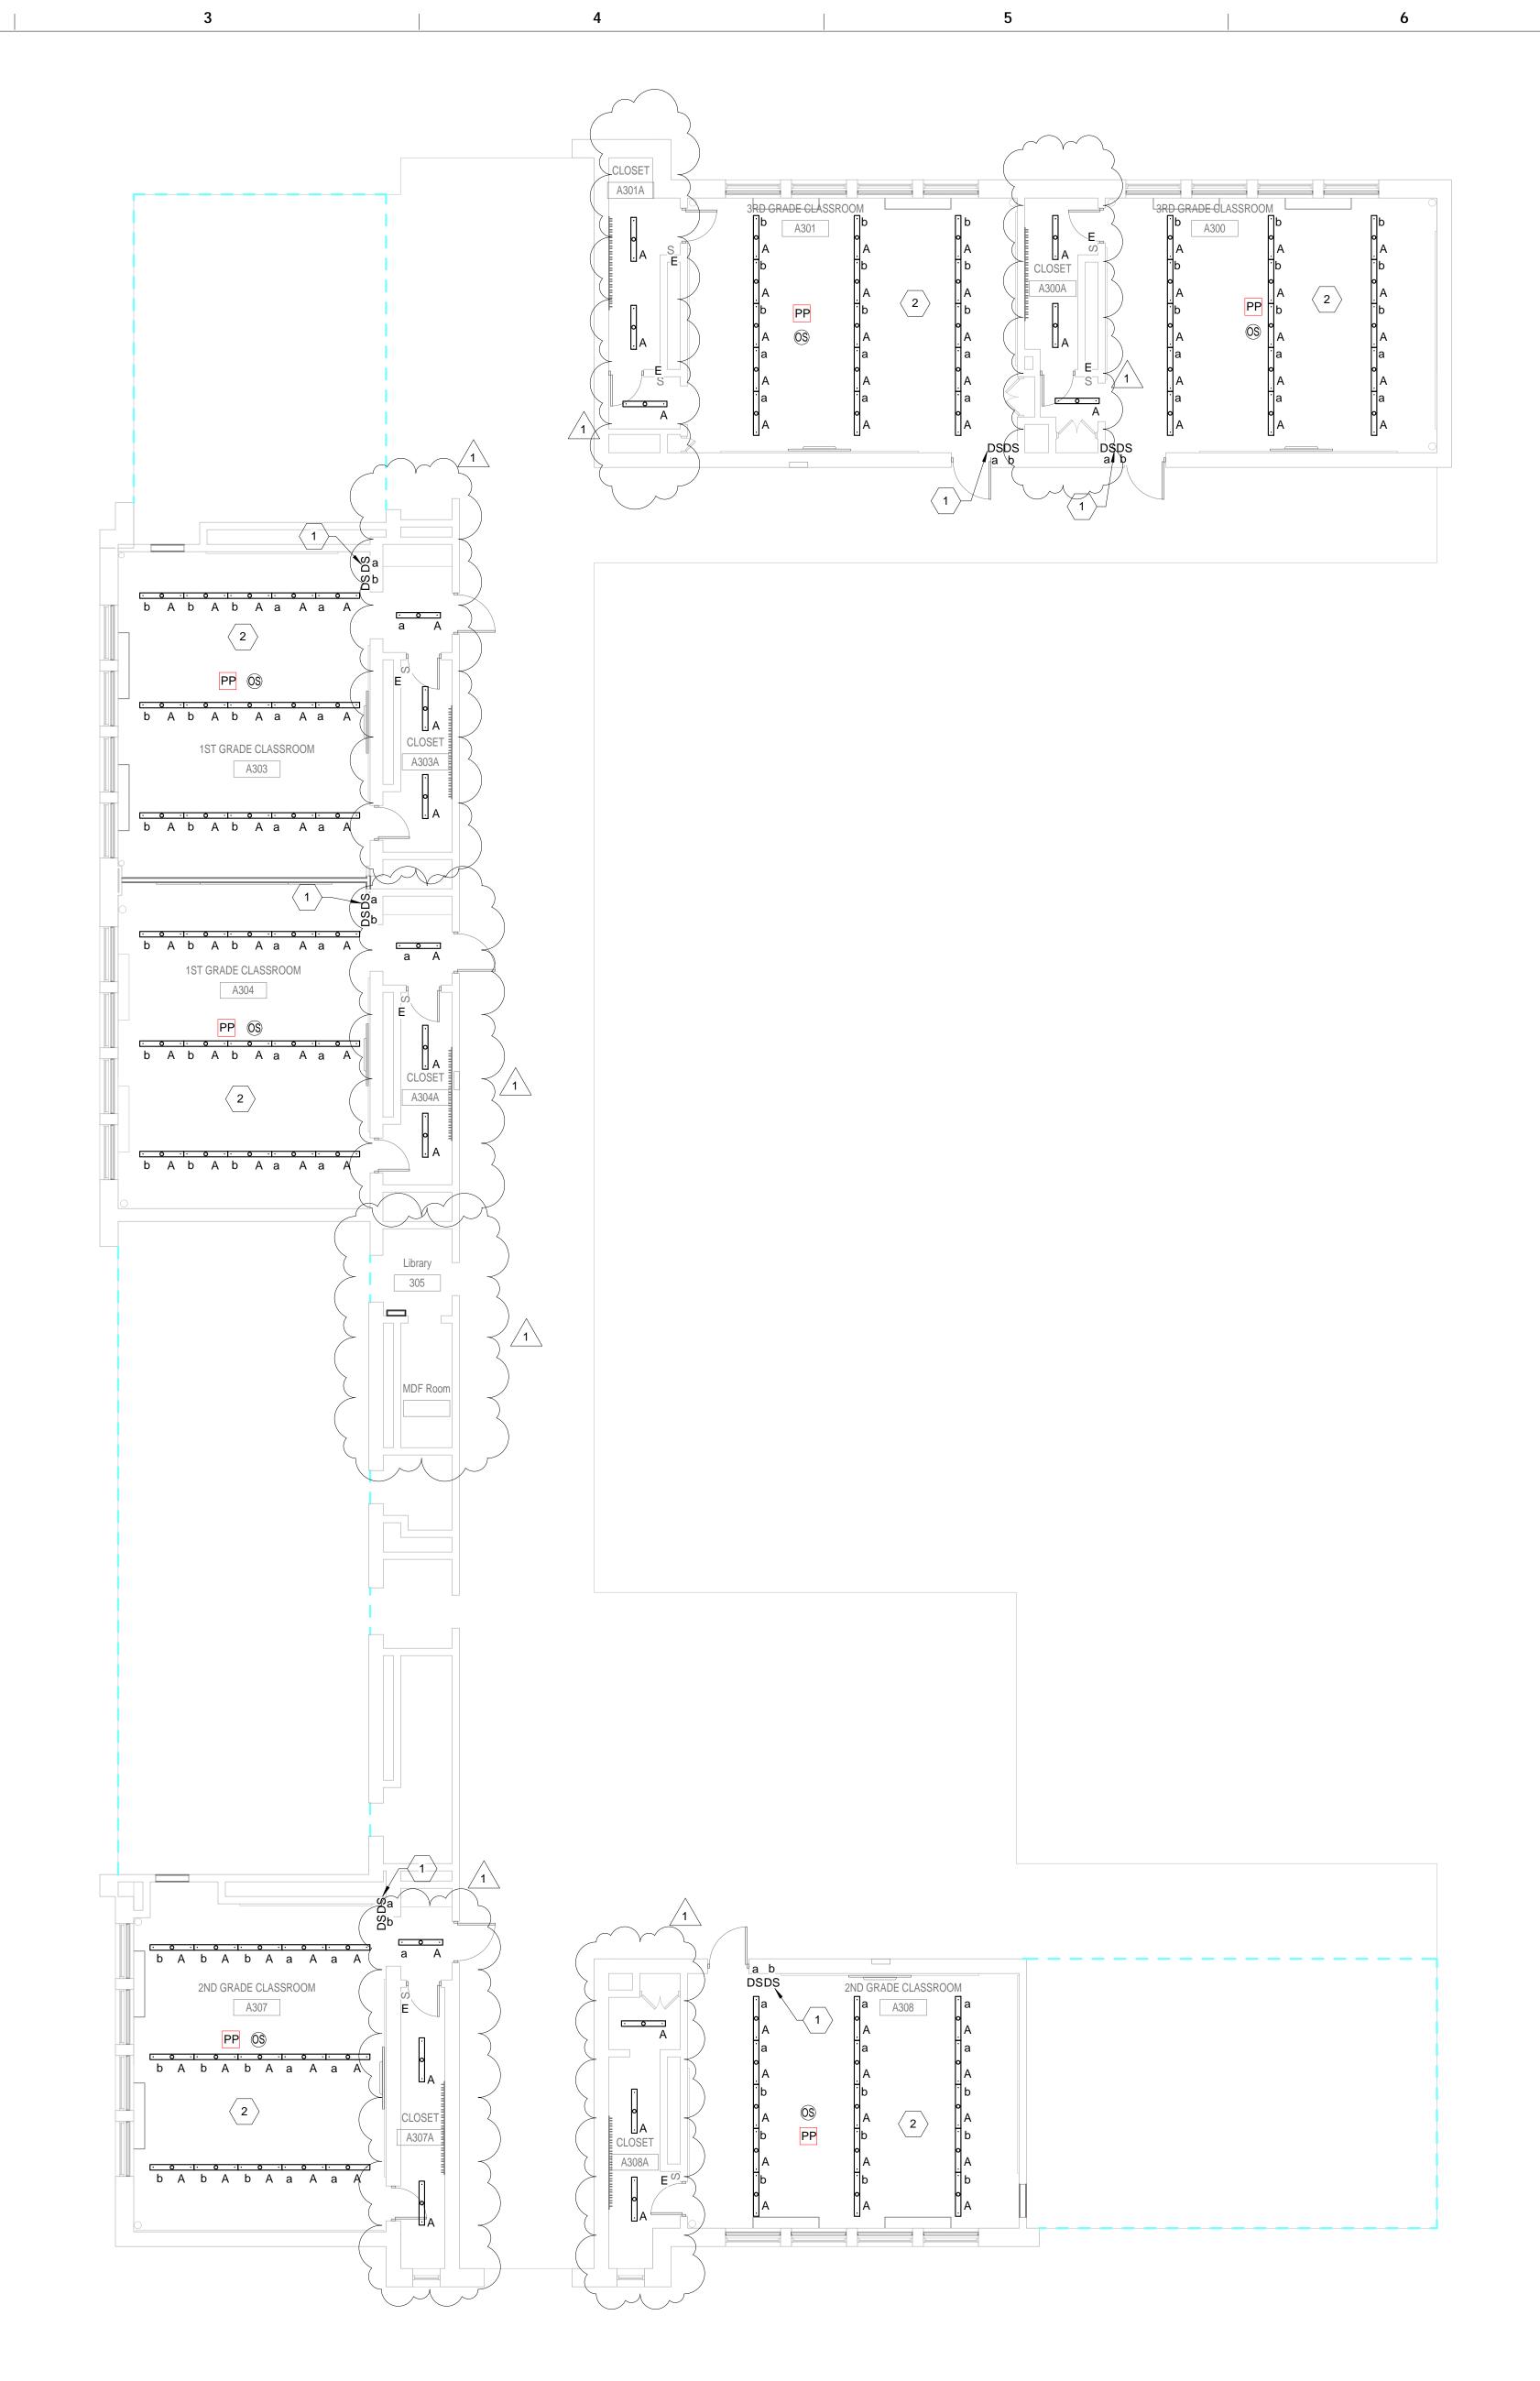

THIRD LEVEL - LIGHTING FLOOR PLAN - NEW WORK - CLASSROOMS A300 TO A308

GENERAL NOTES

1. REFER TO E001 FOR GENERAL NOTES, SYMBOL LEGEND AND LIST OF ABBREVIATIONS.

KEYED NOTES

MANUFACTURER

SENSOR AS SHOWN.

PROVIDE NEW DIMMER SWITCHES WITH COVER PLATE.COORDINATE EXACT REQUIREMENTS WITH LIGHTING

COMMENCING OF NEW LIGHTING INSTALLATION. REUSE EXISTING CIRCUIT IN

THE AREA. PROVIDE NEW OCCUPANCY

2 CONTRACTOR SHALL VERIFY SOURCE OF EXISTING LIGHTING CIRCUIT PRIOR TO

2. CONTRACTOR SHALL UPDATE EXISTING PANELBOARD DIRECTORY FOR ADDITIONAL NEW CIRCUIT.

PHILADELPHIA

OFFICE OF CAPITAL PROGRAMS

440 NORTH BROAD STREET PHILADELPHIA, PA 19130 - 4015 (215) 400 - 4730 | (215) 400 - 4731 (fax)

SEAL:

www.philasd.org




R. JEFFREY STRAUB, AIA PENNSYLVANIA

CRABTREE, ROHRBAUGH & ASSOCIATES -ARCHITECTS 401, EAST WINDING HILL ROAD MECHANICSBURG, PA 17055 717-458-0272 717-458-0047 www.cra-architects.com

MEP ENGINEER

Attn: R. Jeffrey Straub

Global Engineering Solutions®
6700A ROCKLEDGE DR. SUITE 301
BETHESDA, MARYLAND 20817
(T) 301-216-2871 (F) 301-216-9671
www.THEGES.com
Attn: Anil Giri

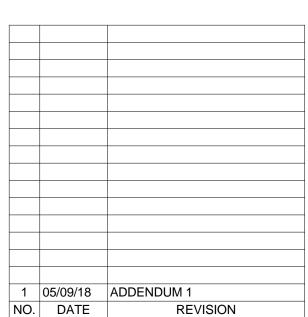

NO. DATE REVI

JOHN H. TAGGART 400 W. PORTER STREET PHILADELPHIA, PA 19148

PROJECT TITLE

CLASSROOM MODERNIZATION


DRAWING TITLE


THIRD LEVEL - LIGHTING FLOOR PLAN - NEW WORK

DRAWN BY

B-047C OF 2017 / 18
B-050C OF 2017 / 18

DRAWING NO.
E112

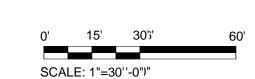

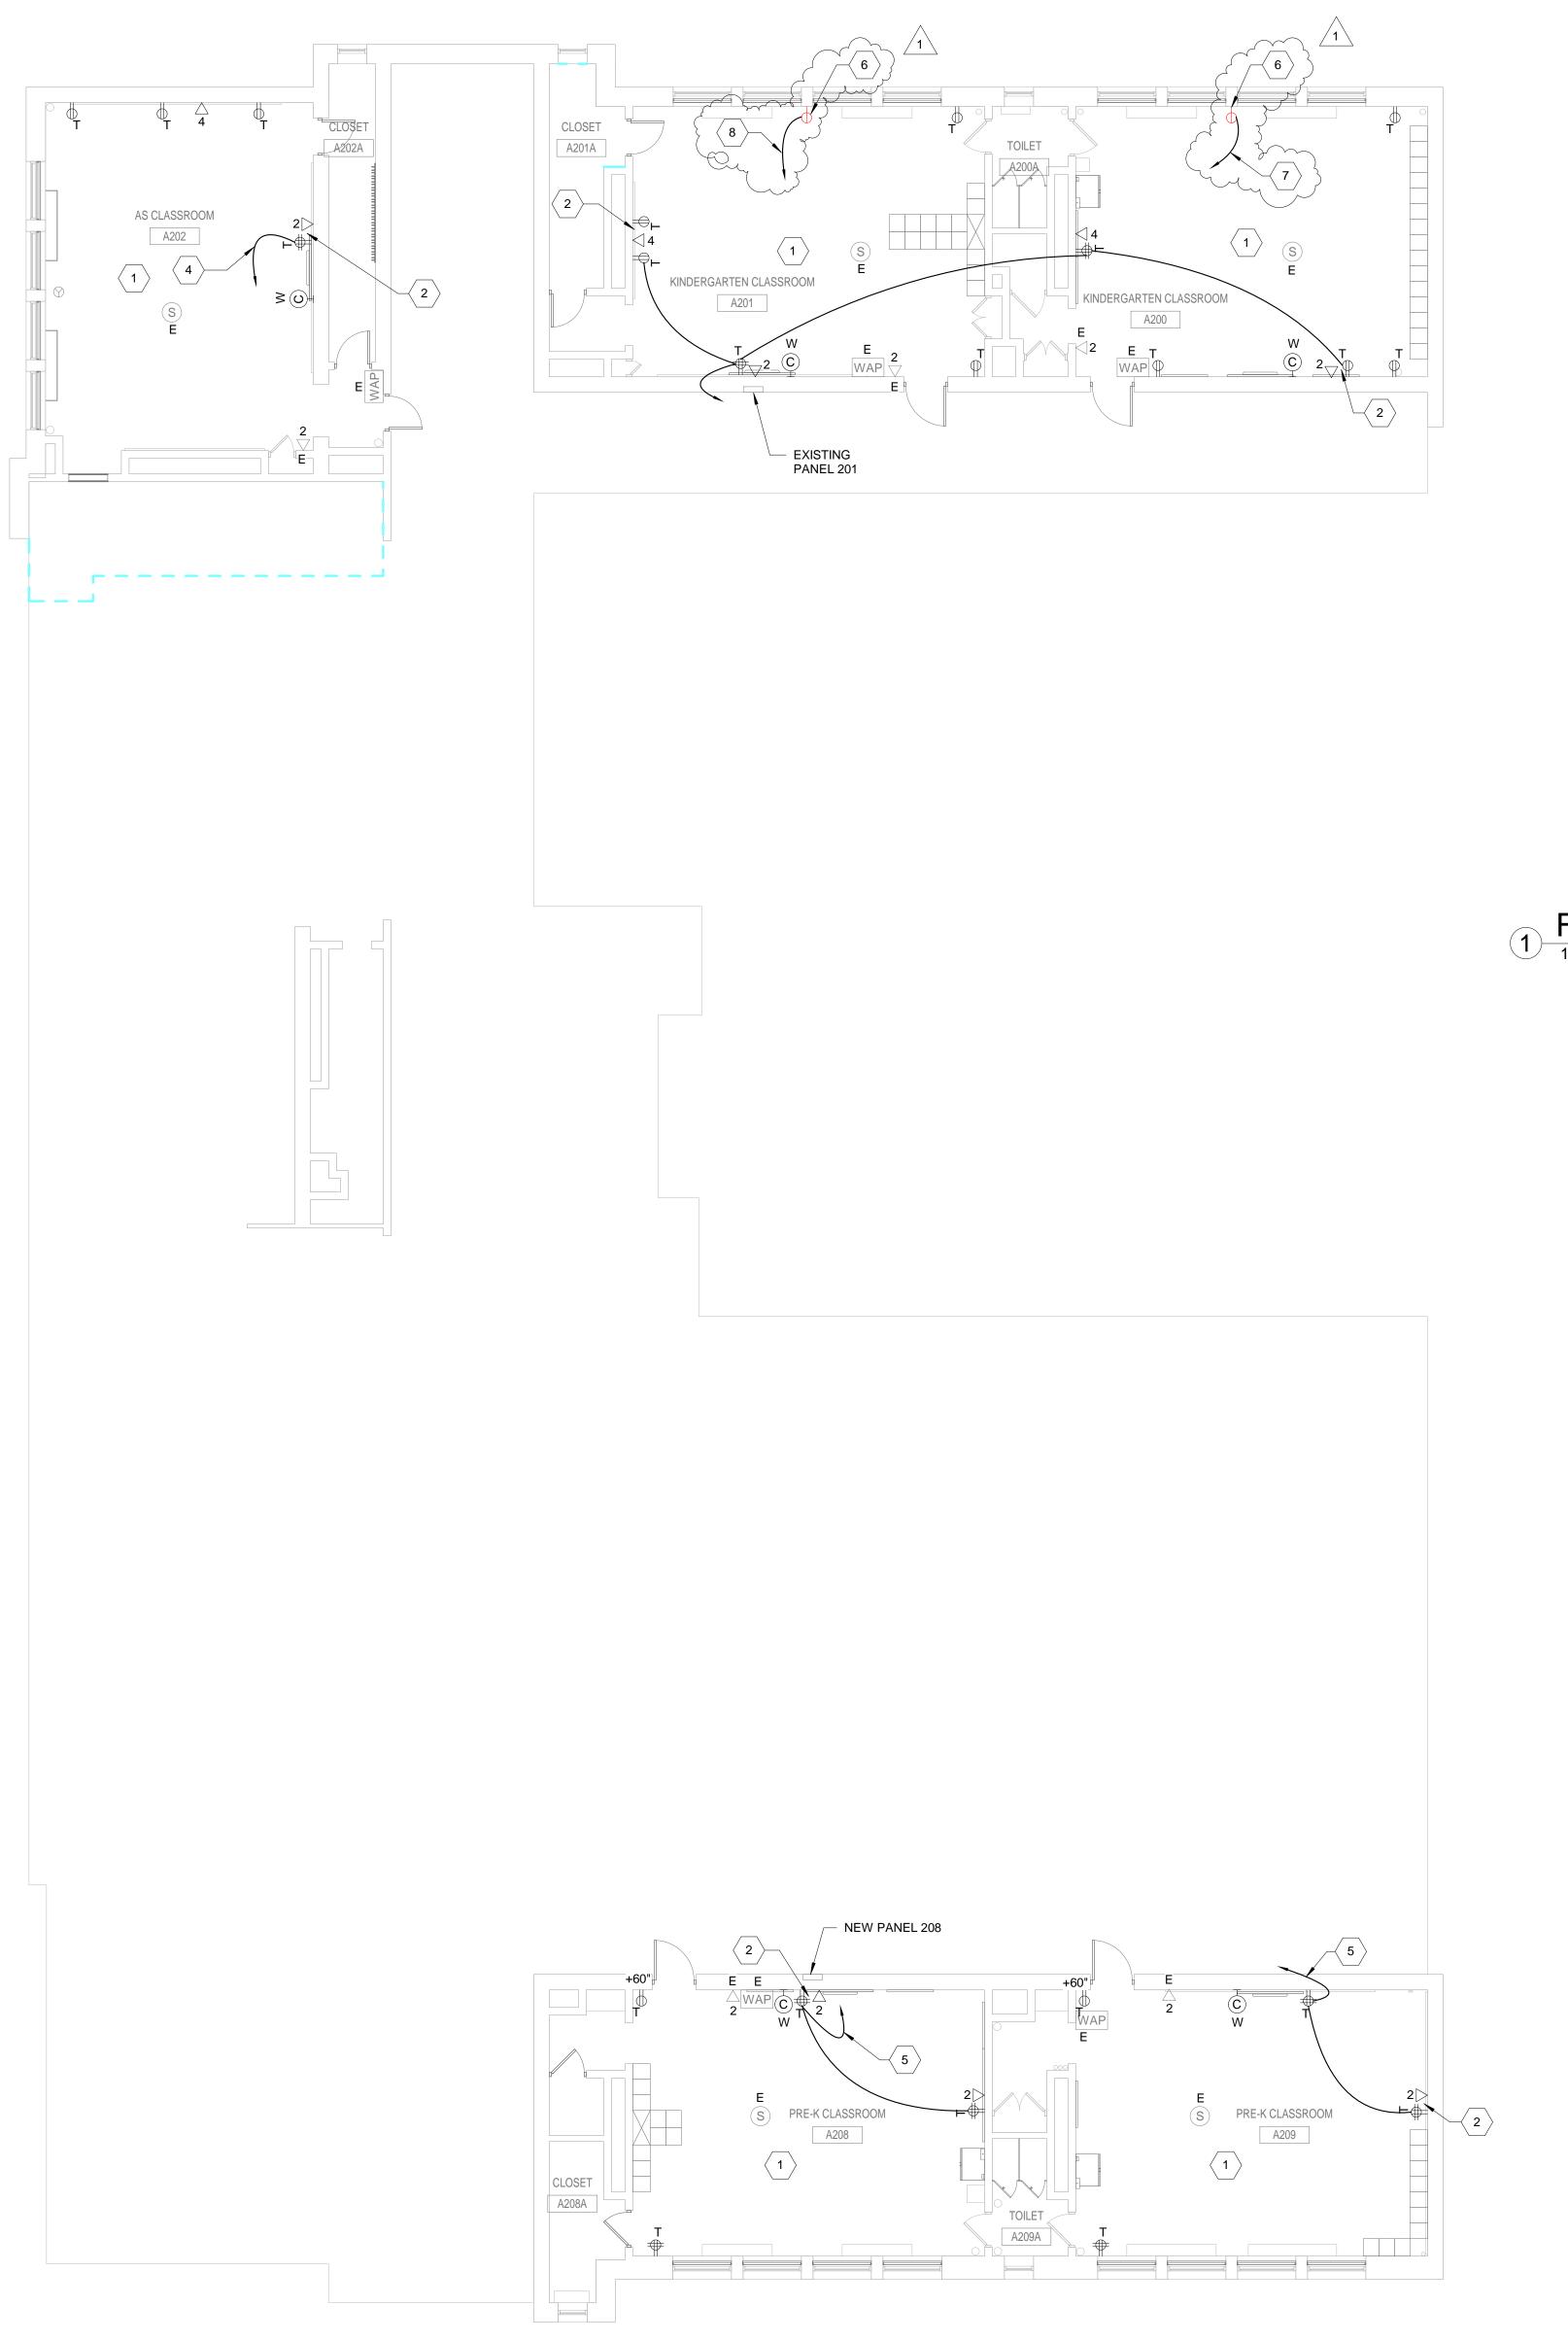


SECOND LEVEL - POWER FLOOR PLAN - NEW WORK - CLASSROOM A200 TO A203

1/8" = 1'-0"

MAXIMUM 20A BRANCH CIRCUIT LENGTH TO FARTHEST OUTLET, ONE WAY, O.U.N.

| AWG | | 120V, 1PH | | 277V, 1PH | | | | |
|-----|-----|-----------|------|-----------|------|---|--|--|
| #12 | 65' | - | - | 150' | - | - | | |
| #10 | - | 125' | - | - | 275' | - | | |
| #8 | - | - | 200' | - | - | - | | |

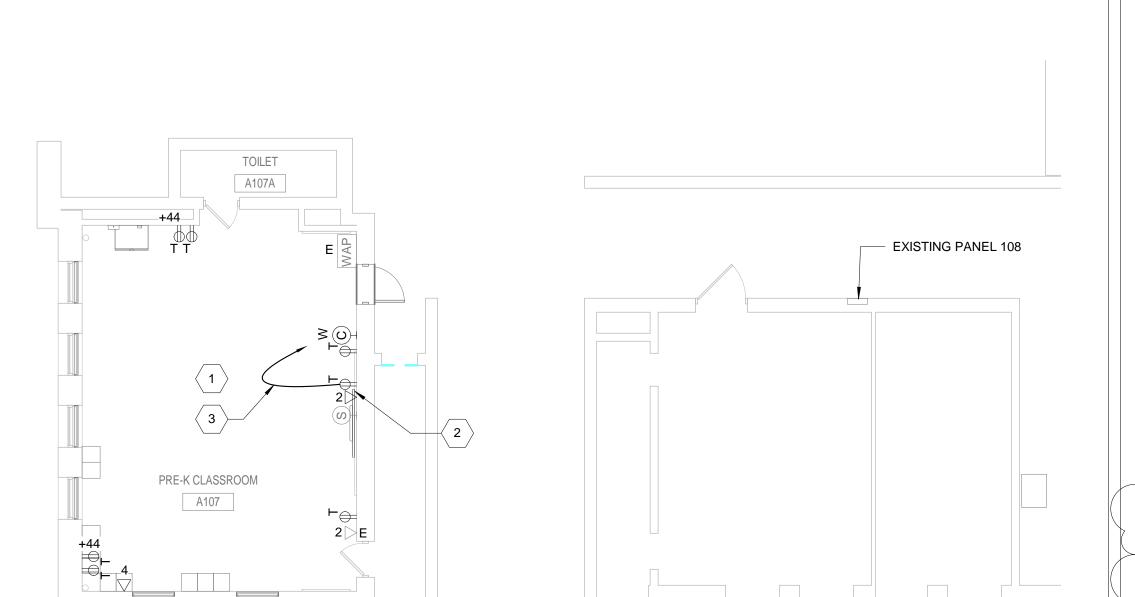

FIRST LEVEL - POWER FLOOR PLAN - NEW WORK - CLASSROOM A107

GENERAL NOTES

REFER TO E001 FOR GENERAL NOTES, SYMBOL LEGEND AND LIST OF ABBREVIATIONS.

CONTRACTOR SHALL UPDATE EXISTING PANELBOARD DIRECTORY FOR ADDITIONAL NEW CIRCUIT.

KEYED NOTES

PROVIDE NEW TAMPER RESISTANT RECEPTACLES WITH COVER PLATE, AND

RECONNECT TO EXISTING CIRCUIT IN NOTED

SURFACE MOUNT NEW RECEPTACLE, DATA

DATA OUTLET PRIOR TO INSTALLATION. CONNECT TO AN EXISTING 20A,1P SPARE CIRCUIT BREAKER IN PANEL 108.

5 CONNECT TO A 20A CIRCUIT BREAKER #37 AND

PROVIDE NEMA 6-20R RECEPTACLE FOR WINDOW AC UNIT. COORDINATE EXACT

RECEPTACLE WITH THE OWNER PRIOR TO

CONNECT TO PANEL 201, CIRCUITS 19, 21.

CONNECT TO PANEL 201, CIRCUITS 20, 22. 2#12+1#12 IN 3/4" C.

LOCATION AND MOUNTING HEIGHT OF

4 CONNECT TO AN EXISTING 20A,1P SPARE CIRCUIT BREAKER IN PANEL 201.

38 IN PANEL 208.

INSTALLATION.

2#12+1#12 IN 3/4" C.

OUTLET AND ASSOCIATED CONDUITS.
CONTRACTOR SHALL COORDINATE LOCATION

AND ITS FEASABILITY OF NEW RECEPTACLE AND

THE SCHOOL DISTRICT OF PHILADELPHIA OFFICE OF CAPITAL PROGRAMS

440 NORTH BROAD STREET PHILADELPHIA, PA 19130 - 4015

(215) 400 - 4730 | (215) 400 - 4731 (fax)

SEAL:

www.philasd.org



R. JEFFREY STRAUB, AIA PENNSYLVANIA

CRABTREE, ROHRBAUGH & ASSOCIATES -ARCHITECTS 401, EAST WINDING HILL ROAD MECHANICSBURG, PA 17055 717-458-0272 717-458-0047 www.cra-architects.com

MEP ENGINEER

Attn: R. Jeffrey Straub

Global Engineering Solutions® 6700A ROCKLEDGE DR. SUITE 301 BETHESDA, MARYLAND 20817 (T) 301-216-2871 (F) 301-216-9671 www.THEGES.com Attn: Anil Giri

1 05/09/18 ADDENDUM 1 NO. DATE REVISION

SCHOOL & LOCATION JOHN H. TAGGART

400 W. PORTER STREET PHILADELPHIA, PA 19148

PROJECT TITLE **CLASSROOM**

MODERNIZATION

DRAWING TITLE


SHEET

FIRST AND SECOND LEVEL -**POWER FLOOR PLANS -NEW WORK**

FILE NO. LOCATION NO. DRAWN BY CHECKED BY B-047C OF 2017 / 18 B-050C OF 2017 / 18 DRAWING NO.

OF

SCALE: 1"=30''-0")"

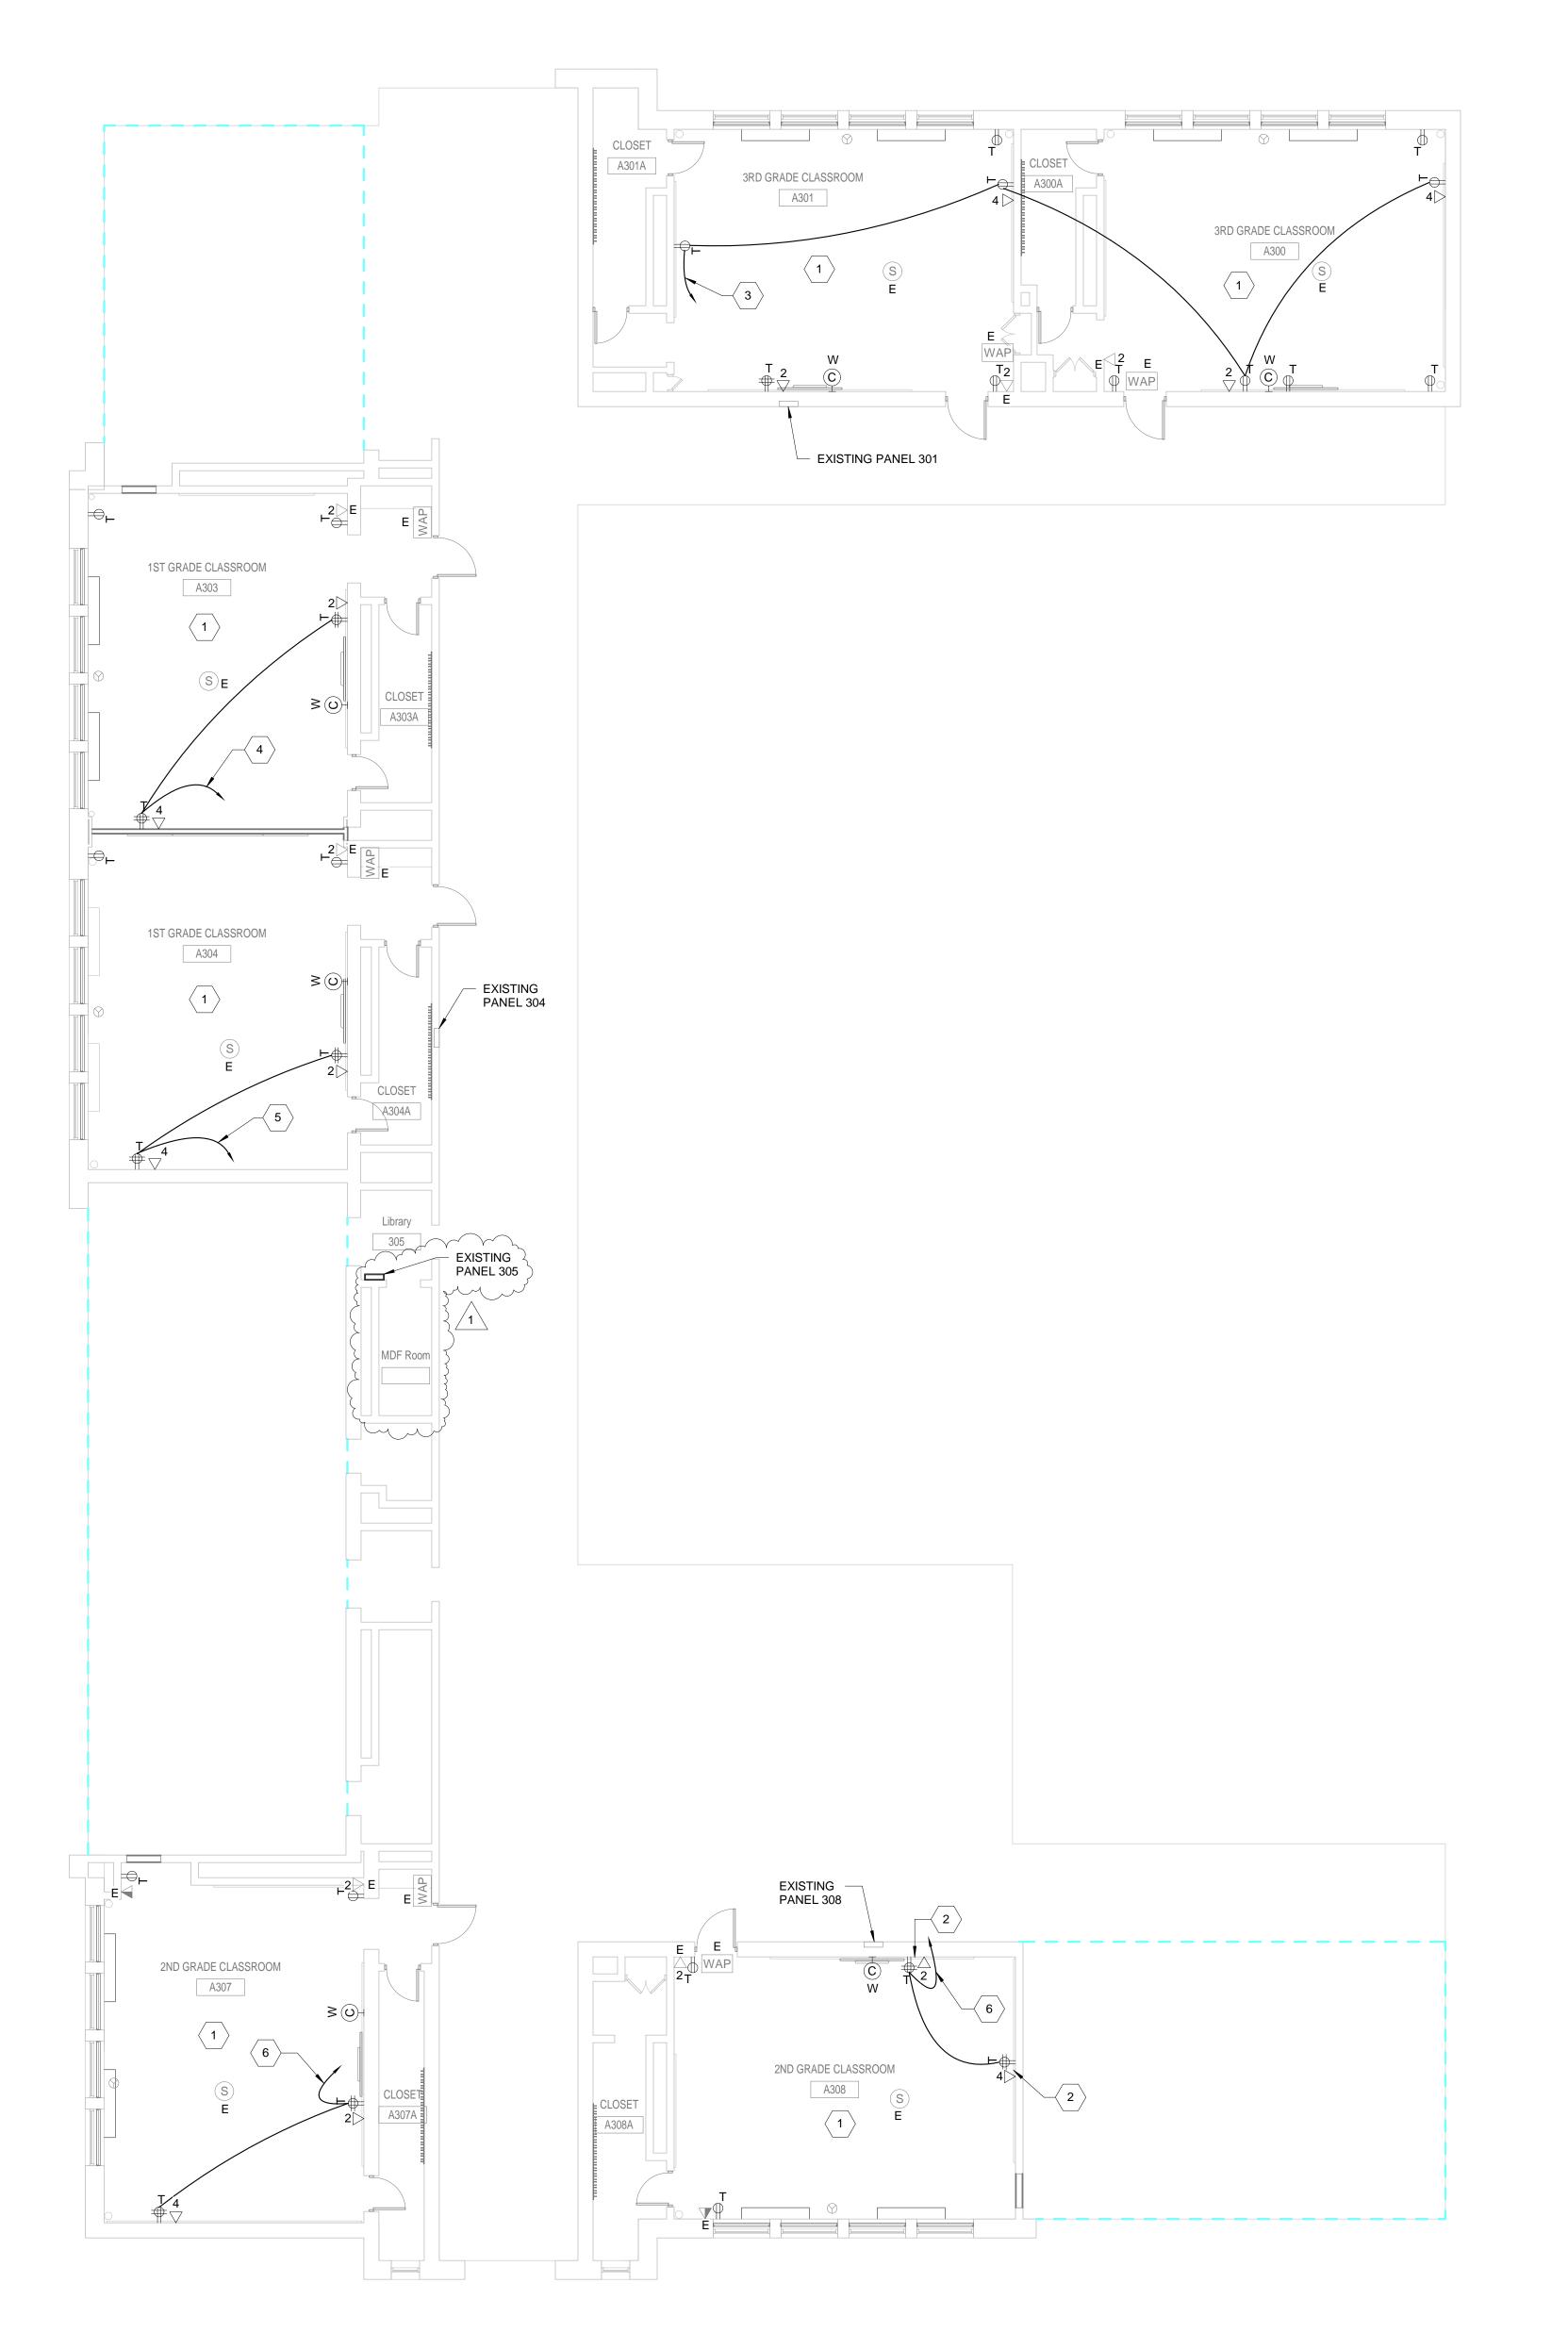

MAXIMUM 20A BRANCH CIRCUIT LENGTH TO FARTHEST OUTLET, ONE WAY, O.U.N.

| AWG | | 120V, 1PH | | | 277V, 1PH | |
|-----|-----|-----------|------|------|-----------|--|
| #12 | 65' | - | - | 150' | - | |
| #10 | - | 125' | - | - | 275' | |
| #8 | - | - | 200' | - | - | |

GENERAL NOTES

NEW CIRCUIT.

REFER TO E001 FOR GENERAL NOTES, SYMBOL LEGEND AND LIST OF ABBREVIATIONS.

440 NORTH BROAD STREET CONTRACTOR SHALL UPDATE EXISTING PHILADELPHIA, PA 19130 - 4015 PANELBOARD DIRECTORY FOR ADDITIONAL (215) 400 - 4730 | (215) 400 - 4731 (fax) www.philasd.org

SEAL:



THE SCHOOL DISTRICT OF PHILADELPHIA

OFFICE OF CAPITAL PROGRAMS

***** KEYED NOTES

- PROVIDE NEW TAMPER RESISTANT RECEPTACLES WITH COVER PLATE, AND RECONNECT TO EXISTING CIRCUIT IN NOTED
- 2 SURFACE MOUNT NEW RECEPTACLE, DATA OUTLET AND ASSOCIATED CONDUITS. CONTRACTOR SHALL COORDINATE LOCATION AND ITS FEASABILITY OF NEW RECEPTACLE AND DATA OUTLET PRIOR TO INSTALLATION.
- 3 CONNECT TO AN EXISTING 20A,1P SPARE CIRCUIT BREAKER IN PANEL 301.
- 4 CONNECT TO AN EXISTING 20A,1P SPARE
- CIRCUIT BREAKER IN PANEL 304. 5 CONNECT TO AN EXISTING 20A,1P SPARE CIRCUIT BREAKER IN PANEL 305.

6 CONNECT TO AN EXISTING 20A,1P SPARE

CIRCUIT BREAKER IN PANEL 308.

<u>ARCHITECT</u>

R. JEFFREY STRAUB, AIA PENNSYLVANIA

CRABTREE, ROHRBAUGH & ASSOCIATES -ARCHITECTS 401, EAST WINDING HILL ROAD MECHANICSBURG, PA 17055 717-458-0272 717-458-0047 www.cra-architects.com Attn: R. Jeffrey Straub

MEP ENGINEER

Global Engineering Solutions® 6700A ROCKLEDGE DR. SUITE 301 BETHESDA, MARYLAND 20817 (T) 301-216-2871 (F) 301-216-9671 www.THEGES.com Attn: Anil Giri

| 1 | 05/09/18 | ADDENDUM 1 |
|-----|----------|------------|
| NO. | DATE | REVISION |

SCHOOL & LOCATION

JOHN H. TAGGART 400 W. PORTER STREET PHILADELPHIA, PA 19148

PROJECT TITLE

CLASSROOM **MODERNIZATION**

DRAWING TITLE


SCALE: 1"=30''-0")"

THIRD LEVEL - POWER FLOOR PLAN - NEW WORK

| DRAWN BY | СН | FCKFD BY |
|----------|----|-----------|
| B-047C | OF | 2017 / 18 |
| B-050C | OF | |


DRAWING NO.


THIRD LEVEL - POWER FLOOR PLAN - NEW WORK - CLASSROOM A300 TO A308

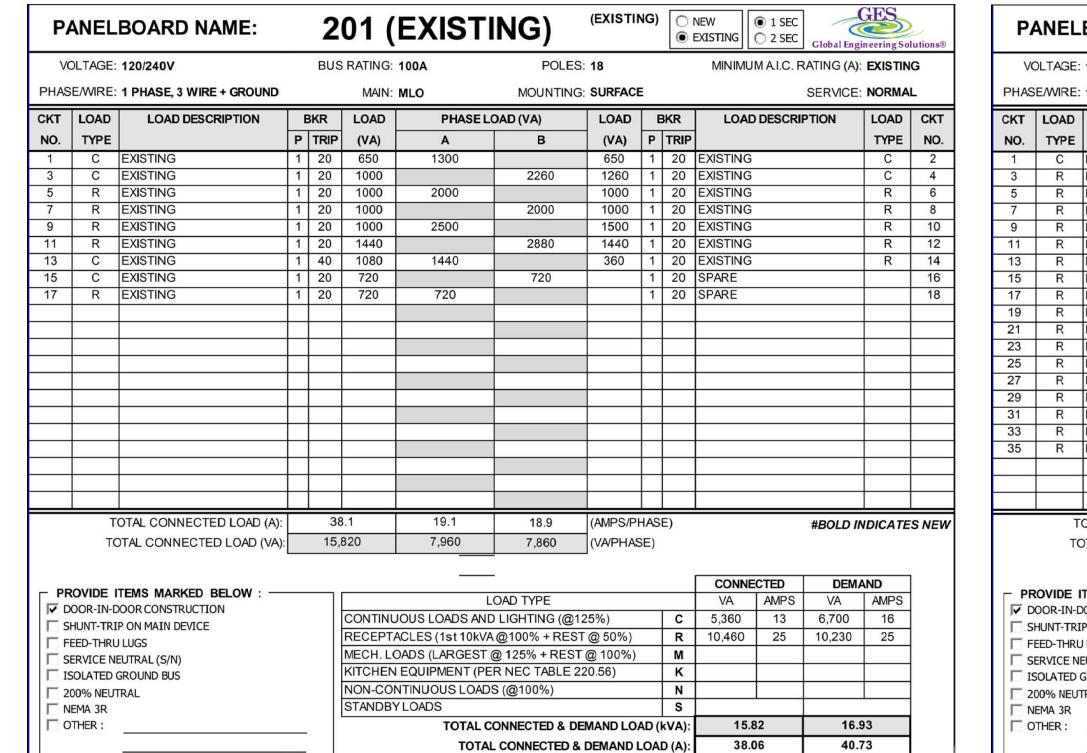

| P | ANEL | BOARD NAME: | | | | | | | | | | NEW | | | | | | | |
|---------------------------|----------|---------------------------|---|------|------------------|---|---------------|----------|------|----------|-------------------------------------|------------------|----------|----------|------|--|--|--|--|
| VC | DLTAGE: | 120/240V | | BUS | RATING: | 100A | POLES | : 36 | | | MINIMUM A.I.C. RATING (A): EXISTING | | | | | | | | |
| PHAS | EMIRE: | 1 PHASE, 3 WIRE + GROUND | | | MAIN: | MLO | MOUNTING | | | SERVICE: | E: NORMAL | | | | | | | | |
| СКТ | LOAD | LOAD DESCRIPTION | E | KR | LOAD | PHASE L | OAD (VA) | LOAD | ı | 3KR | LOAD | LOAD DESCRIPTION | | LOAD | СКТ | | | | |
| NO. | TYPE | | Р | TRIP | (VA) | Α | В | (VA) | Р | TRIP | | | | TYPE | NO | | | | |
| 1 | С | EXISTING | 1 | 20 | 650 | 1300 | | 650 | 1 | 20 | EXISTING | | | С | 2 | | | | |
| 3 | R | EXISTING | 1 | 20 | 1000 | | 2260 | 1260 | 1 | 20 | EXISTING | | | С | 4 | | | | |
| 5 | R | EXISTING | 1 | 20 | 1000 | 2000 | | 1000 | 1 | 20 | EXISTING | | | С | 6 | | | | |
| 7 | R | EXISTING | 1 | 20 | 1000 | 200 200 | 2000 | 1000 | 1 | 20 | EXISTING | | | С | 8 | | | | |
| 9 | R | EXISTING | 1 | 20 | 1000 | 2500 | | 1500 | 1 | 20 | EXISTING | | | С | 10 | | | | |
| 11 | R | EXISTING | 1 | 20 | 1440 | | 2880 | 1440 | 1 | 20 | EXISTING | | | С | 12 | | | | |
| 13 | R | EXISTING | 1 | 40 | 1080 | 1440 | | 360 | 1 | 20 | EXISTING | | | С | 14 | | | | |
| 15 | R | EXISTING | 1 | 20 | 720 | | 1800 | 1080 | 1 | 20 | EXISTING | | | С | 16 | | | | |
| 17 | R | EXISTING | 1 | 20 | 720 | 2220 | | 1500 | 1 | 20 | EXISTING | | | С | 18 | | | | |
| 19 | R | EXISTING | 1 | 20 | 1000 | | 2000 | 1000 | 1 | 20 | EXISTING | | | R | 20 | | | | |
| 21 | R | EXISTING | 1 | 20 | 720 | 1720 | | 1000 | 1 | 20 | EXISTING | | | R | 22 | | | | |
| 23 | R | EXISTING | 1 | 20 | 720 | | 1720 | 1000 | 1 | 20 | EXISTING | | | R | 24 | | | | |
| 25 | R | EXISTING | 1 | 20 | 360 | 1800 | | 1440 | 1 | 20 | EXISTING | | | R | 26 | | | | |
| 27 | R | EXISTING | 1 | 20 | 1080 | 360000000000000000000000000000000000000 | 2160 | 1080 | 1 | 20 | EXISTING | | | R | 28 | | | | |
| 29 | R | EXISTING | 1 | 20 | 1500 | 2220 | | 720 | 1 | 20 | EXISTING | | | R | 30 | | | | |
| 31 | R | EXISTING | 1 | 20 | 1080 | 1800 | | 720 | 1 | 20 | EXISTING | | | R | 32 | | | | |
| 33 | R | EXISTING | 1 | 20 | 720 | 1220 | | 500 | 1 | 20 | EXISTING | | | R | 34 | | | | |
| 35 | R | EXISTING | 1 | 20 | 720 | | 1220 | 500 | 1 | 20 | EXISTING | | | R | 36 | | | | |
| | | | | | | | | | | | | | | | | | | | |
| | Т | OTAL CONNECTED LOAD (A): | | 82 | 2.4 | 43.8 | 38.6 | (AMPS/PI | HAS | E) | | | #BOLD II | VDICATE | S NE | | | | |
| | | OTAL CONNECTED LOAD (VA): | | 34, | 260 | 18,220 | 16,040 | (VA/PHAS | | | | | "B02B " | 10/0/1/2 | 0112 | | | | |
| | | | | | | - | <u> </u> | | | | CONNE | CTED | DEMA | AND | 1 | | | | |
| - PR | ROVIDE | TEMS MARKED BELOW : - | | _ | | 1 | OAD TYPE | | | | VA | AMPS | VA | AMPS | | | | | |
| ₩ D | OOR-IN-D | DOOR CONSTRUCTION | | | CONTINI | | | 250/\ | | | | | | 31 | 1 | | | | |
| SHUNT-TRIP ON MAIN DEVICE | | | | | CONTRACTOR STATE | OUS LOADS AND | С | 10,440 | 25 | 13,050 | 100000 | - | | | | | | | |
| □F | EED-THRU | JLUGS | | - 11 | | ACLES (1st 10kV/ | R | 23,820 | 57 | 16,910 | 41 | - | | | | | | | |
| | | EUTRAL (S/N) | | | | DADS (LARGEST | | M | | | | | 1 | | | | | | |
| | SOLATED | GROUND BUS | | - 11 | | EQUIPMENT (PE | | K | | | | | | | | | | | |
| | 00% NEU | TRAL | | | | NTINUOUS LOAD | S (@100%) | | | N | | | | | 1 | | | | |
| | EMA 3R | | | | STANDBY | | | | | S | | | | V05 | | | | | |
| □ 0 | THER: | | | | | TOTAL C | ONNECTED & DE | MAND LO | AD (| kVA): | 34.2 | 26 | 29.9 | 96 | 1 | | | | |
| | | | | | | TOTA | L CONNECTED & | DEMAND | 04 | D /A\. | 82.4 | 12 | 72.0 | 17 | ľ. | | | | |

| PA | NELBOARD NAME: | | 10 | 201 | (NEW | /) | (NEW) | 0 | IEW | GES | | | PAN | ELBO | ARD NAME: | | 208 | B (NEV | V) | (NEW) | | NEW EXISTING | 1 SEC 2 SEC | Global Eng | GES neering S |
|--------------|-------------------------------|---------|------------|----------------|----------------|--|--------------|--------|---|--------------|-------------|------------|---------|------------------|----------------------------------|--------|---------|------------------------|--------------|--------------|------------------------------|-----------------|-------------|-------------|------------------|
| VOLT | AGE: 120/240V | | BUSF | RATING: 1 | 100A | POLE | S: 30 | | MINIMUM A.I.C. RATING | (A): EXISTIN | IG | 1 [| VOLTA | GE: 120/2 | 240V | BUS | RATING: | 100A | POLES | S: 36 | | MINIM | JM A.I.C. F | RATING (A): | EXISTI |
| HASE/V | MRE: 1 PHASE, 3 WIRE+ GROUND | | | MAIN: N | MLO | MOUNTIN | G: SURFACE | | SERVI | CE: NORMA | L | F | PHASE/W | RE: 1 PH | ASE, 3 WIRE + GROUND | | MAIN: I | MLO | MOUNTING | G: SURFAC | E | | | SERVICE: | NORM |
| (T L | DAD LOAD DESCRIPTION | ВК | R | LOAD | PHASE L | OAD (VA) | LOAD | BKR | LOAD DESCRIPTION | LOAD | СКТ | | скт LO | AD I | LOAD DESCRIPTION | BKR | LOAD | PHASELO | DAD (VA) | LOAD | BKR | LOA | D DESCRI | PTION | LOAD |
|). т | YPE | PT | RIP | (VA) | Α | В | (VA) P | TRIP | | TYPE | NO. | , | NO. TY | PE | | P TRIP | (VA) | Α | В | (VA) | P TRI | P | | | TYPE |
| \neg | C EXISTING | 1 : | 20 | 650 | 1300 | | 650 1 | 20 | EXISTING | С | 2 | 1 F | 1 (| EXIS | TING | 1 20 | 650 | 1300 | | 650 | | EXISTING | | | С |
| | C EXISTING | 1 : | 20 | 1000 | | 2260 | 1260 1 | 20 | EXISTING | С | 4 | 1 H | 3 1 | R EXIS | 1,170,000 | 1 20 | 1000 | 1.2.2.2. | 2260 | 1260 | | EXISTING | | | C |
| | R EXISTING | 1 : | 20 | 1000 | 2000 | | 1000 1 | 20 | EXISTING | R | 6 | ¬ ⊢ | 5 1 | R EXIS | | 1 20 | 1000 | 2000 | | 1000 | | EXISTING | | | С |
| | R EXISTING | 1 : | 20 | 1000 | | 2000 | 1000 1 | 20 | EXISTING | R | В | | 7 1 | R EXIS | | 1 20 | 1000 | 517476 (16.576) | 2000 | 1000 | 2 (52.625) | EXISTING | | | C |
| | R EXISTING | | 20 | 1000 | 2500 | | | | EXISTING | R | 10 | 」 ├─ | 9 1 | R EXIS | 0.0001000 | 1 20 | 1000 | 2500 | 773-200 (T) | 1500 | | EXISTING | | | C |
| - | R EXISTING | | 20 | 1440 | 2.0700 | 2880 | 3.050, 5550 | | EXISTING | R | 12 | ↓ ⊢ | 11 | R EXIS | | 1 20 | 1440 | | 2880 | 1440 | | EXISTING | | | С |
| +- | C EXISTING | | 40 | 1080 | 1440 | | 360 1 | 20.00 | EXISTING | R | 14 | _ | 13 I | R EXIS | | 1 40 | 1080 | 1440 | (2) (5) (5) | 360 | | EXISTING | | | C |
| - | C EXISTING | _ | 20 | 720 | 700 | 720 | 1 | | SPARE | | 16 | _ | 15 I | R EXIS | N. Marie Solid | 1 20 | 720 | Sec. Int. Col. Col. E. | 1800 | 1080 | | EXISTING | | | С |
| | R EXISTING | | 20 | 720 | 720 | 2010 | 1 1155 | | SPARE | 4 14 | 18 | | 17 I | REXIS | TING | 1 20 | 720 | 2220 | | 1500 | | EXISTING | | | С |
| + | M AC UNIT ROOM 200 SEE NOTE 1 | + + - | 20 | 1155 | 0040 | 2310 | | 20 | AC UNIT ROOM 201 SEE NOTE | 1 M | 20 | ↓ ⊢ | 19 I | R EXIS | TING | 1 20 | 1000 | | 2000 | 1000 | | EXISTING | | | R |
| + | SPARE | | | 1155 | 2310 | | 1155 | 20 | SPARE | | 22 | - I | 21 | REXIS | TING | 1 20 | 720 | 1720 | 2000 303000 | 1000 | 1 20 | EXISTING | 3 | | R |
| + | SPARE | | 20 | _ | | | 1 | | SPARE | | 24 26 | - I | 23 | REXIS | TING | 1 20 | 720 | | 1720 | 1000 | | EXISTING | | | R |
| + | SPARE | | 20 | | | | 1 | 28.00 | SPARE | - | 28 | | 25 I | REXIS | TING | 1 20 | 360 | 1800 | | 1440 | | EXISTING | | | R |
| + | SPARE | | 20 | _ | | | 1 | _ | SPARE | | 30 | ⊣ ⊢ | 27 | R EXIS | TING | 1 20 | 1080 | UA NO BROSS | 2160 | 1080 | 1 20 | EXISTING | 3 | | R |
| + | OF AILE | + ' + ' | - | _ | | | <u> </u> | 20 | OF AILE | - | 30 | 1 F | 29 | R EXIS | TING | 1 20 | 1500 | 2220 | | 720 | | EXISTING | | | R |
| + | | | _ | | | | | | | _ | | ┥┝ | 31 | R EXIS | TING | 1 20 | 1080 | 1800 | | 720 | 1 20 | EXISTING | 3 | | R |
| + | | + - | - | | | | | 1 | | _ | | ┥┝ | 33 I | R EXIS | TING | 1 20 | 720 | 1220 | | 500 | 1 20 | EXISTING | 3 | | R |
| + | | 1 | _ | | | | | | | | | 1 | 35 I | R EXIS | TING | 1 20 | 720 | | 1220 | 500 | 1 20 | EXISTING | } | | R |
| † | | | | | | | | | | | | 1 | 37 I | ROO | M A208 RECEPTACLES | 1 20 | 540 | 1080 | | 540 | 1 20 | ROOM 20 | 9 RECEP | TACLES | R |
| | | | | | | | | | | | | 1 | 39 | SPAC | DE . | | | | | | | SPACE | | | |
| _ | TOTAL CONNECTED LOAD (A) | | 49.2 | | 24.7 | 24.5 | (AMPS/PHAS | SE) | #BOL | D INDICATE | SNE | 7 🗀 | 41 | SPAC | E | | | | | | | SPACE | | | 4 |
| | TOTAL CONNECTED LOAD (VA) | | 20,440 | | 10,270 | 10,170 | (VA/PHASE) | | W DOL | o madion i | | | | TOTAL | CONNECTED LOAD (A): | 85 | .0 | 46.4 | 38.6 | (AMPS/F | HASE) | | | #BOLD II | IDICAT |
| | | | | | | | | | | | | | | TOTAL C | CONNECTED LOAD (VA): | 35,3 | 340 | 19,300 | 16,040 | (VA/PHA | SE) | | | | |
| ROV | IDE ITEMS MARKED BELOW : | | | | | | | | | AND |] | 1 1 | | | | | | | 3 | _ | | | | | |
| | R-IN-DOOR CONSTRUCTION | | | | | OAD TYPE | | | VA AMPS VA | AMPS | | | DDOVII | OF ITEMS | MARKED RELOW. | | | 25 | R | | | CONN | ECTED | DEMA | AND |
| SHUN | IT-TRIP ON MAIN DEVICE | | | | OUS LOADS AN | | | С | 5,360 13 6,700 | 16 | | | | | MARKED BELOW : — CONSTRUCTION | | | L | OAD TYPE | | 77) | VA | AMPS | VA | AMPS |
| FEED | -THRU LUGS | | 1 H | | CLES (1st 10kV | | | R | 10,460 25 10,230 | 25 | | | | | AIN DEVICE | | CONTINU | OUS LOADS AND | LIGHTING (@ | 125%) | С | 10,440 | 25 | 13,050 | 31 |
| SERV | ICE NEUTRAL (S/N) | | | | ADS (LARGEST | | | M | 4,620 11 5,198 | 13 | | | | THRU LUGS | | 11 | RECEPTA | CLES (1st 10kVA | @100% + RES | ST @ 50%) | R | 24,900 | 60 | 17,450 | 42 |
| ISOL | ATED GROUND BUS | | 1 - | Manual Company | EQUIPMENT (PE | The state of the s | 220.56) | K | | | | | | E NEUTRAI | | 1 1 | | ADS (LARGEST @ | | | | _ | | | |
| | 6 NEUTRAL | | | | ITINUOUS LOAD | S (@100%) | | N | | | | | | TED GROUN | | 1 1 | | EQUIPMENT (PE | | | К | _ | | | |
| | A 3R | | | STANDBY | | | | S | | | | | ☐ 200% | | | 1 1 | | TINUOUS LOADS | | | N | | | | |
| OTHE | | | | | | CONNECTED & D | | | 100000000000000000000000000000000000000 | .13 | | | ☐ NEMA | | | 1 1 | STANDBY | | | | s | | ' | | |
| | CIRCUIT INTERRUPTER (AFCI) B | REAKER | | | TOTA | L CONNECTED 8 | & DEMAND LOA | D (A): | 49.17 53 | .23 | l | | OTHER | | | | | | ONNECTED & D | EMANDLO | AD (kVA) |): 35. | .34 | 30. | 50 |
| | | | -7.5 | | | | | | | | et et | 1 1 | | 1966 P | | | | | CONNECTED 8 | | an designation of the second | | ili ii | 73.3 | F100 |

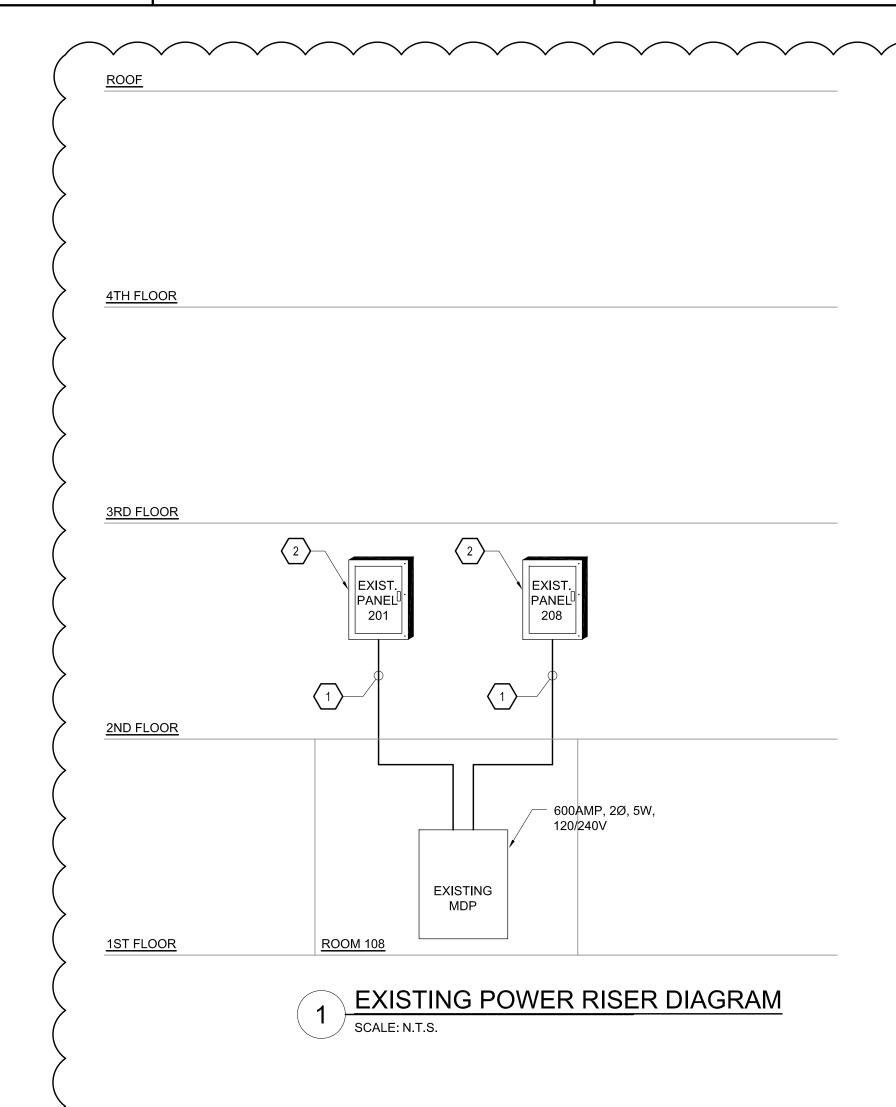

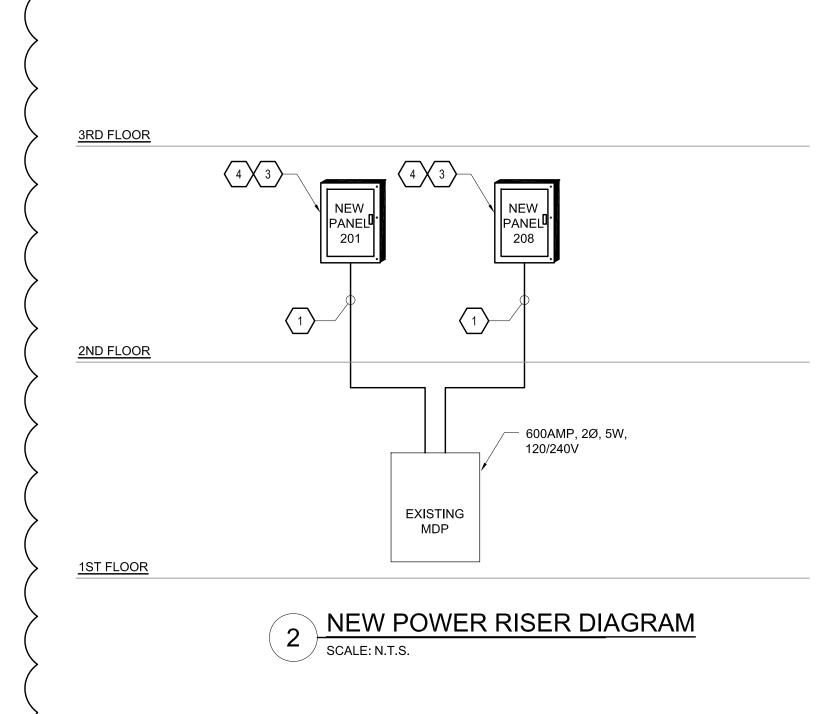

PHILADELPHIA

OFFICE OF CAPITAL PROGRAMS

440 NORTH BROAD STREET
PHILADELPHIA, PA 19130 - 4015
(215) 400 - 4730 | (215) 400 - 4731 (fax)
www.philasd.org

SEAL:

GENERAL NOTES

SEE DRAWING E001 FOR ELECTRICAL SYMBOLS, GENERAL

SPECIFIC NOTES

DISCONNECT AND REMOVE EXISTING PANEL, EXISTING MAIN FEEDER AND BRANCH CIRCUITS TO REMAIN.

PROVIDE NEW PANEL IN PLACE OF EXISTING PANEL, SEE

NEW PANEL SCHEDULE ON THIS DRAWING, RECONNECT

EXISTING MAIN FEEDER AND BRANCH CIRCUITS TO NEW

EXISTING MAIN FEEDER TO REMAIN AND REUSED. CONTRACTOR SHALL VERIFY EXISTING MAIN FEEDER

SOURCE PRIOR TO COMMENCING ANY WORK.

4. PROVIDE NEW PANEL DIRECTORY.

NOTES AND ABBREVIATIONS.



R. JEFFREY STRAUB, AIA DATE PENNSYLVANIA 03/29/2018

ARCHITECT

CRABTREE, ROHRBAUGH & ASSOCIATES -ARCHITECTS 401, EAST WINDING HILL ROAD MECHANICSBURG, PA 17055 717-458-0272 717-458-0047 www.cra-architects.com

MEP ENGINEER

GE

Attn: R. Jeffrey Straub

Global Engineering Solutions®
6700A ROCKLEDGE DR. SUITE 301
BETHESDA, MARYLAND 20817
(T) 301-216-2871 (F) 301-216-9671
www.THEGES.com
Attn: Anil Giri

| 10 | | |
|-----|----------|------------|
| 9 | | |
| 8 | | |
| 7 | | |
| 6 | | |
| 5 | | |
| 4 | | |
| 3 | | |
| 2 | | |
| 1 | 05/09/18 | ADDENDUM 1 |
| NO. | DATE | REVISION |

SCHOOL & LOCATION

JOHN H. TAGGART

400W. PORTER STEET,

PHILADELPHIA, PA 19148

PROJECT TITLE

CLASSROOM MODERNIZATION

ELECTRICAL PANELBOARD SCHEDULES

| B-047C | DF 2017 / 18 DF 2017 / 18 |
|-------------------|------------------------------|
| DRAWN BY CS/MH | CHECKED BY VA/EN |
| LOCATION NO. | FILE NO. |

DRAWING NO.
E401

1