THE SCHOOL DISTRICT OF PHILADELPHIA BOARD OF EDUCATION

Office of Capital Programs 440 North Broad Street, Third Floor - Suite 371 Philadelphia, PA 19130-4015

TELEPHONE: (215) 400-4730

Addendum No. 01

Subject: R. Morris Classroom Modernization Project

B-043C, B-044C of 2018/19

Location: Robert Morris School

2600 W. Thompson Street Philadelphia, PA 19121

This Addendum, dated February 28, 2019, shall modify and become part of the Contract Documents for the work of this project. Any items not mentioned herein, or affected by, shall be performed strictly in accordance with the original documents.

1. Revisions to Drawings and Specifications

- a. Toilet Accessory Schedule on drawing I4.1 has been revised. Refer to attached drawing.
- b. Details G/I4.3, H/I4.3 and 3/I4.3 have been revised. Refer to attached drawing.

2. Questions and Clarifications

1. Question: Will another manufacturer besides Campbell Rhea be accepted?

<u>Response</u>: Campbell Rhea is the Basis of Design manufacturer. Manufacturers providing equal products may be submitted for review.

2. Question: Can MBE/WBE requirements be reduced to a combined goal?

Response: 15/20% Combined MBE/WBE Goal already included in the Bidding Documents.

3. Question: Please provide a spec for Electrostatic painting.

Response: Specification SECTION 105115: ELECTROSTATIC PAINTING already included in the Technical Specifications.

4. Question: Spec 101100 Visual Display, 1.2.A, Markerboard and Tackboard infills by GC, plans say by SDP. Who is responsible for them?

<u>Response</u>: Interactive Panel Boards (IPBs) shall be supplied and installed by others under the direction of the SDP. Provide blocking for IPBs as necessary and as indicated in the drawings.

Markerboards and tackboards shall be supplied by the SDP and installed by the contractor. The contractor shall coordinate with other prime contractors and field verify for the boards and advise

SDP of any discrepancy or interferences affecting the design intent.

Markerboard and tackboard inserts shall be supplied and installed by the contractor.

5. Question: Please confirm all visual display boards supplied by SDP will be delivered to each location by the SDP.

Response: Yes, Owner supplied visual display boards will be delivered to the school.

6. Question: Reference spec. 101100; Owner supplied visual display units, par. 1.3 B .3. Please provide manufacturers installation details.

Response: Proceed on the basis that the Owner-supplied visual display units are similar in type to those listed in specification section 10 1100 VISUAL DISPLAY UNITS and install in accordance with the manufacturer's instructions as described in the specifications.

7. <u>Question</u>: Reference Supplementary Conditions section 16, photographs. Please consider deleting this section from scope of work as it does not seem appropriate or necessary for these type of projects.

Response: Already deleted by Section 01 1400 MODIFICATIONS TO THE GENERAL AND SUPPLEMENTARY CONDITIONS.

8. Question: Ceramic Tile is listed as a scope item in the multiple contract summary but is not shown on the drawings. Please clarify.

<u>Response</u>: Summary of work states "Installation of new ceramic tile floor, base and wainscot as indicated on the drawings." Drawings take precedence over summary of work.

9. Question: Reference Morris School drawings D1.1-D1.2 NOTE 14 indicates prepare board for new infill (no demo). Drawings 14.1-14.2 elevations and schedules indicate SDP supplied boards @ these locations. Please confirm which is correct leave existing boards in place & infill per spec. or demo existing boards and install SDP supplied boards.

Response: Revised Drawing D1.1 and D1.2 to remove note #14 in its entirety and revised to read Note #16. Refer to attached drawings.

10. Question: Detail 2/A1.2; demo existing gypsum soffit. On past projects, that material is transite not gypsum, it is not listed in the asbestos report. Was it tested? Do we assume it is a gypsum soffit?

<u>Response</u>: Material is listed in specification section 01 1100 ENVIRONMENTAL COORDINATION issued for bid; review this section for information.

11. Question: Drawing ED.I: Do we remove and re-install ceiling fans in Rooms 216 and 218? Note on drawing states to blank off clock.

Response: All existing ceiling-mounted circulation fans are to be removed and reinstalled in place to accommodate new ceiling. Contractor to field test functionality and replace switch if required. Refer to revised Note 5 on Sheet ED1.2.

12. <u>Question</u>: Are new panels LF and LB custom built retrofits? Were measurements taken of the existing backbox?

Response: The existing back boxes for Panels LF & LB are approximately 16"W x 4.5" D x 48" H. Provide new 54 pole panelboard with the dimensions 20"W x 5.75"D x 60" H. Electrical Contractor to cut existing wall as required to fit new panelboard, patch and paint wall to match adjacent existing wall finish. Refer to revised electrical drawings, attached.

13. <u>Question</u>: Drawing E2.1: "Allowances and Unit Prices." Bid form does not show either allowances or unit prices. What are we bidding?

<u>Response</u>: No Allowances and Unit Prices are required for electrical devices. Refer to revised electrical drawings, attached.

14. <u>Question</u>: Were house phones in all eight classrooms checked for operation? How do we bid to replace if not working?

Response: House phones are not in scope.

END OF ADDENDUM NO. 1

Attachment(s) 9

Drawings - D1.1, D1.2, I4.1, I4.3, ED1.2, E2.1, E2.2, E5.1, E6.1

Specification(s) - None

GENERAL ALTERATION NOTES:

- R1. GENERAL CONTRACTOR IS RESPONSIBLE FOR VERIFICATION AND RECORDING OF R6. ALL EXISTING MATERIALS AND FINISHES DISTURBED OR INTERRUPTED BY THE ALL EXISTING BUILDING DIMENSIONS AND CONDITIONS RELATED TO THE WORK, INCLUDING BUT NOT LIMITED TO FINISHES, MATERIALS AND SYSTEMS SHOWN AND DESIGNATED AS EXISTING IN CONTRACT DOCUMENTS. ANY DISCREPANCIES FROM INFORMATION INDICATED ON CONTRACT DOCUMENTS SHALL BE DIRECTED TO THE ATTENTION OF THE ARCHITECT. VERIFICATION OF CLEARANCES REQUIRED FOR ALL NEW EQUIPMENT, PIPING, DUCTWORK, AND RELATED COMPONENTS SHALL BE THE CONTRACTORS RESPONSIBILITY.
- R2. GENERAL CONTRACTORS RESPONSIBILITY TO REVIEW WITH THE OWNERS REPRESENTATIVE. ALL ITEMS REQUIRING REMOVAL BEFORE THE START OF WORK. OWNER RESERVES THE RIGHT TO SALVAGE ANY ITEM. ALL REMAINING ITEMS SHALL BE DISPOSED OF OFF SITE.
- R3. WHERE EXISTING WALL OPENINGS ARE INDICATED TO BE CLOSED, USE MATERIALS AND FINISHES TO MATCH ADJACENT EXISTING FINISHES. MASONRY SHALL BE TOOTHED INTO THE EXISTING COURSING TO ACHIEVE A UNIFORM JOINT PATTERN TO MATCH THE EXISTING.

R4. ALL NEW MASONRY WALLS AND INFILLS THAT ARE IN CONTINUANCE WITH

TO ACHIEVE A UNIFORM JOINT PATTERN TO MATCH THE EXISTING, FIELD VERIFY WALL THICKNESS. R5. IN ALL RENOVATED AREAS OF THE WORK, THE INTENT OF THESE CONTRACT

EXISTING MASONRY WALLS SHALL BE TOOTHED INTO THE EXISTING COURSING

- DOCUMENTS IS TO PROVIDE A LEVEL OF QUALITY FOR ALL PATCHED SURFACES EQUAL TO THAT OF NEW SURFACES, INCLUDING BUT NOT LIMITED TO PLASTER, GYPSUM WALL BOARD AND MASONRY.
- WORK SHALL BE REPLACED OR "FILLED IN" TO ACHIEVE UNIFORM COLOR, TEXTURE, PATTERN AND APPEARANCE TO MATCHING ADJACENT MATERIALS AND FINISHES. TRANSITIONS BETWEEN EXISTING TO EXISTING AND NEW TO EXISTING MATERIALS AND FINISHES SHALL BE ACHIEVED IN STRAIGHT HORIZONTAL AND OR VERTICAL LINES BETWEEN DIFFERENT AND OR NEW MATERIALS AND FINISHES.
- R7. PATCH ALL HOLES IN FLOORS. WALLS AND CEILINGS. LEVEL WITH EXISTING ADJACENT SURFACES TO RECEIVE NEW FINISHES AND/OR CONSTRUCTION TO COMPLETE THE WORK. MATCH THE EXISTING ADJACENT MATERIALS, PATTERNS AND FINISHES.
- R8. PATCH, REPAIR OR REPLACE ALL EXISTING FINISHES AND MATERIALS DISTURBED DURING CONSTRUCTION OR AS A RESULT OF DEMOLITION OR REMOVAL OF AN ITEM. ALL REPAIR OR REPLACEMENT SHALL MATCH ADJACENT EXISTING AND/OR NEW FINISHES, PATTERNS AND MATERIALS. SEE ROOM FINISH SCHEDULE FOR NEW FINISHES.
- R9. PREPARE EXISTING REMAINING WORK SUBSTRATES TO RECEIVE NEW FINISHES AS INDICATED ON THE ROOM FINISH SCHEDULE. SUBSTRATE PREPARATION SHALL BE IN CONFORMANCE WITH THE INSTALLATION REQUIREMENTS OF EACH NEW FINISH.

BUILDING SHALL BE NEW AND TOOTHED INTO EXISTING MASONRY. MATCH

EXISTING COURSING, JOINT PATTERN AND THICKNESS UNLESS NOTED

R10. ALL WALLS SHOWN WITH MASONRY HATCHING WITHIN THE EXISTING

R11. MASONRY WALLS AND INFILLS THAT ARE IN CONTINUANCE WITH EXISTING MASONRY WALLS SHALL BE TOOTHED INTO THE EXISTING COURSING TO ACHIEVE A UNIFORM JOINT PATTERN TO MATCH THE EXISTING WORK.

MATCH EXISTING WALL THICKNESS.

- R12. AT THE DEMOLITION OF AN EXISTING ITEM, REMOVE ALL TRACES OF THE DEMOLISHED ITEMS COMPONENTS FROM THE SURFACE OF THE REMAINING FLOOR, WALLS AND CEILING. AT THE REMOVED FASTENERS IN ALL EXISTING MASONRY WALLS AND FLOORS, PATCH HOLE WITH GROUT LEVEL WITH EXISTING ADJACENT SURFACES IN ORDER TO RECEIVE NEW FINISHES.
- R13. AT EXISTING FLOORS: CUT IN PLACE CONSTRUCTION TO RECEIVE NEW WORK. REPLACE WITH MATERIALS TO MATCH EXISTING REMAINING MATERIALS. PATCH FLUSH TO ADJACENT EXISTING ELEVATIONS. APPLY CEMENTITIOUS UNDERLAYMENT TO PRODUCE A UNIFORM SURFACE IN ALL AREAS RECEIVING NEW FINISHES AS INDICATED ON THE ROOM FINISH SCHEDULE. PATCHED JOINTS SHALL NOT TELEGRAPH THRU THE NEW FINISH. SEE DRAWINGS AND SPECIFICATIONS FOR ADDITIONAL DESCRIBED FOR THE WALLS. REQUIREMENTS AND OTHER FINISHES.
- R14. AT EXISTING FLOORS: WHERE WALLS ARE SCHEDULED FOR DEMOLITION AND EXTEND TO BELOW THE CONTINUOUS CONCRETE FLOOR SLAB, THE WALL SHALL BE DEMOLISHED TO BELOW THE FLOOR THICKNESS. THE FLOOR SHALL BE PATCHED WITH CONCRETE AND GRANULAR FILL TO MATCH THE EXISTING THICKNESS, PROVIDE NEW VAPOR BARRIER TO THE PATCHED AREA. PATCH FLUSH TO ADJACENT EXISTING ELEVATIONS. APPLY CEMENTITIOUS UNDERLAYMENT TO PRODUCE A UNIFORM SURFACE IN ALL AREAS RECEIVING NEW FINISH AS INDICATED ON ROOM FINISH SCHEDULE. PATCHED JOINTS SHALL NOT TELEGRAPH THRU THE NEW FINISH.
- R15. PAINT EXISTING METALS: AT EXISTING DOOR FRAMES TO REMAIN AND OTHER PAINTED METAL COMPONENTS INDICATED. REMOVE ALL DIRT, LOOSE PAINT AND RUST, SAND ENTIRE FRAME, PRIME AND PAINT. COLOR SELECTION BY ARCHITECT. WHERE THE EXISTING PAINT IS INCOMPATIBLE WITH NEW PAINT COATINGS, THE EXISTING PAINT SHALL BE COMPLETELY REMOVED.
- R16. PAINT SURFACES: WHERE PATCHING OCCURS IN THE WORK OF AN EXISTING PAINTED SURFACE, THE PATCHED AREA SHALL BE SPACKLED, PRIMED AND INTERMEDIATE PAINT COATS APPLIED OVER THE PATCH. APPLY FINAL PAINT COAT OVER ENTIRE UNBROKEN SURFACE CONTAINING THE PATCH. THE UNBROKEN SURFACE SHALL BE FROM THE INTERSECTION OF THE WALL TO FLOOR TO THE INTERSECTION OF THE WALL TO CEILING AND FROM THE RIGHT SIDE WALL TO WALL INTERSECTION TO THE LEFT SIDE WALL TO WALL INTERSECTION. PROVIDE ADDITIONAL SPACKLING AND/OR PAINT COATS UNTIL THE PATCH AREAS BLEND INVISIBLY INTO THE ADJACENT EXISTING SURFACE. UNBROKEN CEILING SURFACES SHALL BE FROM CEILING TO WALL INTERSECTION AND OR NEW BULKHEAD CEILING ELEVATION CHANGE FOR THE ENTIRE PERIMETER OF THE CEILING AREA. APPLY PAINT COATS AS
- R17. AT EXISTING CERAMIC TILE: AT DEMOLISHED ITEMS AND DAMAGED AREAS, FILL ALL HOLES IN EXISTING CERAMIC WALL AND FLOOR TILE THAT ARE UP TO 1" WITH A COLOR EPOXY GROUT TO MATCH THE EXISTING CERAMIC TILE COLOR. REMOVE AND REPLACE EXISTING TILES AT HOLES THAT ARE OVER 1" AND AT ALL BROKEN AND MISSING WALL AND FLOOR TILES WITH A NEW TILE TO MATCH EXISTING COLOR AND SIZE.



DEMOLITION NOTE

REMOVING EXISTING FLOORING AND BASE IN ITS ENTIRETY INCLUDING ALL ADHESIVES. REMOVE ALL TRANSITION STRIPS (WHERE OCCUR) AND PREPARE FOR NEW TRANSITION STRIPS AT ALL MATERIAL TRANSITIONS AS SCHEDULED. PREPARE AND LEVEL SUBFLOOR TO RECEIVE NEW FINISH AND BASE AS SCHEDULED.

EXISTING HARD CEILING SHALL BE SCRAPPED; REMOVE ANY/ALL ABANDONED OR UNUSED CONDUIT, WIRING, FASTENERS, BRACKETS, PROJECTORS AND MOUNTS AND ASSOCIATED ACCESSORIES IN THEIR ENTIRETY. ALL ABANDONED OR UNUSED CONDUIT, WIRING AND PIPING SHALL BE REMOVED TO THE SOURCE OF SUPPLY. PATCH ANY AND ALL PENETRATIONS AND CRACKING THROUGHOUT AND PREPARE CEILINGS, BEAMS, EXPOSED PIPING AND CONDUIT AND ASSOCIATED ACCESSORIES TO RECEIVE NEW FINISH MATCHING ADJACENT SURFACE AS SCHEDULED. WHERE CAPPING OF OLD OR ABANDONED SYSTEMS OCCURS, PROVIDE COVER PLATE AND PAINT TO MATCH EXISTING SURFACES. REFER TO ENGINEERING DRAWINGS FOR FURTHER INFORMATION WHERE OCCURS.

EXISTING WALLS SHALL BE SCRAPPED; REMOVE ANY/ALL ABANDONED OR UNUSED CONDUIT, WIRING, FASTENERS, BRACKETS, PROJECTORS AND MOUNTS, PROJECTOR SCREENS AND ASSOCIATED ACCESSORIES IN THEIR ENTIRETY. ALL ABANDONED OR UNUSED CONDUIT, WIRING AND PIPING SHALL BE REMOVED TO THE SOURCE OF SUPPLY. PATCH ANY AND ALL PENETRATIONS AND CRACKING THROUGHOUT AND PREPARE WALLS, COLUMNS, EXPOSED PIPING AND CONDUIT AND ASSOCIATED ACCESSORIES TO RECEIVE NEW FINISH MATCHING ADJACENT FINISHED SURFACE AS SCHEDULED. WHERE CAPPING OF OLD OR ABANDONED SYSTEMS OCCURS, PROVIDE COVER PLATE AND PAINT TO MATCH EXISTING SURFACES. WHERE PIPE INSULATION IS ABATED IN ACCORDANCE WITH THE DISTRICT ASBESTOS INSPECTION REPORT AND THE ENVIRONMENTAL REMEDIATION SCOPE OF WORK PROVIDE NEW JACKETED FIBERGLASS PIPE INSULATION, JOHNS MANVILLE MICRO-LOK OR EQUAL, TO REPLACE THE REMOVED MATERIAL. NEW INSULATION SHALL EXTEND TO UNDERSIDE OF CEILING AND PAINTED TO MATCH ADJACENT FINISH SURFACE AS SCHEDULED. REFER TO ENGINEERING DRAWINGS FOR FURTHER INFORMATION WHERE OCCURS.

REMOVE SUSPENDED CEILING TILES IN ITS ENTIRETY; EXISTING CEILING GRID TO REMAIN. PREPARE FOR NEW CEILING TILES AS SCHEDULED.

REMOVE SUSPENDED CEILING ASSEMBLY IN ITS ENTIRETY. PREPARE ADJACENT SURFACES FOR NEW CEILING ASSEMBLY AS SCHEDULED. REMOVE EXISTING GYPSUM BULKHEAD AND ALL ASSOCIATED STRUCTURE AND FASTENERS AS INDICATED ON SECTION 2/A1.2, UNLESS NOTED OTHERWISE. PREPARE ADJACENT

EXISTING FINISHES FOR NEW WORK. EXISTING DOOR AND HARDWARE TO BE REMOVED IN ITS ENTIRETY FROM BOTH SIDES OF FRAME. INCLUDING BUT NOT LIMITED TO. SECURITY GRILL ASSEMBLIES. CLOSERS. CONDUIT

AND WIRING, AND ASSOCIATED ACCESSORIES AND FASTENERS. EXISTING FRAME TO REMAIN; REMOVE ANY AND ALL FASTENERS AND ADHESIVES AND PATCH AND PREPARE BOTH SIDES OF FRAME AND ADJACENT WALLS TO RECEIVE NEW DOOR AND HARDWARE AND FINISH AS SCHEDULED.

EXISTING DOOR AND FRAME TO REMAIN. ALL HARDWARE TO BE REMOVED. REMOVE ANY AND ALL FASTENERS, STAPLES AND ADHESIVES; PATCH AND PREPARE EXISTING DOORS TO RECEIVE NEW HARDWARE AND FINISH AS SCHEDULED.

REMOVE EXISTING TOILET COMPARTMENT PARTITIONS AND ALL ASSOCIATED FASTENERS IN THEIR ENTIRETY. PREPARE FOR NEW PARTITIONS AND FINISHES AS SCHEDULED XISTING BUILT-IN CASEWORK, BUILT-IN SHELVING AND/OR COAT HOOKS AND ASSOCIATED BLOCKING AND FASTENERS SHALL BE REMOVED IN THEIR ENTIRETY. PATCH AND PREPARE


ALL ADJACENT FINISHES FOR NEW WORK AND FINISH AS SCHEDULED. REMOVE EXISTING CUBBIES IN THEIR ENTIRETY AND RETURN TO OWNER. PREPARE EXISTING ADJACENT FINISHES FOR NEW WORK

EXISTING METAL STORAGE UNITS TO REMAIN. REMOVE EXISTING HARDWARE AND PREPARE FOR NEW HARDWARE AS SCHEDULED. PREPARE FOR NEW FINISH AS SCHEDULED. ALL EXISTING WINDOW SHADES AND ASSOCIATED COMPONENTS TO BE REMOVED IN THEIR ENTIRETY. PATCH ANY PENETRATIONS AND PREPARE FOR NEW WORK.

EXISTING UNIT VENTILATOR COVER TO BE REMOVED, REFINISHED AND REINSTALLED AS SCHEDULED. CLEAN UNIT VENTILATOR AND ALL ASSOCIATED COMPONENTS PRIOR TO

REINSTALLATION OF COVER.

REMOVE EXISTING DISPLAY BOARD, TRIM AND ALL RELATED COMPONENTS. PATCH AND REPAIR ADJACENT FINISHES TO MATCH EXISTING.

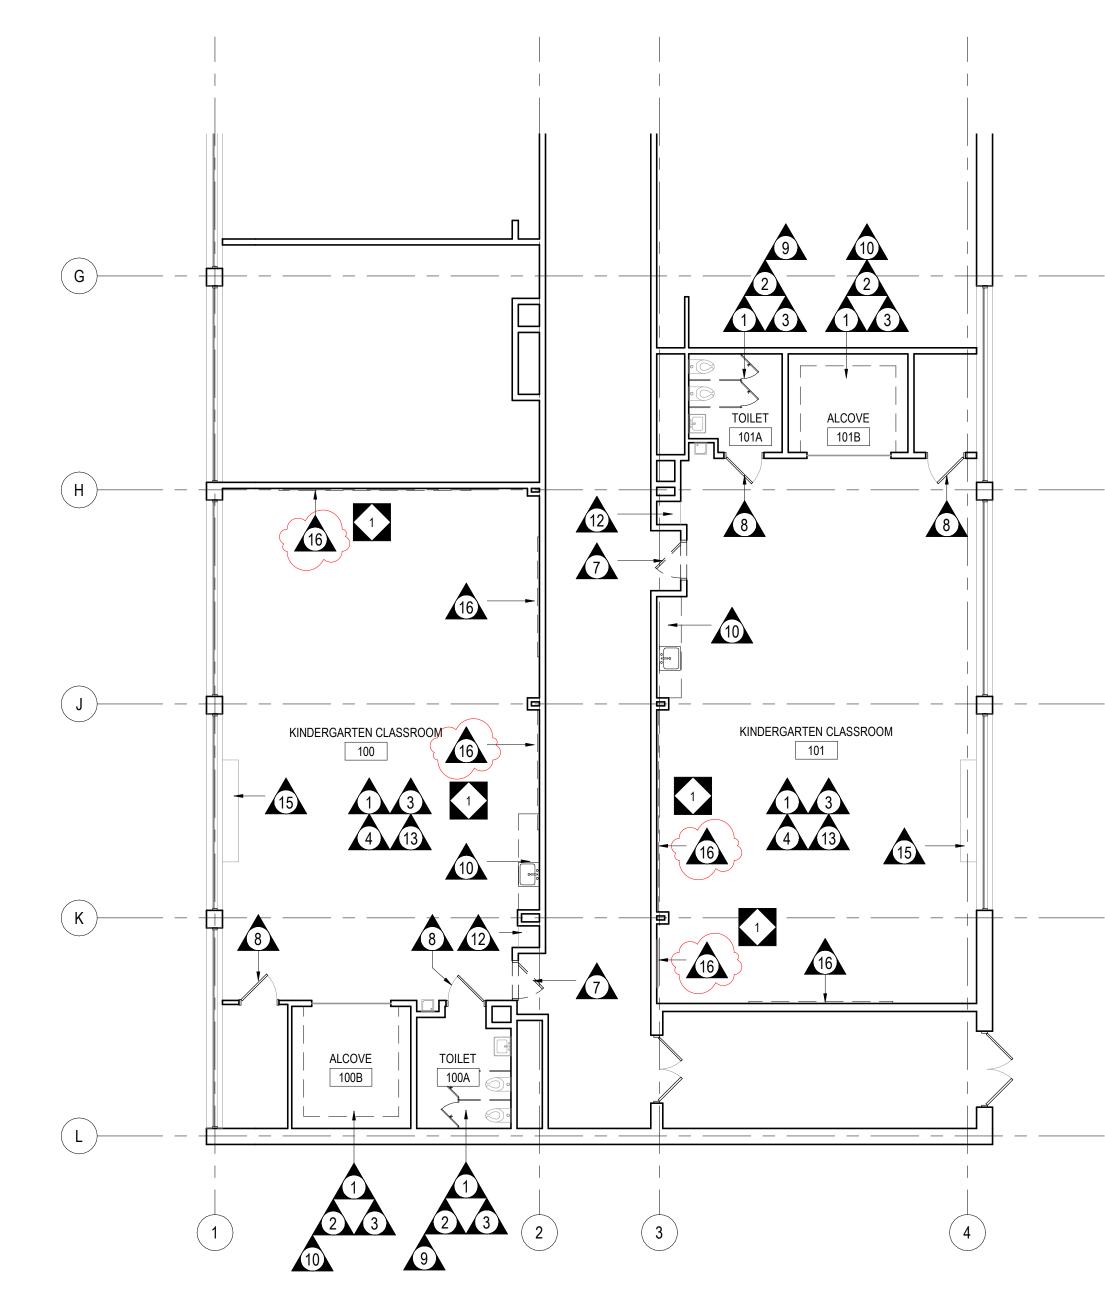

1 FIRST FLOOR DEMOLITION PLAN
D1.1 1/8" = 1'-0"

100% CONSTRUCTION

THE SCHOOL DISTRICT OF PHILADELPHIA

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<u>01/18/2019</u>

SCHOOL & LOCATION **MORRIS ELEMENTARY SCHOOL**

1 2/27/19 ADDENDUM #1

NO. DATE REVISION

2600 W. THOMPSON STREET, PHILADELPHIA, PA 19121

PROJECT TITLE


CLASSROOM **MODERNIZATION**

DRAWING TITLE

FIRST FLOOR DEMOLITION

LOCATION NO. FILE NO. CRA NO. 3223 CHECKED BY DRAWN BY


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100% CONSTRUCTION 01/18/2019
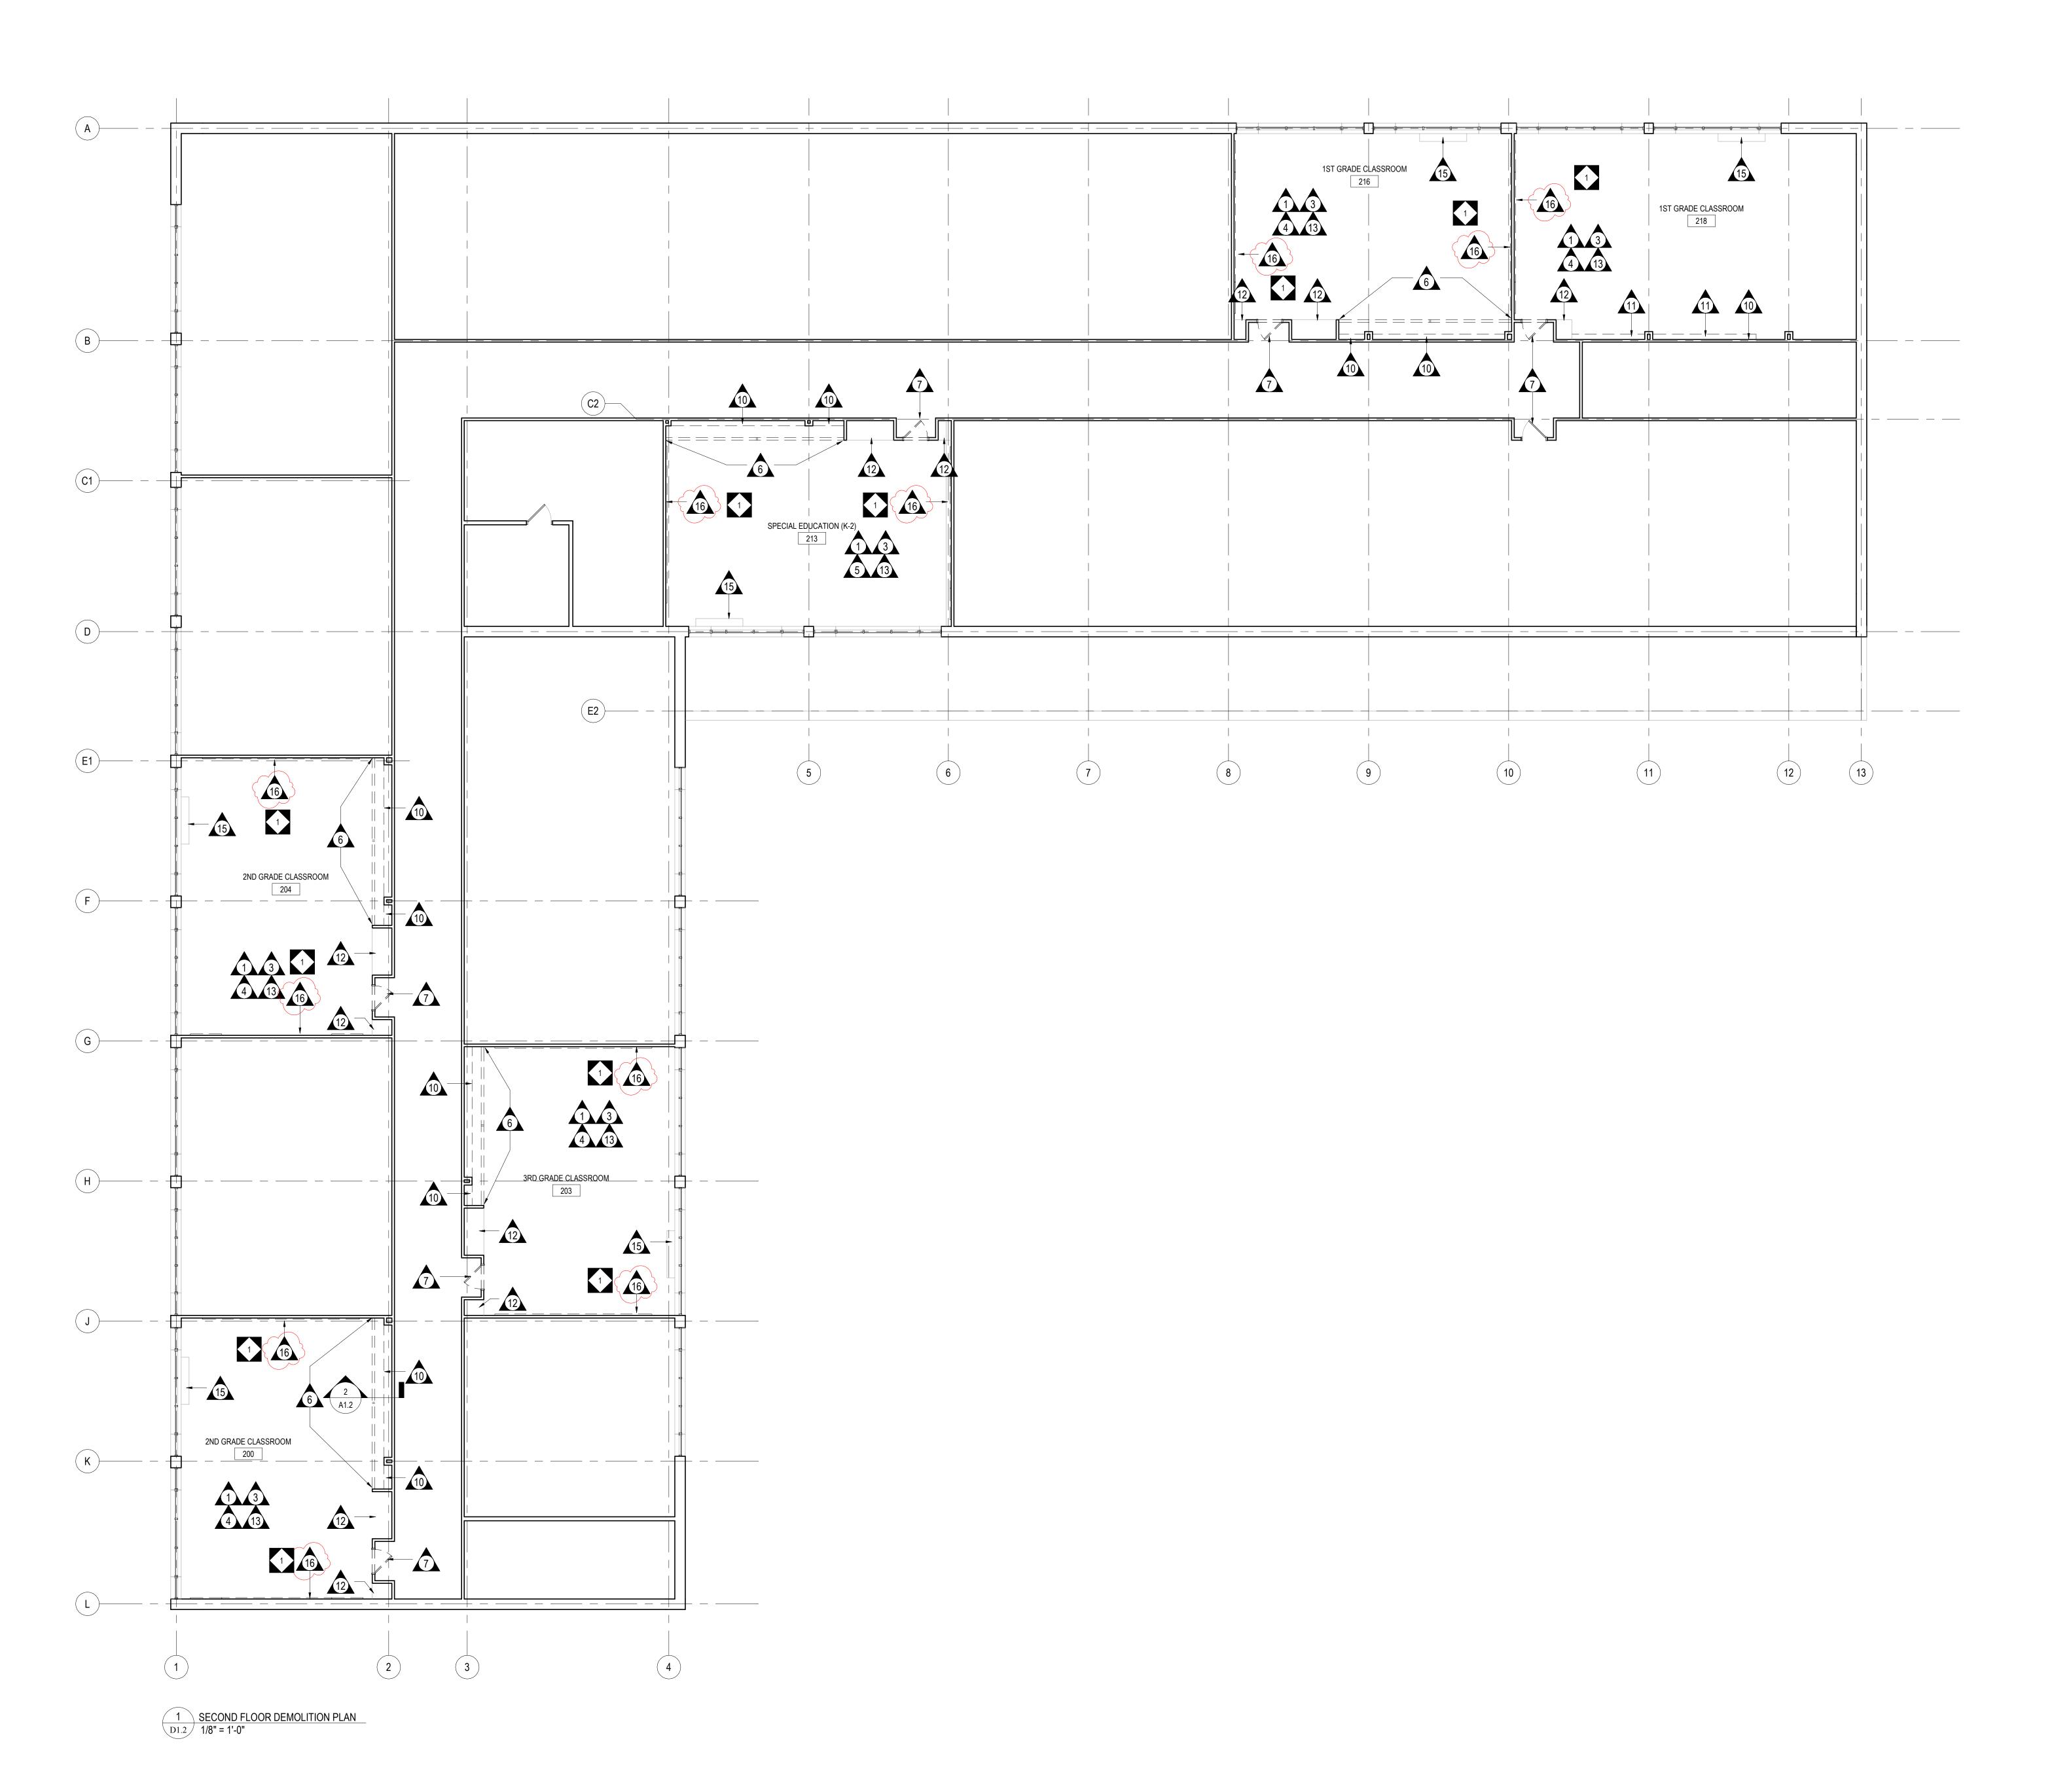
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1	2/27/19	ADDENDUM #1	
NO.	DATE	REVISION	

SCHOOL & LOCATION
MORRIS ELEMENTARY
SCHOOL

2600 W. THOMPSON STREET, PHILADELPHIA, PA 19121

PROJECT TITLE

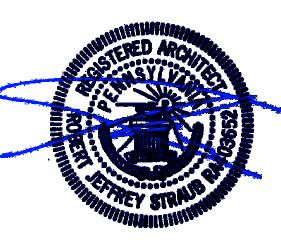
CLASSROOM MODERNIZATION

DRAWING TITLE

SECOND FLOOR DEMOLITION PLAN

B-043C B-044C	
DRAWN BY	CHECKED BY
LOCATION NO.	FILE NO. CRA NO. 3223

DRAWING NO.

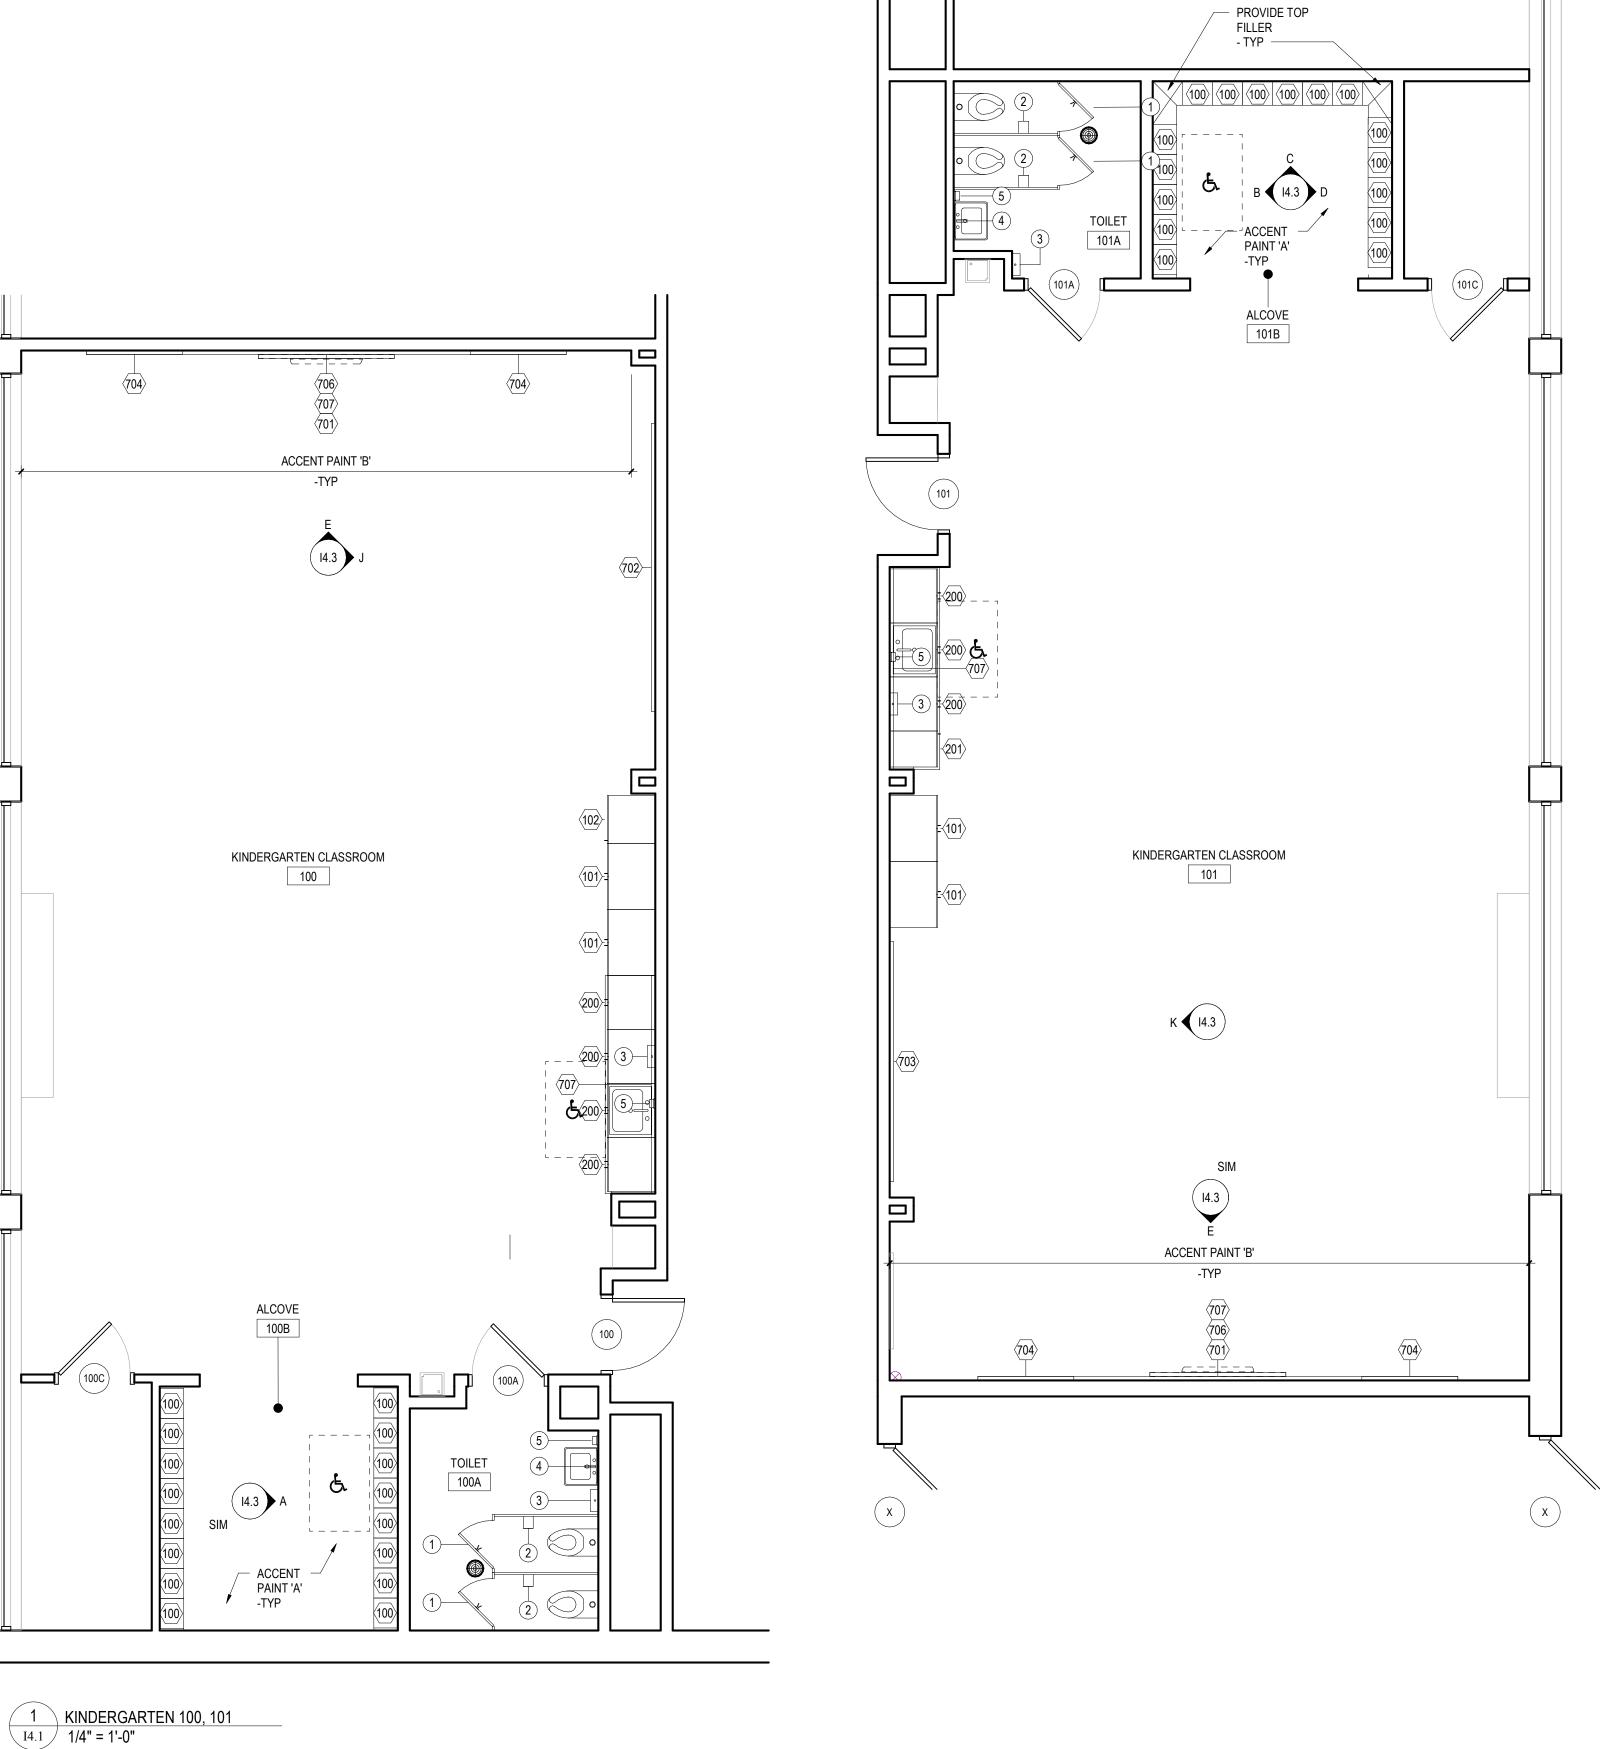

			TOILET ACCESSORY SC	HEDULE	
	No				
		DESCRIPTION	MOUNTING	MANUFACTURER	MODEL
>	1	TOILET PARTITION WITH COAT HOOK	GC SUPPLIED AND INSTALLED		
	2	TOILET PAPER DISPENSER	GC SUPPLIED AND INSTALLED	RENOWN	REN05151-IB
	3	SURFACE MTD PAPER TOWEL DISPENSER	GC SUPPLIED AND INSTALLED	RENOWN	REN05173-WB
	4	MIRROR 18" x 30" w/ SS FRAME	GC SUPPLIED AND INSTALLED		
	5	SOAP DISPENSER	GC SUPPLIED AND INSTALLED	KIMBERLY-CLARK	PROFESSIONAL 1000mL SKIN CARE


GENERAL NOTES:


1. HANDICAPPED FIXTURES ARE INDICATED WITH THE REQUIRED CLEAR FLOOR SPACE CLEARANCES FOR ALL ACCESSIBLE ROUTES & MANEUVERING CLEARANCES. 2. PLUMBING FIXTURE ROUGH-IN DIMENSIONS & TOILET PARTITION LAYOUT DIMENSIONS ARE FROM THE WALL FINISH MATERIAL.

3. PROVIDE WOOD BLOCKING IN STUD WALLS FOR ALL TOILET ACCESSORIES.

- 4. TOILET PARTITION DIMENSIONS ARE TO THE PANEL CENTERLINE UNLESS NOTED OTHERWISE. MINIMUM CLEAR DIMENSIONS MUST BE PROVIDED WHERE NOTED.
- 5. COORDINATE ALL WALL FINISHES WITH THE ROOM FINISH SCHEDULE.
- 6. CONTRACTOR TO CONFIRM WITH THE OWNER'S REPRESENTATIVE THE LOCATION OF ALL SURFACE-MOUNTED TOILET ROOM ACCESSORIES PRIOR TO INSTALLATION.
- 7. URINAL PARTITIONS SHALL BEGIN AT A HEIGHT NO MORE THAN 12" FROM AND EXTEND
- NOT LESS THAN 60" ABOVE THE FINISHED FLOOR SURFACE. URINAL PARTITIONS SHALL EXTEND FROM THE WALL SURFACE AT EACH SIDE OF THE URINAL A MINIMUM OF 18".

	I4.1 - GENERAL CASE	EWORK AND EQUIPMENT SCHEDU	ILE	
NO	DESCRIPTION	MANUFACTURER	MODEL	DIMENSIONS
100	OPEN STUDENT WARDROBE W/(1) DOUBLE HOOK & (2) SINGLE HOOKS EACH. MODIFIED TO INCLUDE (2) FIXED SHELVES. SEE CUBBIE DETAIL.	SEE SPECIFICATIONS		15"W x 12"D x 54"H
101	2-DOOR TALL STORAGE	SEE SPECIFICATIONS		33"W x 24"D x 84"H
102	1-DOOR TALL STORAGE - LEFT HINGED	SEE SPECIFICATIONS		24"W x 24"D x 84"H
200	2-DOOR BASE CABINET	SEE SPECIFICATIONS		27"W x 24"D x 26"H
201	1-DOOR BASE CABINET - LEFT HINGED	SEE SPECIFICATIONS		18"W x 24"D x 26"H
301	2-DOOR WALL CABINET	SEE SPECIFICATIONS		33"W x 14"D x 30"H
302	2-DOOR WALL CABINET	SEE SPECIFICATIONS		30"W x 14"D x 30"H
700	MARKERBOARD W/ALUMINUM FRAME	OWNER SUPPLIED, GC INSTALLED	SEE SPECIFICATIONS	14'-0"W x 4'-0"H
701	MARKERBOARD W/ALUMINUM FRAME	OWNER SUPPLIED, GC INSTALLED	SEE SPECIFICATIONS	12'-0"W x 4'-0"H
702	TACK BOARD W/ALUMINUM FRAME	OWNER SUPPLIED, GC INSTALLED	SEE SPECIFICATIONS	12'-0"W x 4'-0"H
703	TACK BOARD W/ALUMINUM FRAME	OWNER SUPPLIED, GC INSTALLED	SEE SPECIFICATIONS	10'-0"W x 4'-0"H
704	TACK BOARD W/ALUMINUM FRAME	OWNER SUPPLIED, GC INSTALLED	SEE SPECIFICATIONS	4'-0"W x 4'-0"H
705	TACK BOARD W/ALUMINUM FRAME	OWNER SUPPLIED, GC INSTALLED	SEE SPECIFICATIONS	22'-0"W x 1'-0"H
706	TACK BOARD W/ALUMINUM FRAME	OWNER SUPPLIED, GC INSTALLED	SEE SPECIFICATIONS	20'-0"W x 1'-0"H
707	TACK STRIP	OWNER SUPPLIED, GC INSTALLED	SEE SPECIFICATIONS	WIDTH TO FIT x 2"H

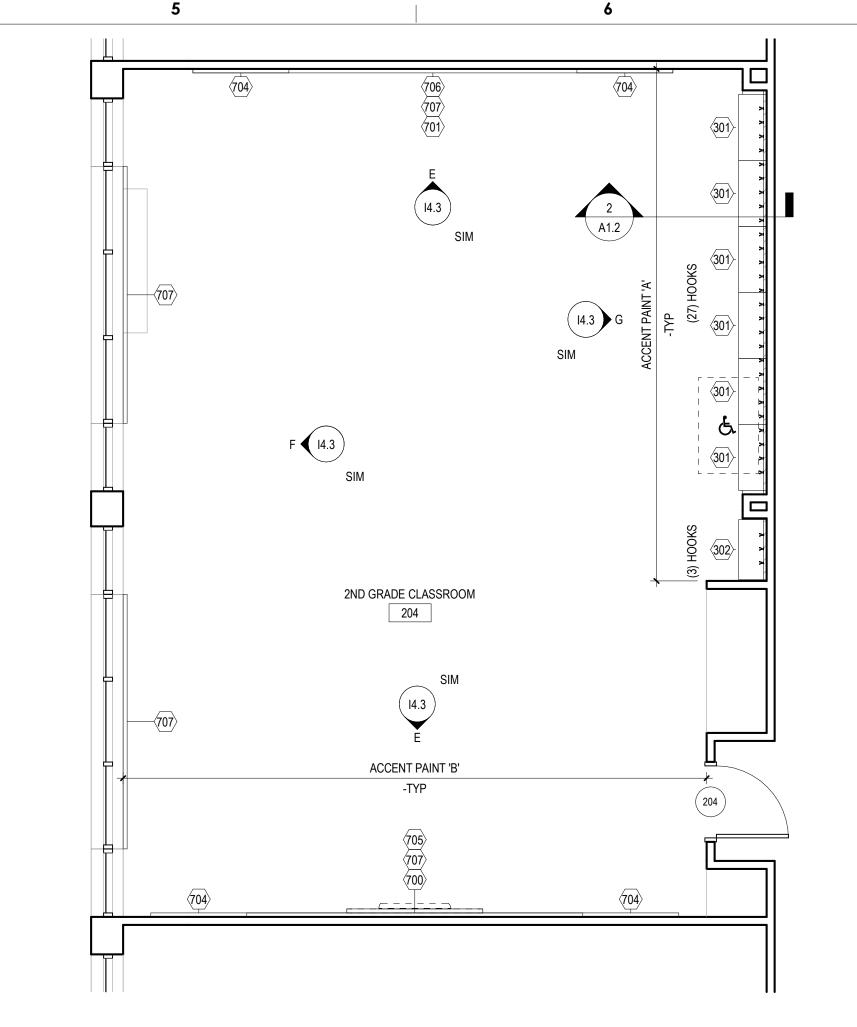

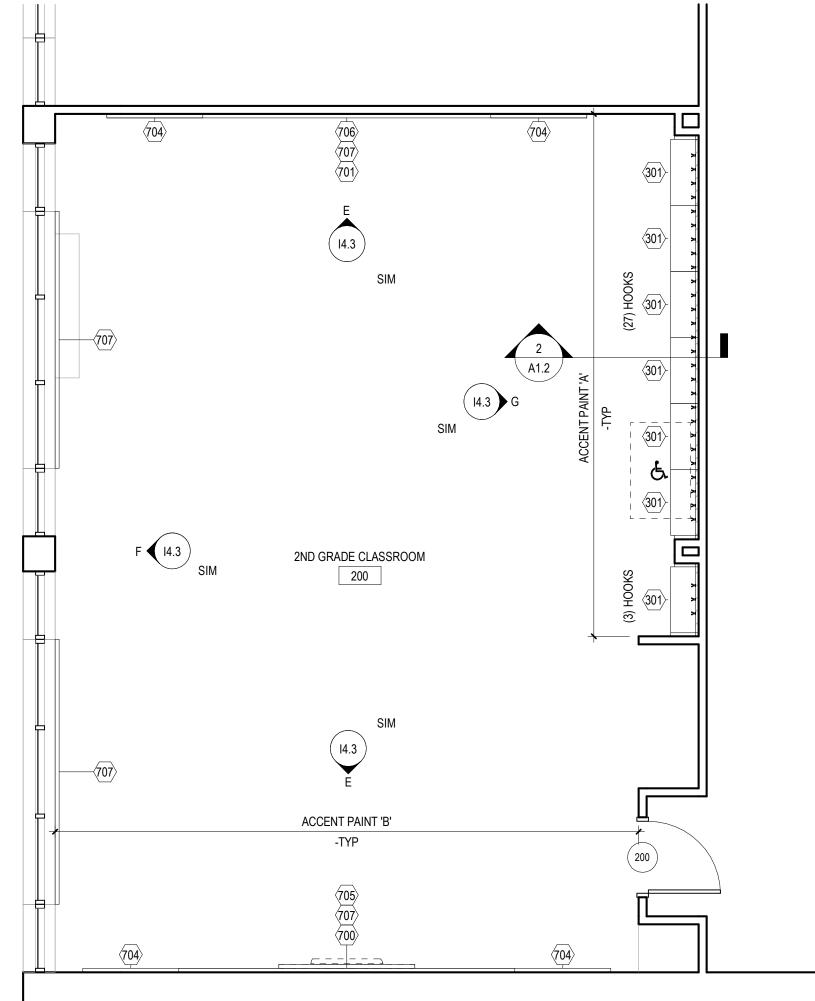

GENERAL NOTES TO APPLY TO ALL 14 DRAWINGS

1. MOUNTING HEIGHT SCHEDULE IS APPLICABLE TO MOST ROOMS. IN INSTANCE WHERE NOTE/DETAILS ON DRAWINGS DO NOT COINCIDE WITH THE SCHEDULE. THE DRAWINGS

TAKE PRECEDENCE. 2. WHERE COLUMNS, WINDOWS OR OTHER BUILDING COMPONENTS CONFLICT WITH CASEWORK DIMENSIONAL REQUIREMENTS. FIELD VERIFY DIMENSIONS AND PROVIDE

CUSTOM UNIT TO ALLOW PROPER FITTING. 3. ALL EXPOSED ENDS OF CASEWORK SHALL RECEIVE FINISHED END PANELS.

4. COLOR FOR INTERIOR OF OPEN CABINETS SHALL MATCH EXTERIOR LAMINATE COLOR. 5. ALL VISUAL DISPLAY AREAS (MARKER BOARDS AND/OR TACK BOARDS) 10'-0"W OR LONGER

SHALL RECEIVE 2"H MAP RAIL THAT SPANS FROM VERTICAL EDGE TO VERTICAL EDGE. 6. PROVIDE WOOD BLOCKING IN METAL STUD WALLS, PER MANUFACTURER'S RECOMMENDATIONS, TO RECEIVE THE TELEVISION WALL BRACKET.

- 7. IN ROOMS RECEIVING RESILIENT BASE, ADHERE TO ALL WALLS, BASE CABINET TOE KICKS, AND EXPOSED END PANELS. REFER TO SPECIFICATIONS FOR LOCATION OF 4" AND 6" BASE. 8. SEE REFLECTED CEILING PLANS FOR LOCATION OF WINDOW TREATMENTS.
- 9. TELEPHONE UNITS AND SYSTEMS ARE NOT IN CONTRACT. 10. COORDINATE ALL LARGE SCALE PLANS WITH MECHANICAL, ELECTRICAL AND PLUMBING
- 11. NIC = NOT IN CONTRACT 12. WHEN DESCRIPTION AND MODEL NUMBER IN CASEWORK AND EQUIPMENT SCHEDULE CONFLICT, THE DESCRIPTION TAKES PRECEDENCE.
- 13. OPP = OPPOSITE HAND. 14. COORDINATE ALL CASEWORK LAYOUTS AND VISUAL DISPLAY LAYOUTS WITH INTERIOR
- ELEVATIONS. IN INSTANCE WHERE FLOOR PLAN/ELEVATIONS DO NOT COINCIDE, FLOOR PLAN LAYOUT TAKES PRECEDENCE.

SIM / OPP

PRE-K & KINDERGARTEN MOUNTING HEIGHT SCHEDULE

NOTE: WHERE NEW MARKER BOARD OR TACK BOARD IS BEING MOUNTED

NEXT TO OR ON THE SAME WALL AS AN EXISTING TACK BOARD OR MARKER

NOTE: WHERE NEW MARKER BOARD OR TACK BOARD IS BEING MOUNTED

NEXT TO OR ON THE SAME WALL AS AN EXISTING TACK BOARD OR MARKER

GRADE 1-3 MOUNTING HEIGHT SCHEDULE

2'-6" AFF TO BOTTOM EDGE

2'-6" AFF TO BOTTOM EDGE

SEE TYPICAL SECTION DETAIL

CENTERED ON THE MARKER BOARD


2'-0" AFF TO BOTTOM EDGE

2'-0" AFF TO BOTTOM EDGE

3RD GRADE CLASSROOM 203

ACCENT PAINT 'B'

- 15. **VISUAL DISPLAY BOARD LAYOUT AND DIMENSIONS VARY VERIFY IN FIELD ALL** DIMENSIONS AND LAYOUTS PRIOR TO FABRICATION OR INSTALLATION.
- 16. OWNER PROVIDED, CONTRACTOR INSTALLED VISUAL DISPLAY BOARDS SHALL ALL BE VERIFIED IN FIELD, PRIOR TO FABRICATION & INSTALLATION.

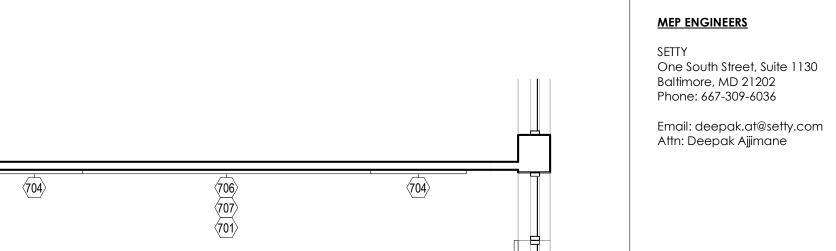

100% CONSTRUCTION 01/18/2019

THE SCHOOL DISTRICT OF PHILADELPHIA

OFFICE OF CAPITAL PROGRAMS

440 NORTH BROAD STREET

R. JEFFREY STRAUB STATE AND LICENSE NO: RA403652

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1	2/27/19	ADDENDUM #1
NO.	DATE	REVISION

SCHOOL & LOCATION MORRIS ELEMENTARY SCHOOL

2600 W. THOMPSON STREET, PHILADELPHIA, PA 19121

PROJECT TITLE

CLASSROOM **MODERNIZATION**

DRAWING TITLE

LARGE SCALE LAYOUTS -KINDERGARTEN, SECOND, THIRD GRADE

CATION NO.	FILE NO.
	CRA NO. 3223
AWN BY	CHECKED BY
B-043C B-044C	OF 2018 / 19 OF 2018 / 19
PAWING NO	

DRAWING NO.

MARKER BOARD

BOARD MATCH EXISTING HEIGHT.

BOARD MATCH EXISTING HEIGHT.

TACK BOARD


MARKER BOARD

TACK BOARD

WALL CABINETS

SMART-BOARD

2 SECOND GRADE 200, 204 & THIRD GRADE 203 I4.1 1/4" = 1'-0"

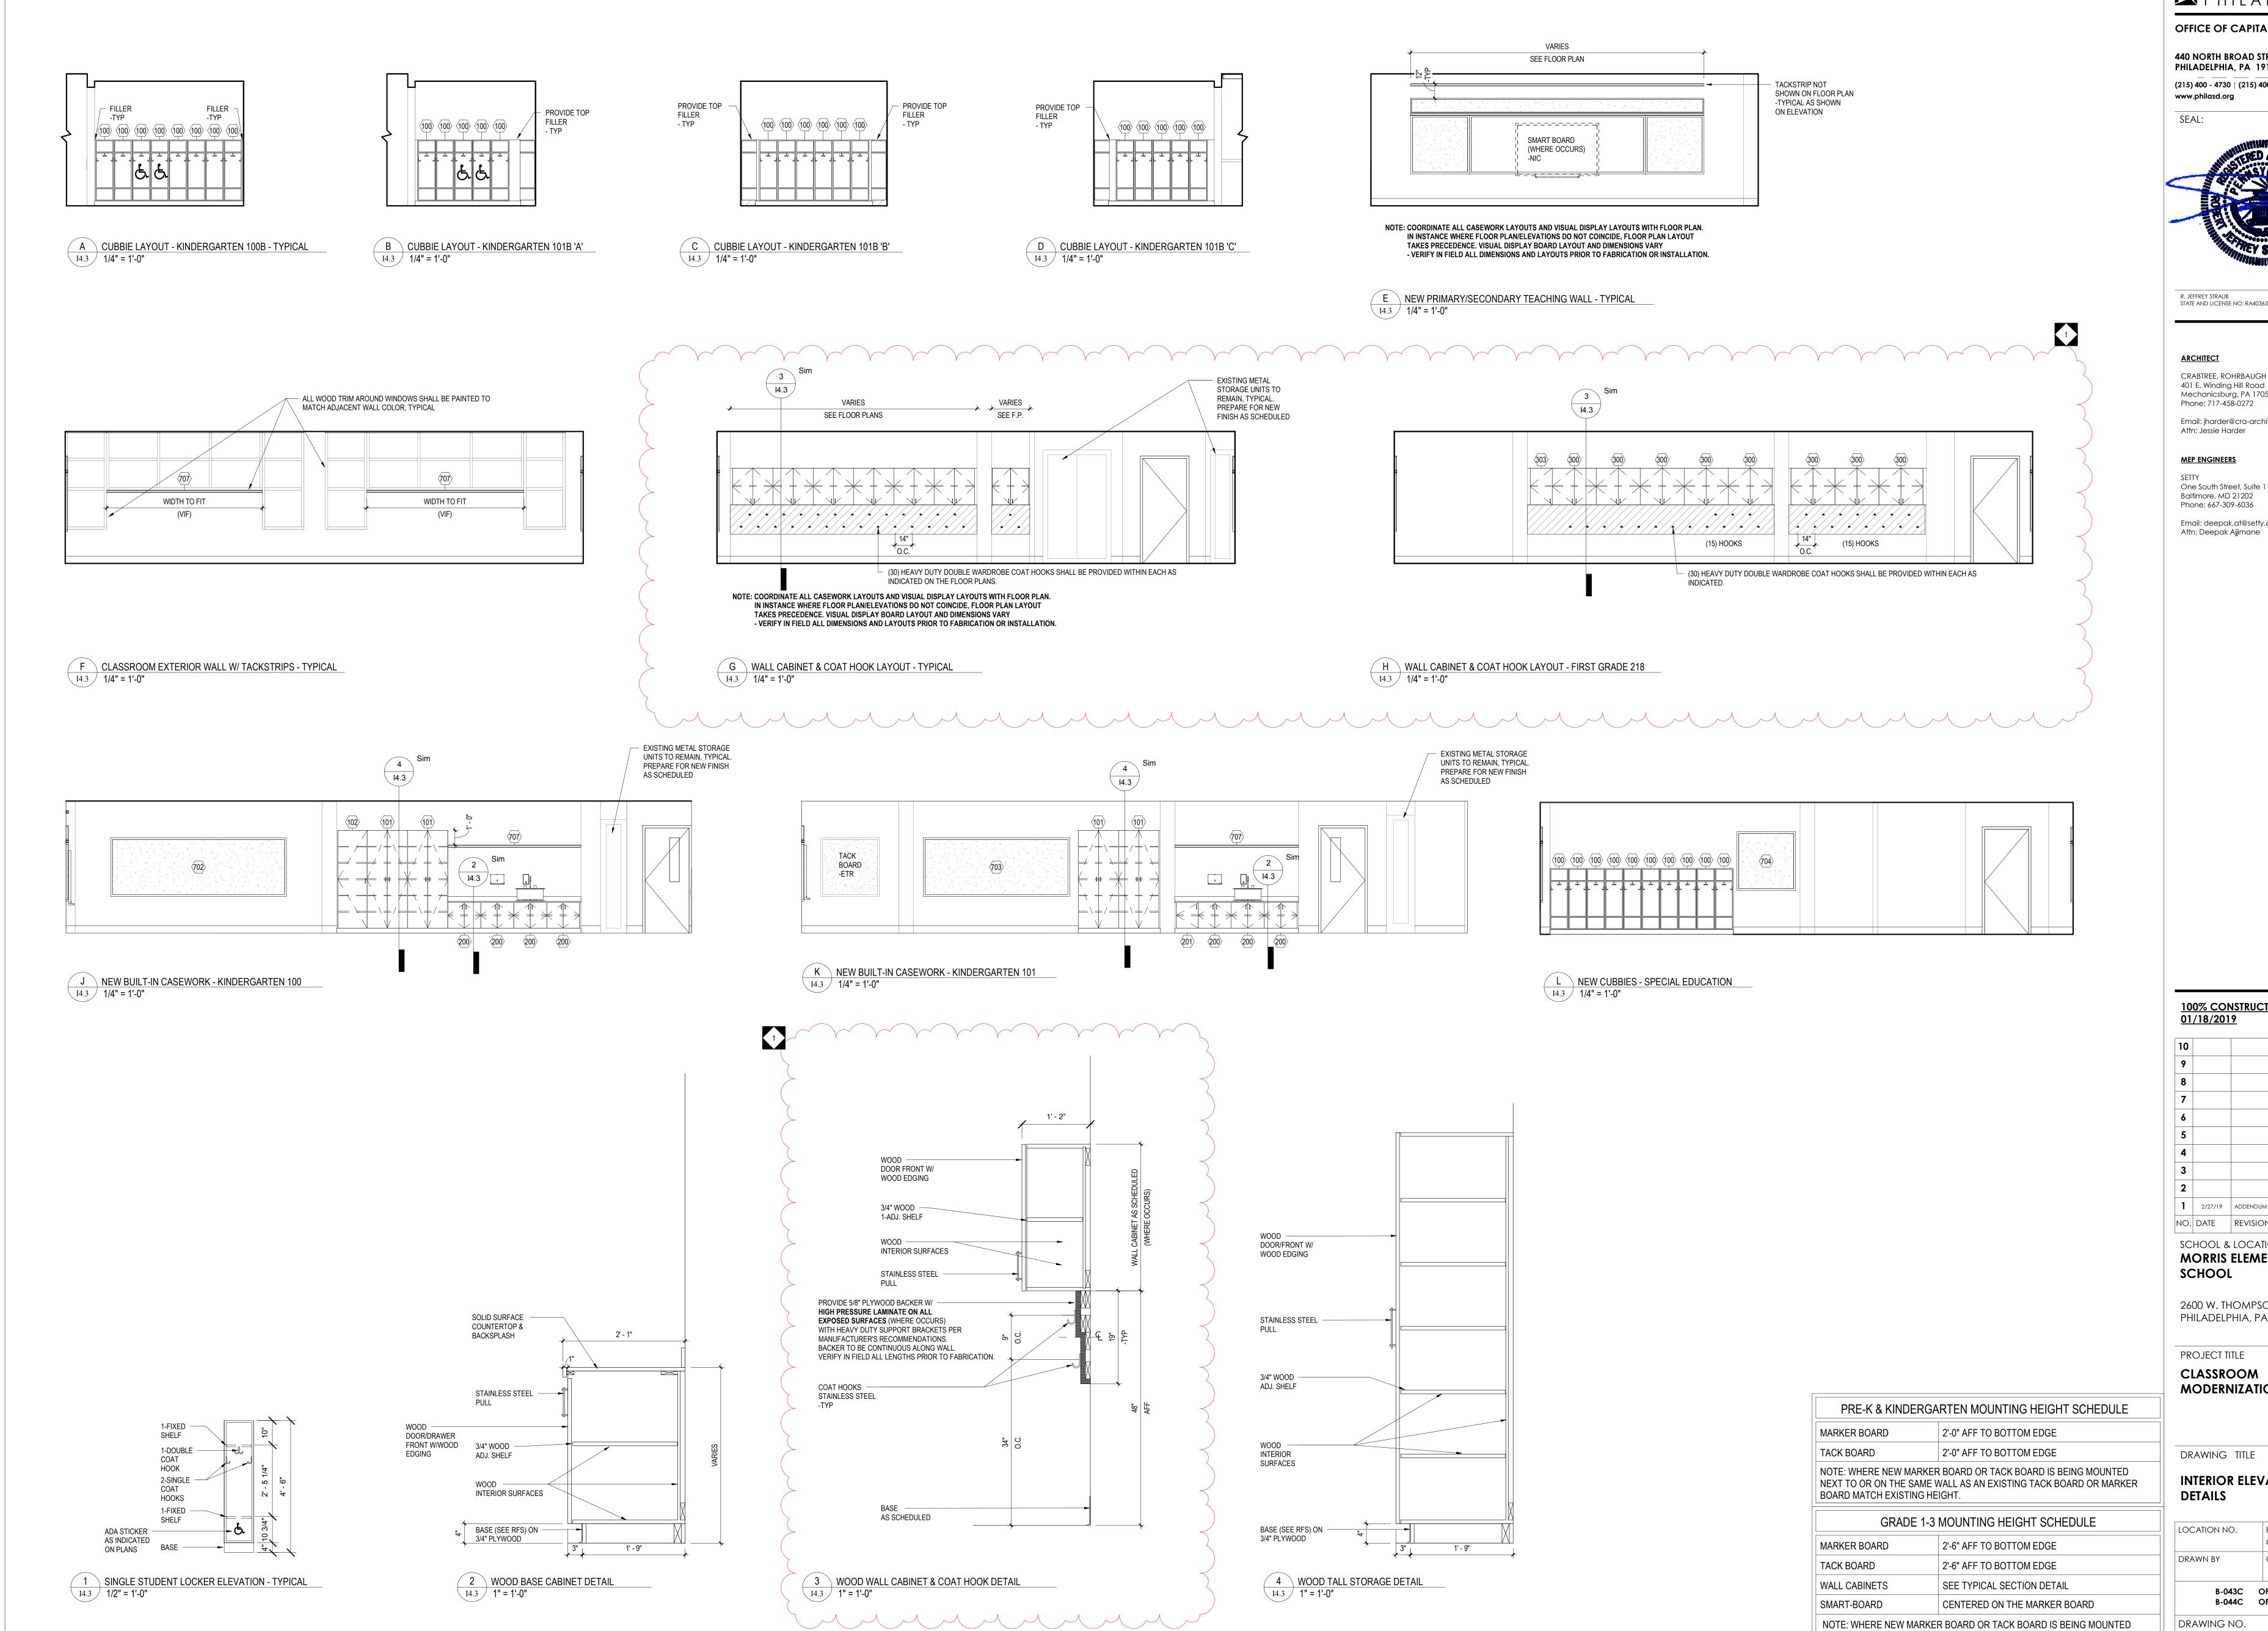

OFFICE OF CAPITAL PROGRAMS

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MEP ENGINEERS

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100% CONSTRUCTION 01/18/2019

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9		
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1	2/27/19	ADDENDUM #1
NO.	DATE	REVISION

SCHOOL & LOCATION **MORRIS ELEMENTARY** SCHOOL

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PROJECT TITLE

CLASSROOM **MODERNIZATION**

DRAWING TITLE


INTERIOR ELEVATIONS & DETAILS

	043C 044C	OF OF	2018 / 19 2018 / 19	
DRAWN BY		СН	ECKED BY	
LOCATION N	10.		E NO. A NO. 3223	

DRAWING NO.

NEXT TO OR ON THE SAME WALL AS AN EXISTING TACK BOARD OR MARKER

BOARD MATCH EXISTING HEIGHT.

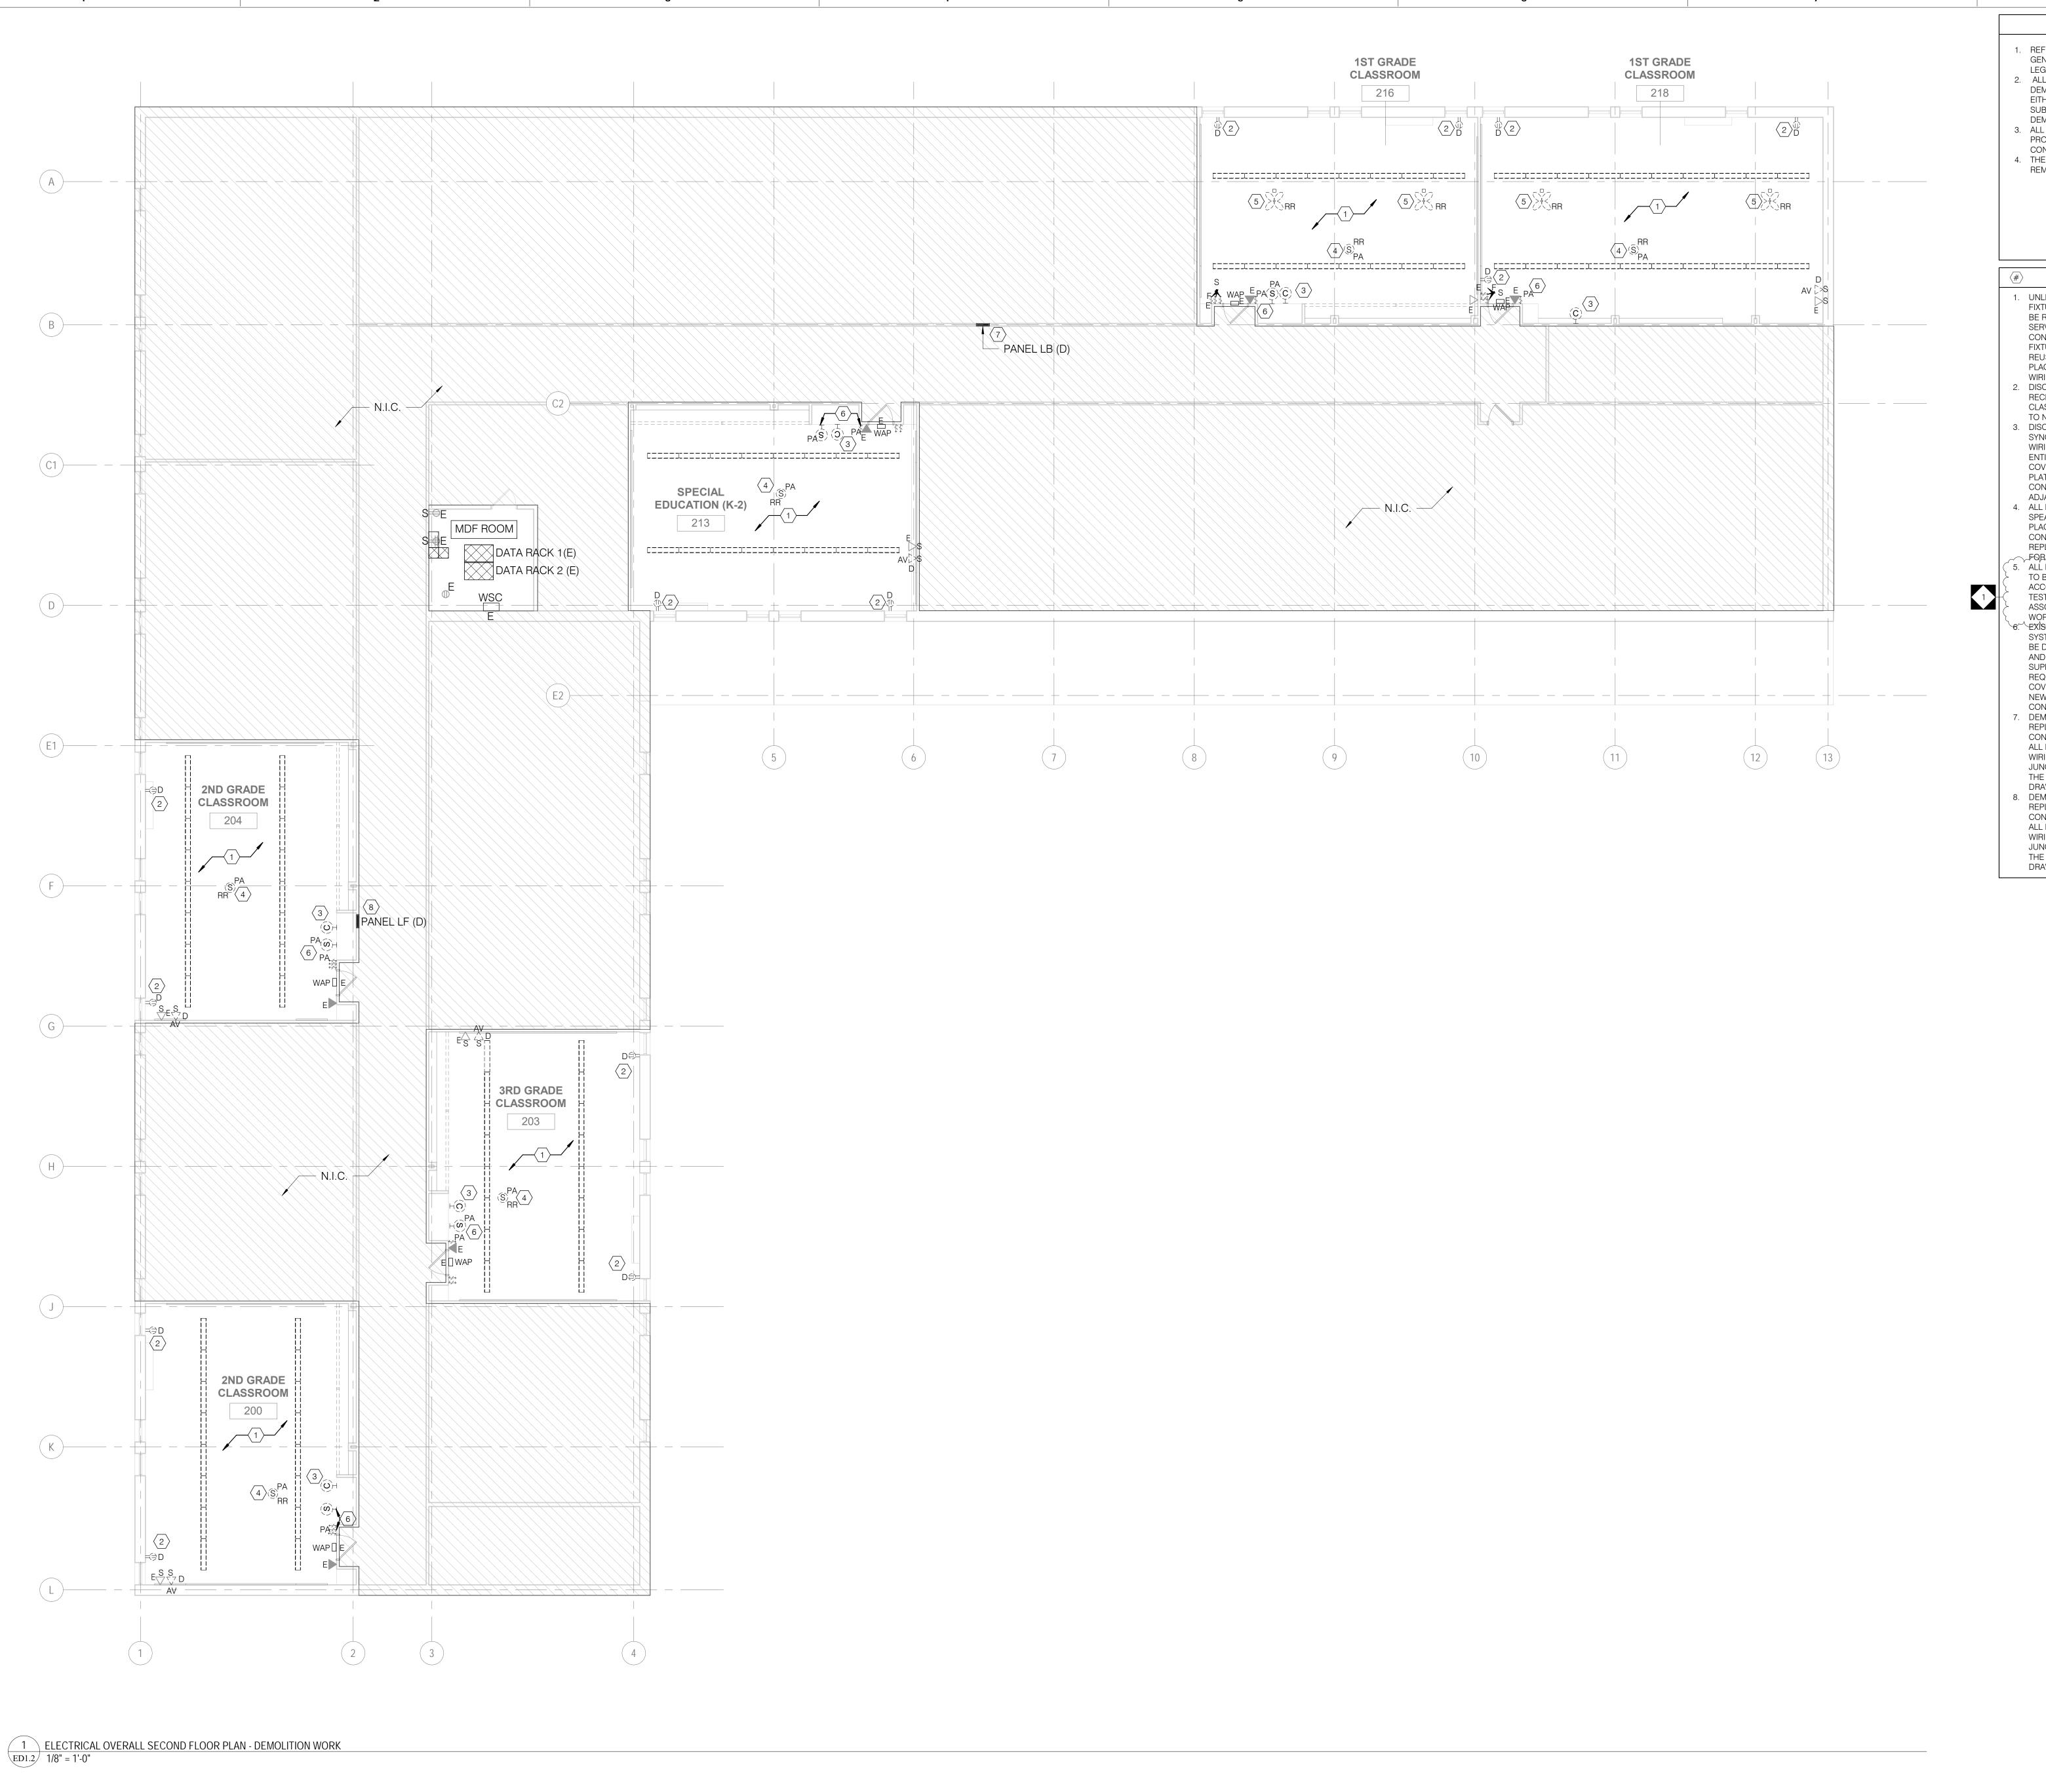

GENERAL SHEET NOTES

- . REFER TO DRAWING E0.1 FOR ELECTRICAL
- GENERAL NOTES, GENERAL DEMOLITION NOTES, LEGEND AND ABBREVIATIONS. 2. ALL ELECTRICAL DEVICES SHOWN ON THE DEMOLITION PLANS WITH DASHED LINES AND
- EITHER WITH SUBSCRIPT "D" OR WITHOUT ANY SUBSCRIPT INDICATE AN EXISTING DEVICE TO BE DEMOLISHED. 8. ALL EXISTING DEVICES TO REMAIN SHALL BE
- PROTECTED FROM DAMAGE THROUGHOUT THE CONSTRUCTION PROCESS. 4. THE CONTINUITY OF ALL EXISTING CIRCUITS TO REMAIN SHALL BE MAINTAINED.

KEYED SHEET NOTES

1. UNLESS OTHERWISE NOTED, ALL LIGHTING FIXTURES, CONTROLS AND ASSOCIATED WIRING TO BE REMOVED BACK TO SOURCE OF TERMINATION SERVING THIS CLASSROOM. PREPARE FOR CONNECTION OF EXISTING CIRCUIT TO THE NEW FIXTURES UNDER NEW WORK. CONTRACTOR SHALL REUSE THE EXISTING WIRING AND CONDUIT IN PLACE WHERE POSSIBLE. PROVIDE NEW WIRING/CONDUIT AS REQUIRED. . DISCONNECT AND REMOVE ALL EXISTING

- RECEPTACLES WITH COVERPLATE IN THIS CLASSROOM, EXISTING CIRCUIT TO REMAIN. REFER TO NEW WORK PLAN FOR ADDTIONAL INFORMATION. . DISCONNECT AND REMOVE ALL EXISTING SYNCHRONOUS CLOCK, CONDUIT/RACEWAY AND WIRING ASSOCIATED WITH THIS SYSTEMS TO ITS
- ENTIRETY WITHIN THE ROOM. PROVIDE NEW BLANK COVER PLATE, PATCH AND PAINT AROUND COVER PLATE AND ALONG THE REMOVED CONDUIT/RACEWAY ROUTE, NEW FINISH TO MATCH ADJACENT EXISTING WALL CONSTRUCTION. 4. ALL EXISTING CEILING MOUNTED PUBLIC ADDRESS SPEAKERS TO BE REMOVED AND REINSTALLED IN PLACE TO ACCOMODATE NEW CEILING.
- CONTRACTOR TO FIELD TEST FUNCTIONALITY AND REPLACE AS REQUIRED. REFER TO NEW WORK PLAN FOR ADDITIONAL INFORMATION. ALL EXISTING CEILING MOUNTED CIRCULATION FANS TO BE REMOVED AND REINSTALLED IN PLACE TO ACCOMODATE NEW CEILING. CONTRACTOR TO FIELD TEST FUNCTIONALITY AND REPLACE THE ASSOCIATED SWITCH IF REQUIRED. REFER TO NEW WORK PLAN FOR ADDITIONAL INFORMATION.
- 6.^EXÍSTING ÁBANDONED OLD PUBLIC ADDRESS ~~ SYSTEM AND ASSOCIATED CALL BUTTON SWITCH TO BE DEMOLISHED, REMOVE ALL ASSOCIATED WIRING AND SURFACE RACEWAYS BACK TO SOURCE OF SUPPLY. PROVIDE NEW BLANK COVERPLATE AS REQUIRED. PATCH AND PAINT WALL AROUND NEW COVER PLATE AND BEHIND THE RACEWAY ROUTE, NEW FINISH TO MATCH ADJACENT EXISTING WALL CONSTRUCTION. DEMOLISH EXISTING PANELBOARD "LB" AND REPLACE IN PLACE WITH NEW PANELBOARD. CONTRACTOR TO UTILIZE, INTERCEPT AND EXTEND
- ALL EXISTING ACTIVE FEEDER AND BRANCH CIRCUI WIRING/CONDUIT OF THE SAME SIZE VIA NEW JUNCTION BOX OR PULL BOX AND CONNECT IT TO THE NEW PANELBOARD "LB". REFER TO NEW WORK DRAWINGS FOR MORE INFORMATION. B. DEMOLISH EXISTING PANELBOARD "LF" AND REPLACE IN PLACE WITH NEW PANELBOARD. CONTRACTOR TO UTILIZE, INTERCEPT AND EXTEND ALL EXISTING ACTIVE FEEDER AND BRANCH CIRCUIT WIRING/CONDUIT OF THE SAME SIZE VIA NEW JUNCTION BOX OR PULL BOX AND CONNECT IT TO THE NEW PANELBOARD "LF". REFER TO NEW WORK DRAWINGS FOR MORE INFORMATION.

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100% CONSTRUCTION 01/18/2019

1 2/27/19 ADDENDUM #1 NO. DATE REVISION

SCHOOL & LOCATION **MORRIS ELEMENTARY** SCHOOL

2600 W. THOMPSON STREET, PHILADELPHIA, PA 19121

PROJECT TITLE


CLASSROOM **MODERNIZATION**

DRAWING TITLE

ELECTRICAL OVERALL SECOND FLOOR PLAN -**DEMOLITION WORK**

LOCATION NO. FILE NO. CRA NO. 3223 DRAWN BY CHECKED BY B-043C OF 2018 / 19 B-044C OF 2018 / 19 DRAWING NO.

SHEET 3 OF 10

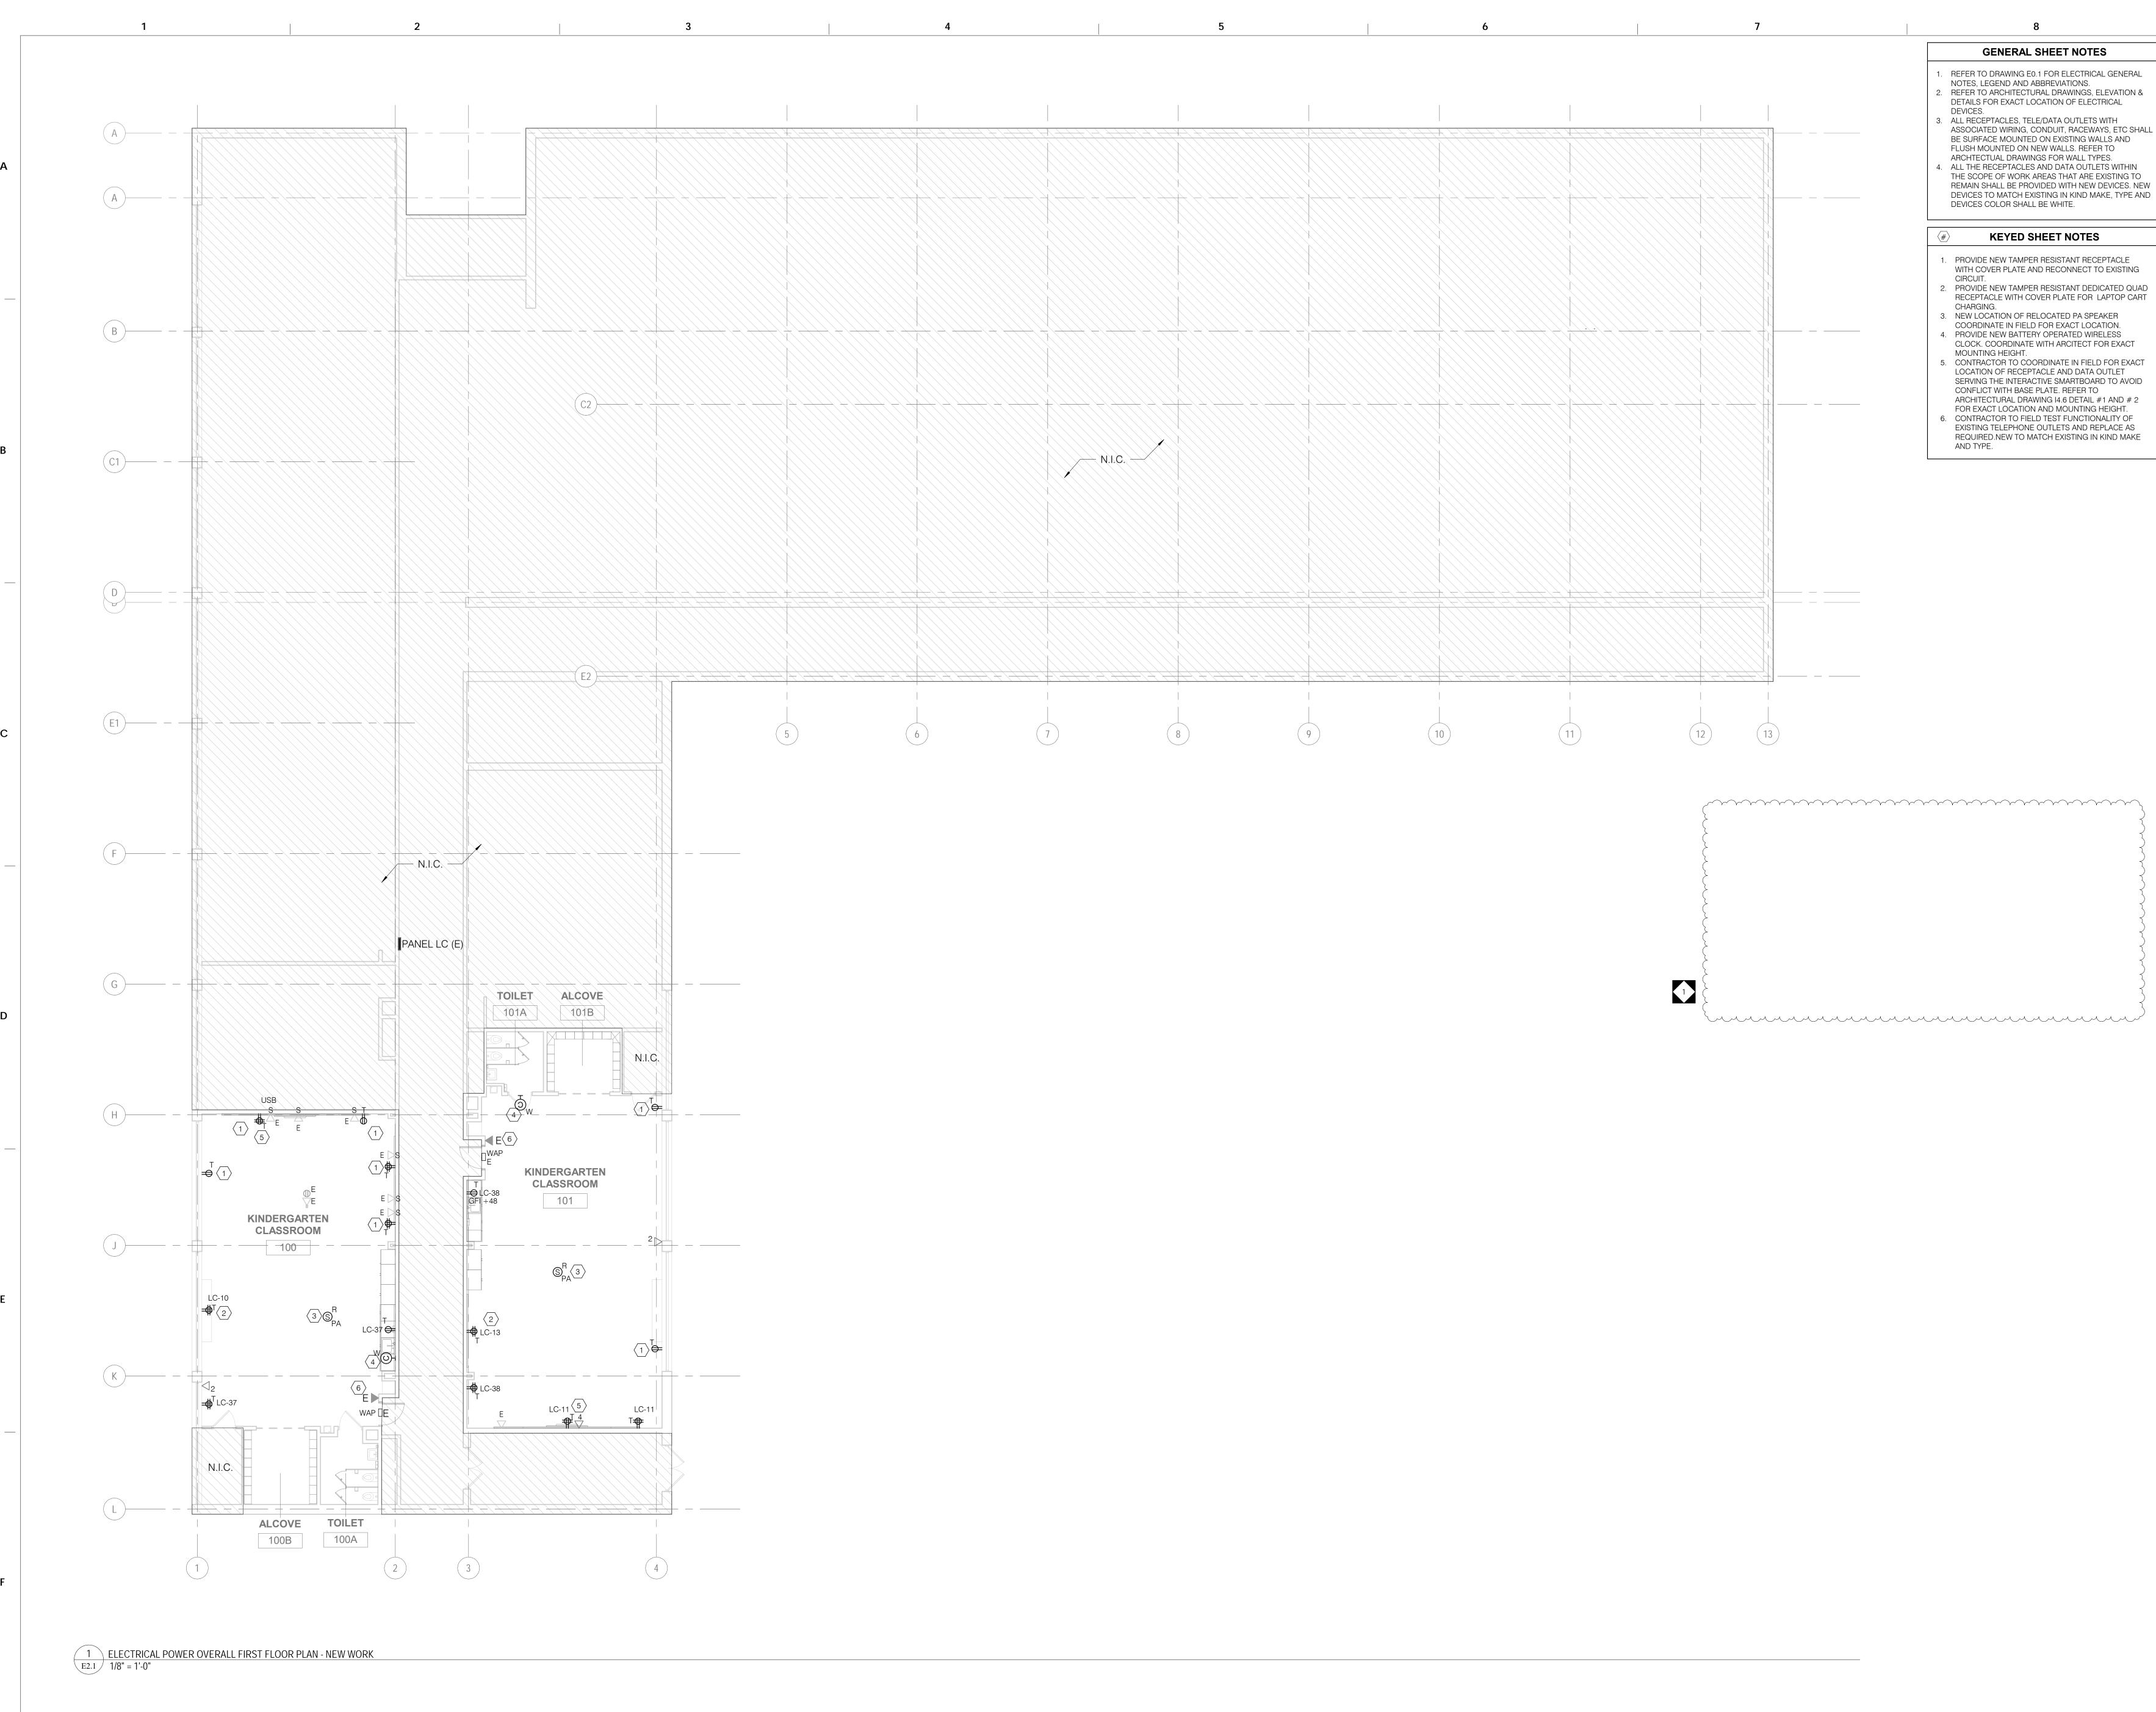

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SCHOOL & LOCATION
MORRIS ELEMENTARY
SCHOOL

2600 W. THOMPSON STREET, PHILADELPHIA, PA 19121

PROJECT TITLE

CLASSROOM MODERNIZATION

DRAWING TITLE

ELECTRICAL OVERALL FIRST FLOOR PLAN - POWER NEW WORK

LOCATION NO.

FILE NO.

CRA NO. 3223

DRAWN BY

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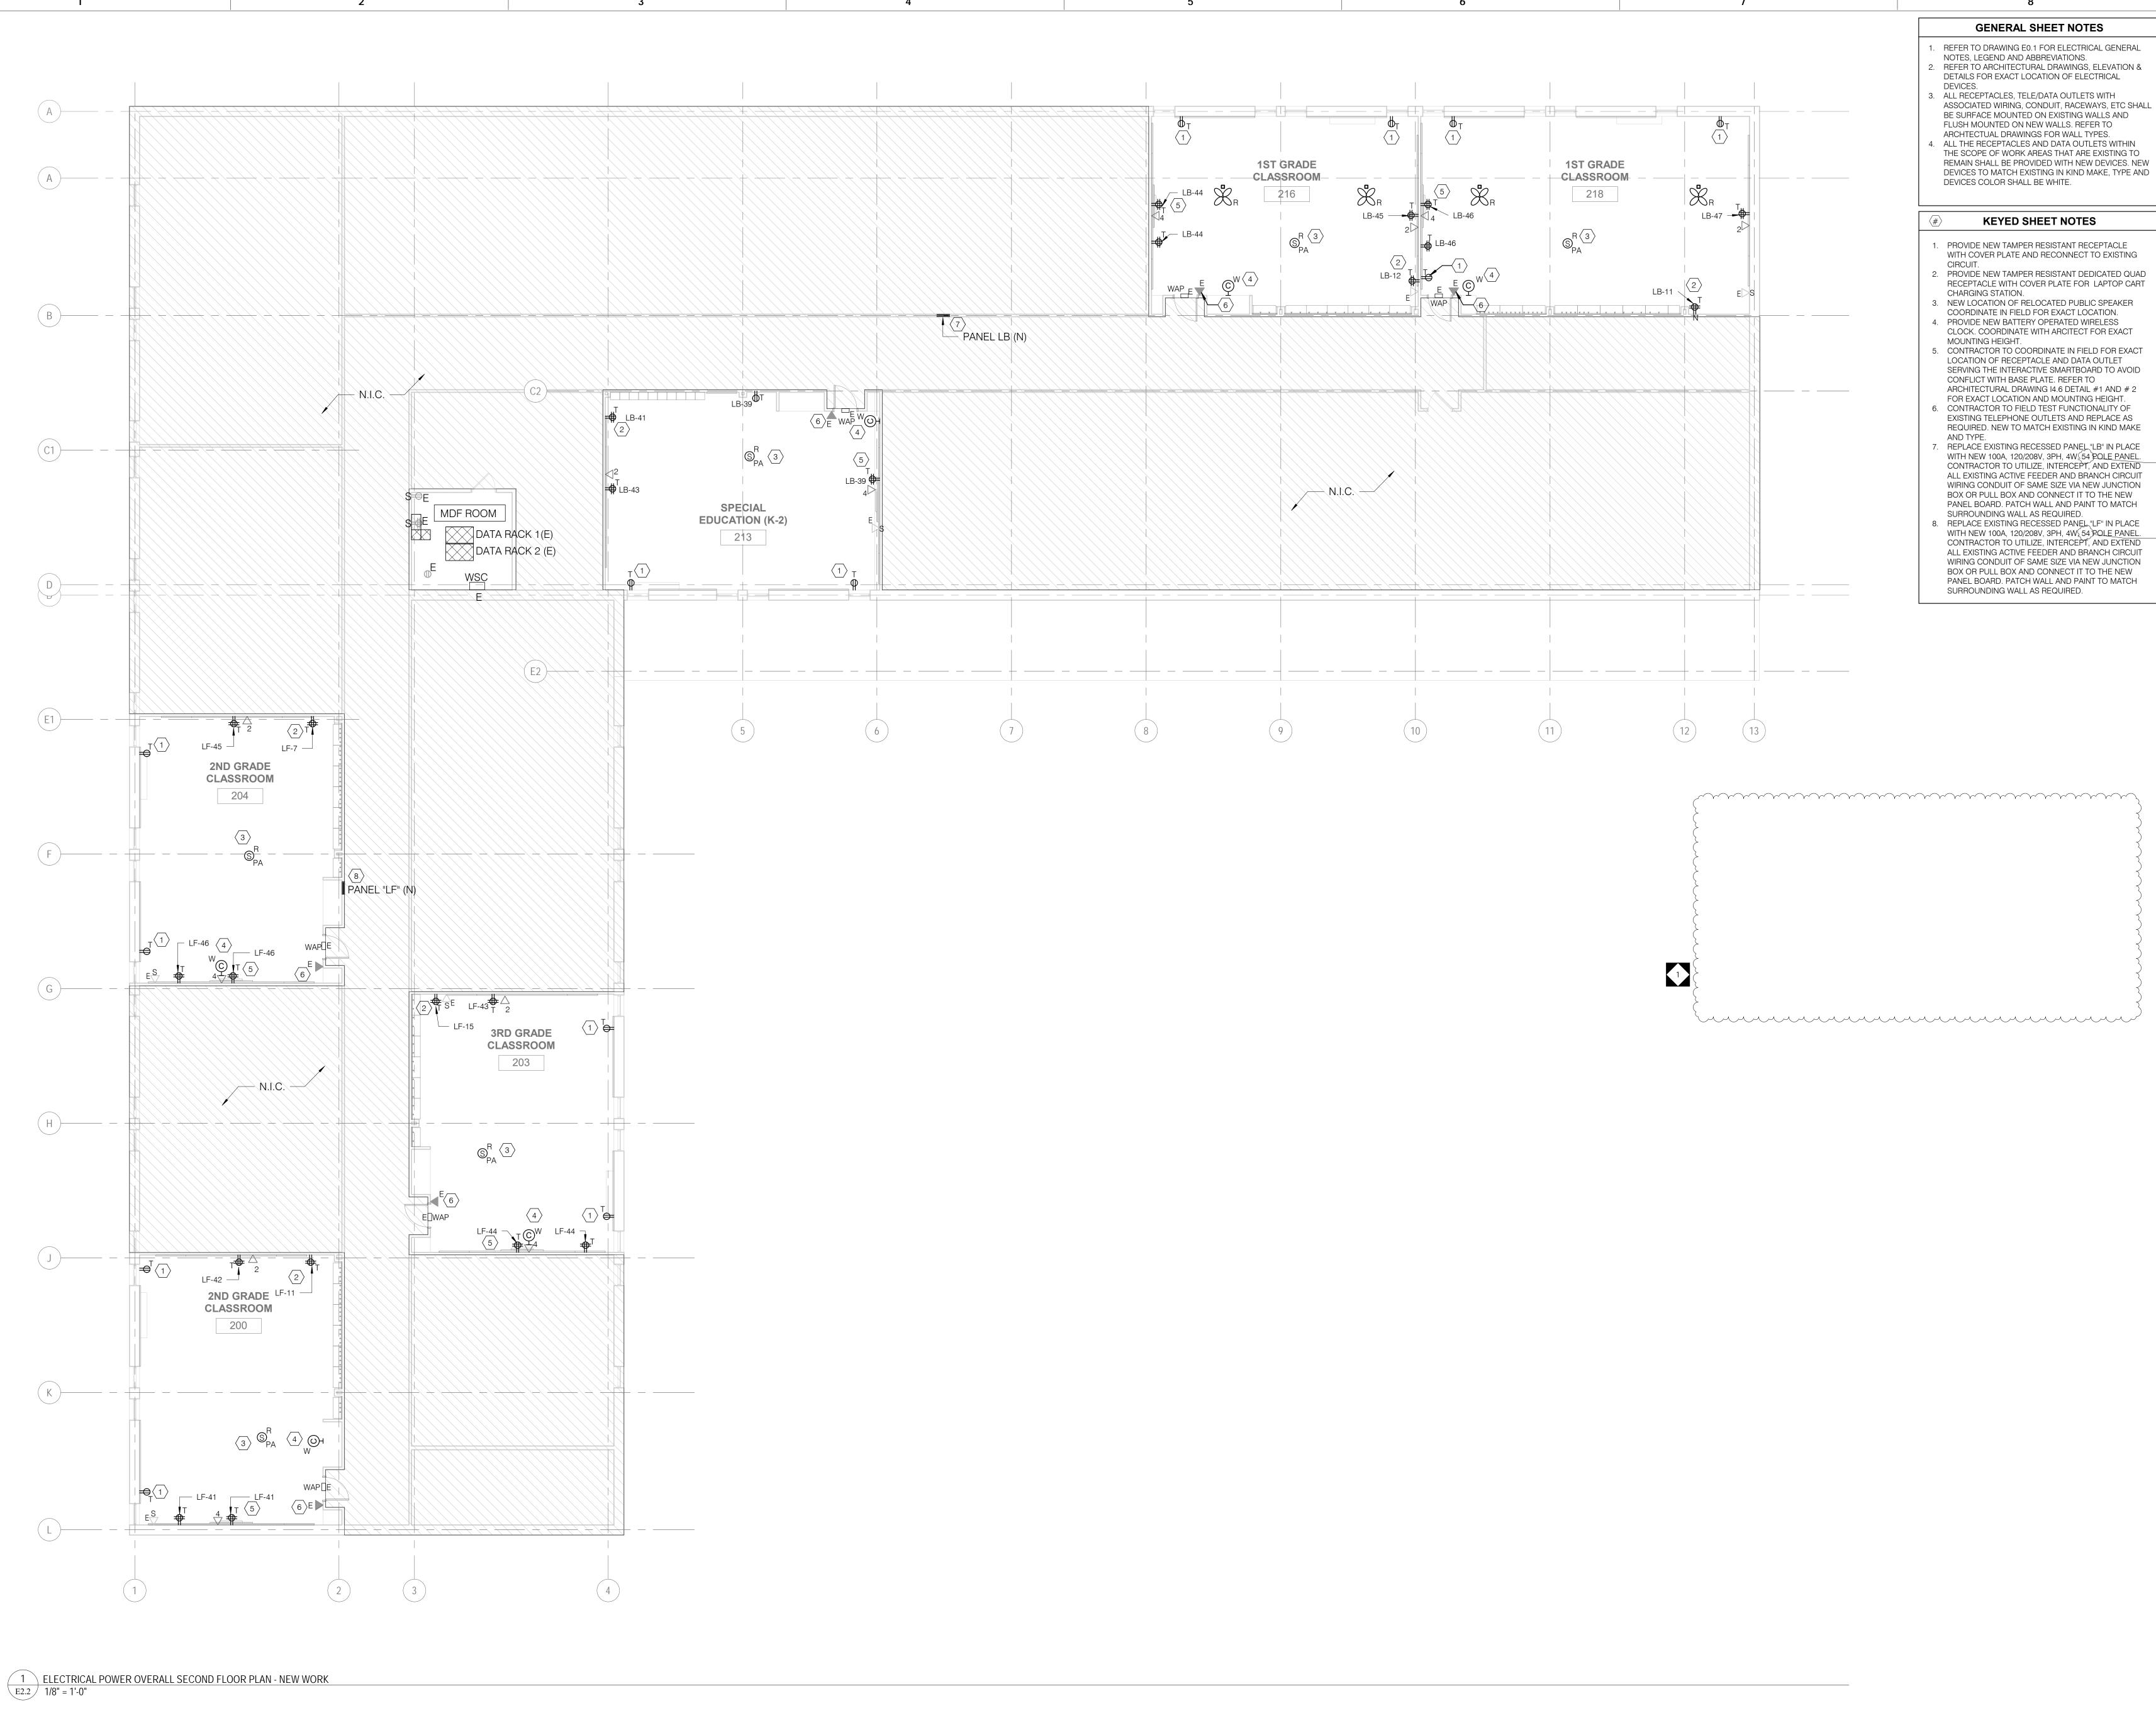
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B-043C

OF 2018 / 19

B-044C

DRAWING NO.



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MORRIS ELEMENTARY
SCHOOL

2600 W. THOMPSON STREET, PHILADELPHIA, PA 19121

PROJECT TITLE

CLASSROOM MODERNIZATION

DRAWING TITLE

ELECTRICAL OVERALL SECOND FLOOR PLAN -POWER NEW WORK

DRAWING NO.

FILE NO.

CRA NO. 3223


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B-043C OF 2018 / 19
B-044C OF 2018 / 19

DRAWING NO.

2

SHEET 7 OF 10

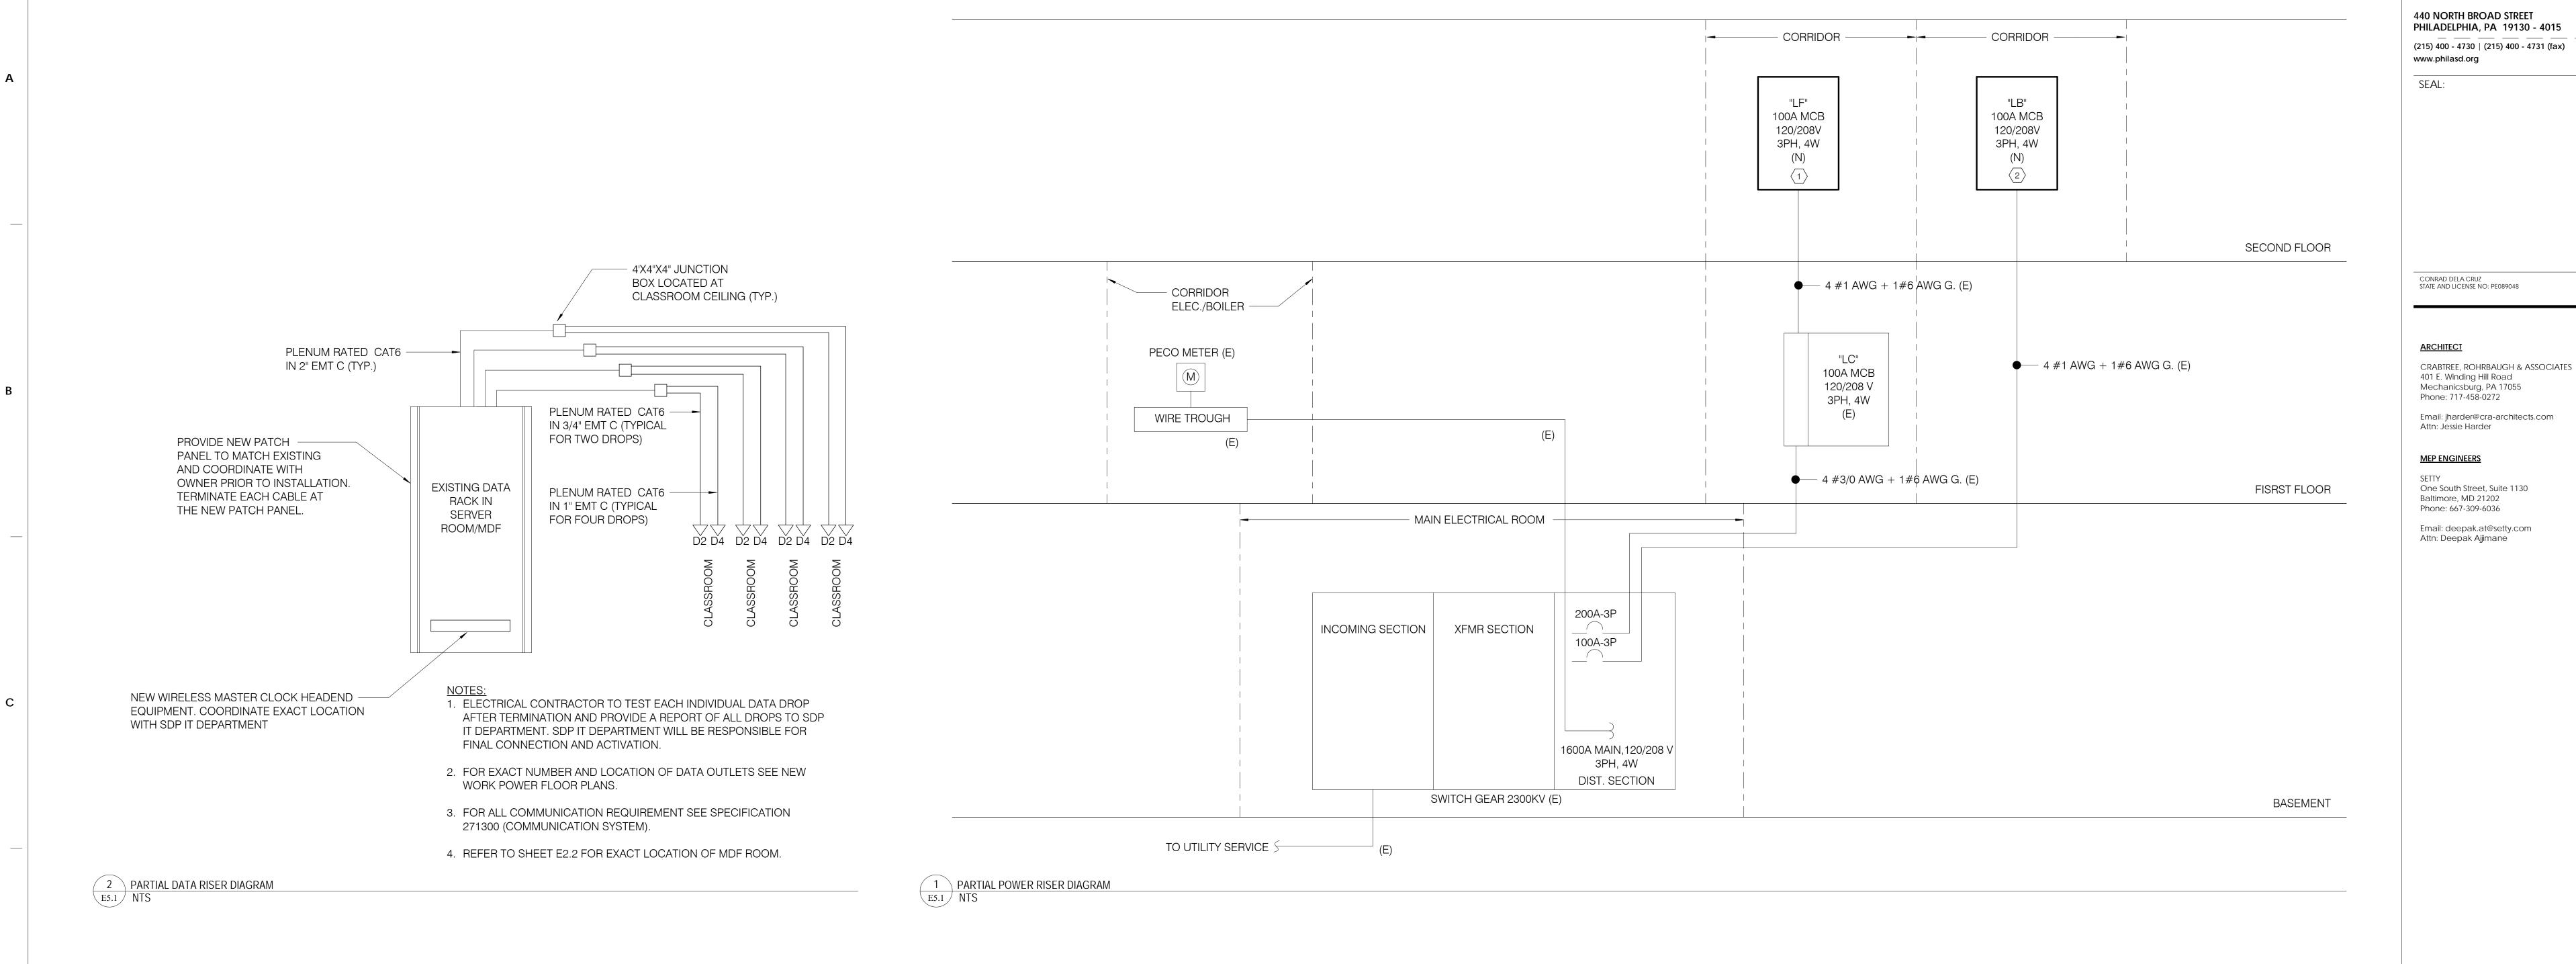

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1 2/27/19 ADDENDUM #1 NO. DATE REVISION

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2600 W. THOMPSON STREET, PHILADELPHIA, PA 19121

PROJECT TITLE

CLASSROOM **MODERNIZATION**

DRAWING TITLE

DRAWING NO.

ELECTRICAL PARTIAL POWER & DATA RISER DIAGRAMS

LOCATION NO. FILE NO. CRA NO. 3223 DRAWN BY CHECKED BY B-043C OF 2018 / 19 B-044C OF 2018 / 19

GENERAL SHEET NOTES

1. REFER TO DRAWING E0.1 FOR ELECTRICAL GENERAL

KEYED SHEET NOTES

1. EXISTING RECESSED BRANCH DISTRIBUTION PANEL "LF" TO BE DEMOLISHED AND REPLACED IN PLACE

CIRCUIT BREAKER RATINGS AND CONFIGURATION OF

ACTIVE BRANCH CIRCUIT WIRING TO RECONNECT TO

EXISTING RECESSED BRANCH DISTRIBUTION PANEL

"LB" TO BE DEMOLISHED AND REPLACED IN PLACE

CIRCUIT BREAKER RATINGS AND CONFIGURATION OF

NEW PANEL TO MATCH EXISTING PANEL. INTERCEPT AND EXTEND ALL ASSOCIATED CONDUITS AND

ACTIVE BRANCH CIRCUIT WIRING TO RECONNECT TO

WITH NEW RECESSED 100A MCB, 120/208V, 3PH, 4W, 54 POLE PANEL. CONTRACTOR TO VERIFY AND MATCH NEW PANEL RATING TO EXISTING. ALL

NEW PANEL TO MATCH EXISTING PANEL. INTERCEPT AND EXTEND ALL ASSOCIATED CONDUITS AND

WITH NEW RECESSED 100A MCB, 120/208V, 3PH, 4W, 54 POLE PANEL. CONTRACTOR TO VERIFY AND

MATCH NEW PANEL RATING TO EXISTING. ALL

NEW PANEL AS REQUIRED.

NEW PANEL AS REQUIRED.

NOTES, LEGEND AND ABBREVIATIONS.

ORIGINAL DRAWING SIZE IS 30"x 42"; SCALE ENTITIES ACCORDINGLY IF REDUCED/ENLARGED

LEGEND

NEW TO BE PROVIDED

EXISTING TO REMAIN

SHEET 8 OF 10

			BERT MORRIS ES CLASSROOM MODERI					DUACE	- 0 144-	AGE:			20/208				AIC RATING:		10k			
	L:							PHASE					PH, 4\				MOUNTING:	RE	CES	SSE		
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CKT	OCE					OAD (KV			3 PH	SEQUE	NCE			DAD (KV	·			OCI				
NO.	Α	Р	DESCRIPTION	MISC	HWH	HVAC	REC	LTG	Α	В	С	MISC	HWH	HVAC	REC	LTG	DESCRIPTION	Α	Р	N		
1	20		LTS. RM. 210 (E)					0.8	1.6							0.8	LTS. RM. 212 (E)	20	1			
3	20	1	TELEPHONE SYSTEM (E)	0.6						1.4						0.8	LTS. RM. 212 (E)	20	1	\perp		
5	20	1	LTS. RM. 214 (E)					0.8			1.6					0.8	LTS. RM. 216 (E)	20	1	\perp		
7	20	1	LTS. RM. 214 (E)					0.8	0.8								2	20	1	1		
9	20	1	LTS. RM. 218 (E)					0.6		1.2						0.6	LTS. RM. 213 (E)	20	1			
11	20	1	REC. FOR LAPTOP CHARGING RM. 218 2				0.8				1.6					0.8	REC. FOR LAPTOP CHARGING RM. 216 2	20	1			
13	20	1	LTS. STRG. RM. HOME ECON. (E)					0.8	1.6							0.8	LTS. STRG. RM. 209, MENS RM. (E)	20	1			
15	20	1	LTS. RM . 215 (E)					0.8		1.6						0.8	LTS. RM. 217 (E)	20	1			
17	20	1	LTS. RM. 215 (E)					0.8			1.6					0.8	LTS. RM. 219 (E)	20	1			
19	20	1	REC. RM. 210 & 212 (E)				0.6		1.2						0.6		REC. RM. 219 (E)	20	1			
21	20	1	REC. RM. 214 & 216 (E)				0.6			1.2					0.6		REC. RMS. 209, 213 & MENS RM (E)	20	1			
23	20	1	REC. RM. 218 (E)				0.6				1.2				0.6		REC. RM. 217 (E)	20	1			
25	20	1	REC. CORRIDOR (E)				0.6		1.2						0.6		REC. RM. 219 (E)	20	1			
27	20	1	REC. RM. 219 FOR IRONS (E)				0.6			1.2					0.6		REC. RM. 219 (E)	20	1			
29	20	1	REC. RM. 219 FOR IRONS (E)				0.6				0.6						BUSSED SPACE	•	2			
31	20	1	REC. RM. 219 FOR WASHER (E)				0.6		1.2						0.6		REC. 219 BACK SPLASH (E)	20	1			
33	20	1	EXISTING LOAD	0.6						1.2		0.6					EXISTING LOAD	20	1			
35	20	1	EXISTING LOAD	0.6							1.2	0.6					EXISTING LOAD	20	1			
37	20	1	LTS. RM. 210 (E)					0.8	1.6							0.8	LTS. RM. 215 (E)	20	1			
39	20	1	REC. RM. 213				0.6			2.4				1.8			AC MDF (E)	30	2			
41	20	1	REC. FOR LAPTOP CHARGING RM. 213				0.8				2.6			1.8			-					
43	20	1	REC. RM. 213				0.4		1.2						0.8		REC. RM. 216	20	1			
45	20	1	REC. RM. 216				0.4			1.2					0.8		REC. RM. 218	20	1			
47	20	1	REC. RM. 218				0.4				0.4						SPARE	20	1			
49			BUSSED SPACE						0.0								BUSSED SPACE	130	-			
51	-	-	BUSSED SPACE							0.0							BUSSED SPACE	-	-			
53		-	BUSSED SPACE								0.0						BUSSED SPACE	(4)	-			
CONN	ECTED	LOAD	(KVA)	1.8	0.0	0.0	7.6	6.2	10.4	11.4	10.8	1.2	0.0	3.6	5.2	7.0						
25% O	F LAR	GESTI	MOTOR (KVA)																			
TOTAL	CONN	ECTE	D LOAD (KVA)	3.0	0.0	3.6	12.8	13.2														
DEMA	ND FA	CTOR		1.0	1.25	1.0	Х	1.25									TOTAL DEMAND (KVA)	35				
TOTAL	DEMA	ND LC	AD (KVA)	3.0	0.0	3.6	11.4	16.5									LINE CURRENT (AMPS)	96				

MIN. I. B. PLANE P	DJECT: R	OBERT MORRIS ES CLASSROOM MODER	NIZATION			L VOLTAG		1:	20/208V		AIC RATING:		10K		- Constitution 22	OBERT MORRIS ES CLASSROOM MODER	RNIZATION			PANEL VOL			120/208V		AIC RATING:	1
Property of the content of the con	NEL: LI	B (N) 1			PHAS	E & WRE:	:	3	PH, 4W		MOUNTING:	REC	CESSE	ED		,			P	PHASE & W	IRE:		3PH, 4W		MOUNTING:	RECE
	ATION FI	RST FLOOR CORRIDOR			BUS/N	AIN (AMF	PS):	10	00A MCB		NEMA TYPE:	20	1		LOCATION F	RST FLOOR CORRIDOR			E	BUS/MAIN (AMPS):		100A MCB		NEMA TYPE:	
No. 1 1 1 1 1 1 1 1 1	OCD			LOAD (KVA	N)	3 PH SI	EQUENCE	E	LOAD (KV	/A)		OCD	CI	кт	CKT OCD				(27/1)			E	LOAD	(KVA)		OCD
1	A	DESCRIPTION	MISC HWH	HVAC	REC LTG	A	В	C MISC	HWH HVAC	REC	LTG DESCRIPTION	A	P N	10.	NO. A	DESCRIPTION	MISC H	WH HVAC	REC	LTG A	В	C MI	SC HWH H	VAC REC	LTG DESCRIPTION	A
1 15 15 15 15 15 15 15	20	1 LTS. RM. 210 (E)			0.8	1.6					0.8 LTS. RM. 212 (E)	20	1	2	1 20	LTS. RM. 208 (E)				0.8 1.6					0.8 LTS. RM. 206 (E)	20
2 1 15 MIN PROPORTION NOT NOT NOT NOT NOT NOT NOT NOT NOT N	20	1 TELEPHONE SYSTEM (E)	0.6				1.4				0.8 LTS. RM. 212 (E)	20	1	4	3 20	I LTS. RM. 208 (E)				0.8	1.6				0.8 LTS. RM. 206 (E)	20
1	20	1 LTS. RM. 214 (E)			0.8		1	.6			0.8 LTS. RM. 216 (E)	20	1	6						0.6	1	.4			0.8 LTS. RM. 202 (E)	20
S 2 1 5 1 5 1 5 1 5 1 5 1 5 1 5 1 5 1 5 1	20	1 LTS. RM. 214 (E)			0.8	0.8						2 20	1	8	7 20	REC. FOR LAPTOP CHARGING RM. 204			0.8	1.6					0.8 LTS. RM. 202 (E)	20
1 1 1 5 1 5 1 5 1 5 1 5 1 5 1 5 1 5 1 5	20	1 LTS. RM. 218 (E)			0.6		1.2				0.6 LTS. RM. 213 (E)	20	1	10	(-2.)					0.6	1.4				0.8 LTS. RM. 201 (E)	20
1 1 1 1 1 1 1 1 1 1	20	REC. FOR LAPTOP CHARGING RM. 218 2			0.8		1	.6			0.8 REC. FOR LAPTOP CHARGING RM. 216	2 20	1	12	11 20	REC. FOR LAPTOP CHARGING RM. 200 2			0.8		1	.6			0.8 LTS. RM. 201 (E)	20
1 1 1 1 1 1 1 1 1 1	20	1 LTS. STRG. RM. HOME ECON. (E)			0.8	1.6					0.8 LTS. STRG. RM. 209, MENS RM. (E)	20	1	14	13 20	1 LTS. RM. 203				0.6 1.4					0.8 LTS. GIRLS & BOYS RMS.	20
1 1 1 1 1 1 1 1 1 1	20	1 LTS. RM. 215 (E)			0.8		1.6				0.8 LTS. RM. 217 (E)	20	1	16	15 20	REC. FOR LAPTOP CHARGING RM. 203			0.8		1.6				0.8 LTS. WOMENS' RM. & PIPE CH.	20
1 1 1 1 1 1 1 1 1 1	20	1 LTS. RM. 215 (E)		1 1	0.8		1	.6			0.8 LTS. RM. 219 (E)	20	1	18						0.8	1	.4		0.6	REC. RM. 202 & 204 (E)	20
1 1 1 1 1 1 1 1 1 1	20	1 REC. RM. 210 & 212 (E)			0.6	1.2				0.6	REC. RM. 219 (E)	20	1	20	19 20	EXISTING LOAD	0.6			1.2				0.6	REC. RMS. 200 & 202 (E)	20
3 1 SEC. MR.2016 1 1 1 1 1 1 1 1 1	20	1 REC. RM. 214 & 216 (E)			0.6		1.2			0.6	REC. RMS. 209, 213 & MENS RM (E)	20	1	22	21 20	REC. RMS. 201 & 203 (E)			0.6		1.2			0.6	REC. RMS. 206 & 208 (E)	20
2 1 1 SECONOMICAGE		1 REC. RM. 218 (E)			0.6		1	.2		0.6	REC. RM. 217 (E)	20		_	23 20	REC. CORRIDOR (E)			0.6		1	.2 0	.6		EXISTING LOAD	20
2 1 1 1 2 2 3 3 3 3 3 3 3 3	20	1 REC. CORRIDOR (E)			0.6	1.2				0.6	REC. RM. 219 (E)	20	1	26	25 20	I EXISTING LOAD	0.6			1.2		0	.6		EXISTING LOAD	20
2 St. Ref. No. 21 Sec. 21 Sec. No. 21 S	_				0.6		1.2				Alternative Adv	20	1	28	27 20	1 EXISTING LOAD	0.6				1.2	0	.6		EXISTING LOAD	20
20	_				0.6			0.6		07000		-	_	_	29 20	1 EXISTING LOAD	0.6				1	.2 0	.6		EXISTING LOAD	20
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1 1 1 1 1 1 1 1 1 1 1 1 1 1 1 1 1 1 1	_		0.6				-	2 0.6				20	1	36			0.6				7	.2 0	.6			20
2 1 RC, MR, 213 2 1 RC,		TO THE PARTY OF TH			0.8	1.6					And the Control of th	20	1	38	1000	A LL PROMINGIAN ARCHITECTURE	0.6	1		1.2					EXISTING LOAD	20
20 1 RC. RM. 273 20 1 R		ACT DOCUMENT CONTROL OF CONTROL		+ +	87893	2380	24		1.8		PLANTA DESCRIPTION NOT A PROPERTY OF THE PROPE	30		0.000			0.6	-				0	.6		EXISTING LOAD	20
20 1 REC.RM. 213	1990				17.75			26				-	170					_	0.8			_		0.4		20
2 1 RC RM 216						12			1.0	0.8		20						+	7,540,000	1.2				1 100000		20
2 1 RC.RM.218		97 - 5/15C 93/7 3 155/15C		+ +	DOMEST .	1.2	12			0.000	Opening and in the second of t	1.545		7.00		2.1		+	5557				_			20
- BUSSED SPACE	2000/R0 2			+	-FE32			14		0.0	Historica Carlotte	176	1,772	ATTENDED				-	0.1			0.0	+ +	0.0		20
Subset S	20			+ -	0.4	0.0	0	.4				20	-			200 - 200 -				0.0		,.0				- 20
BUSSED SPACE BUSSED SPACE BUSSED SPACE BUSSED SPACE CONNECTED LOAD (KVA) BUSSED SPACE CONNECTED LOAD (KVA) BUSSED SPACE BUSSED SPACE CONNECTED LOAD (KVA) BUSSED SPA		Section Control County Control				, and a second	00				2004 140 000000 00000 00000 00000 		13.65	(2000)		1 1 1 1 1 1 1 1 1 1 1 1 1 1 1 1 1 1 1 1		-	-	0.0		-	-	-	Estate and Composition Composi	- - - - - - - - - -
ECTED LOAD (KVA) 18 0 0 0 0 7.6 62 10.4 11.4 10.8 12 0 0 3.6 5.2 7.0 F LARGEST MOTOR (KVA) 19 0 0 0 7.6 62 10.4 11.4 10.8 12 0 0 3.6 5.2 7.0 CONNECTED LOAD (KVA) 10 0 0 0 7.6 62 10.4 11.4 10.8 12 0 0 3.6 5.2 7.0 CONNECTED LOAD (KVA) 10 0 0 0 0 0 0 0 0 0 0 0 0 0 0 0 0 0 0	-			-			1000000				0.0000000000000000000000000000000000000	-						_	\vdash	-	0.0	10		-		
F LARGEST MOTOR (KVA) CONNECTED LOAD (KVA) 25% OF LARGEST MOTOR (KVA)			40 00		70 00	10.1			20 20			-	-	54			54	0 00	11	42 406			4 00 0	10 22		
CONNECTED LOAD (KVA) 3.0			1.8 0.0	0.0	7.6 6.2	10.4	11.4	0.8 1.2	0.0 3.6	5.2	7.0					***************************************	5.4	0.0	4.4	4.2 10.0	10.0	1.2 3	.4 0.0 0	0.0 2.2	0.4	
FACTOR 1.0 1.25 1.0 X	LARGES	ST MOTOR (KVA)				-									25% OF LARGI	ST MOTOR (KVA)	1	_	\vdash							
D FACTOR 1.0 1.25 1.0 X 1.25 1.0			12/12/2			-											40.0			10.0						
DEMAND LOAD (KVA) 3.0 0.0 3.6 11.4 16.5 LINE CURRENT (AMPS) 5.0 0.0 0.0 6.6 13.3 LINE CURRENT (AMPS) 5.0 0.0 0.0 6.6 13.3 LINE CURRENT (AMPS) 5.0 0.0 0.0 6.6 13.3 5.0 0.0 0.0 0.0 0.0 0.0 0.0 0.0 0.0 0.0		1. 50	3.0 0.0	3.6	12.8 13.2	-										1/1			-							20
10KVA @ 100%, + REMAINDER @ 50% (N.E.C. 220-44) X= 1ST 10KVA @ 100%, + REMAINDER @ 50% (N.E.C. 220-44) HWH - HOT WATER HEATER						1					The second secon	35			ISTORES PROPERTY AND CO		1.0 1	.25 1.0	Х	1.25					SUBSECTION CLEVES OF A MESSAGE	31
			3.0 0.0	3.6	11.4 16.5						10 1 2 1 1 1 1 1 1 1 1 1 1 1 1 1 1 1 1 1	96		_			10.8	0.0	6.6	13.3						85
NEW REPLACEMENT PANEL: FIELD COORDINATE FOR EXACT SIZES OF ALL EXISTING BREAKERS 2 SPARE CIRCUIT MADE AVAILABLE AFTER DEMOLITION 2 SPARE CIRCUIT MADE AVAILABLE AFTER DEMOLITION		70 (10 20 - 10 1) (10 10 10 10 10 10 10 10 10 10 10 10 10 1																				Г	<u></u>			
	NEW RE	PLACEMENT PANEL: FIELD COORDINATE FOR EXACT SIZ	ES OF ALL EXISTING	G BREAKE	RS					2	SPARE CIRCUIT MADE AVAILABLE AFTER DEMOLIT	ION			1 NEW R	PLACEMENT PANEL: FIELD COORDINATE FOR EXACT SIZ	ZES OF ALL EXIS	ING BREAKE	:RS				2 SPARE CIF	RCUIT MADE	AVAILABLE AFTER DEMOLITION	
															DRO JECT: 1	OBERT MORRIS ES CLASSROOM MODER	MUZATION			ANEL VOL	TACE		120/208V		AIC RATING:	

PRO.	ECT:	ROE	BERT MORRIS ES CLASSROOM MODERNIZA	NOITA				PANEL	VOLT	AGE:		1:	20/208	3V			AIC RATING:		10K	
PANE	L:	LC (E)					PHASE	& WIR	E:		3	PH, 4\	N			MOUNTING:	RE	CES	SED
OC	TION	FIRS	T FLOOR CORRIDOR					BUS/M	AIN (AI	MPS):		10	OA MO	СВ			NEMA TYPE:		1	
CKT	OCD)			L	OAD (KV	A)		3 PH	SEQUE	NCE		L	OAD (KV	A)			OCE)	СКТ
NO.	Α	Р	DESCRIPTION	MISC	HWH	HVAC	REC	LTG	Α	В	С	MISC	HWH	HVAC	REC	LTG	DESCRIPTION	Α	Р	NO.
1	20	1	LTS. PRINC. OFFICE AND BATH (E)					0.8	1.6							0.8	LTS. ADM. & CAUN. OFFICE (E)	20	1	2
3	20	1	LTS. MENS & WOMENS TOILET (E)					0.8		1.6						0.8	LTS. OFFICE (E)	20	1	4
5	20	1	LTS. MEDICAL RM. (E)					0.8			1.6					0.8	LTS. OFFICE & SHOW CASE (E)	20	1	6
7	20	1	LTS. CONFERENCE RM. (E)					0.8	1.7							0.9	LTS. RM. 100 (E)	20	1	8
9	20	1	LTS. RM. 101 (E)					0.9		1.7					0.8		REC. FOR LAPTOP CHARGING RM. 100	20	1	10
11	20	1	LTS. RM. 101 STORAGE (E)					0.1			0.2					0.1	LTS. RM. 100 STORAGE (E)	20	1	12
13	20	1	REC. FOR LAPTOP CHARGING RM. 101				0.8		1.6							0.8	LTS. STORAGE RM. & JAN. RM (E)	20	1	14
15	20	1	LTS. 1ST FLOOR CORRIDOR (E)					0.8		1.6						0.8	LTS. GIRLS RM. (E)	20	1	16
17	20	1	REC. CORNER MAIN OFFICE (E)				0.6				1.4		.,.			0.8	LTS. 1ST FLOOR CORRIDOR (E)	20	1	18
19	20	1	PRINCIPAL OFFICE REC. (E)				0.6		1.4			0.8					EXISTING LOAD	20	1	20
21	20	1	STORAGE (E)	0.8						1.4					0.6		FAN OUTLETS (E)	20	1	22
23	20	1	EXISTING LOAD	0.8							1.4				0.6		REC. CORRIDOR (E)	20	1	24
25	20	1	EXISTING LOAD	0.8					1.4						0.6		REC. OFFICE & STORAGE RM. (E)	20	1	26
27	20	1	REC. OFFICE & INFIRMARY (E)				0.6			1.2					0.6		REC. OFFICE (E)	20	1	28
29	20	1	REC. CONF. RM. & RM. 100 (E)				0.6				1.2				0.6		REC. FLOR INFRIM. COUNC. ASSIST. ADMIN. OFFICE (E)	20	1	30
31	20	1	REC. RM. 101 (E)				0.6		1.2						0.6		REC. FLOOR, OFFICE, PRINC. (E)	20	1	32
33	20	1	REC. WATER COOLER (E)				0.6			1.4		0.8					EXISTING LOAD	20	1	34
35	20	1	COMP. REC. MAIN OFFCE (E)				0.6				1.4				0.8		REC. MAIL BINS - MAIN OFFICE (E)	20	1	36
37	20	1	REC. RM. 100 2				0.6		1.2						0.6		REC. RM. 101 2	20	1	38
39			BUSSED SPACE							0.0			68				BUSSED SPACE	-	-	40
41	-	-	BUSSED SPACE								0.0						BUSSED SPACE	-	12	42
ONN	ECTED	LOAD	(KVA)	2.4	0.0	0.0	5.6	5.0	10.1	8.9	7.2	1.6	0.0	0.0	5.8	5.8				
5% C	LAR	GESTI	MOTOR (KVA)									124		80						
OTAL	CONN	ECTE	D LOAD (KVA)	4.0	0.0	0.0	11.4	10.8												
EMA	ID FAC	CTOR		1.0	1.25	1.0	Х	1.25									TOTAL DEMAND (KVA)	28		
OTAL	DEMA	ND LC	DAD (KVA)	4.0	0.0	0.0	10.7	13.5									LINE CURRENT (AMPS)	78		
= 18	10KV	A @ 10	0%, + REMAINDER @ 50% (N.E.C. 220-44)														HWH - HOT WATER HEATER			
1	SPAR	E CIR	CUIT MADE AVAILABLE AFTER DEMOLITION									2	PROVID	DE NEW	CIRCUI	TBREA	KER			

OFFICE OF CAPITAL PROGRAMS

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100% CONSTRUCTION 01/18/2019

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1	2/27/19	ADDENDUM #1
NO.	DATE	REVISION

SCHOOL & LOCATION **MORRIS ELEMENTARY** SCHOOL

2600 W. THOMPSON STREET, PHILADELPHIA, PA 19121

PROJECT TITLE

CLASSROOM **MODERNIZATION**

DRAWING TITLE

ELECTRICAL PANEL SCHEDULES

LOCATION NO.		E NO. A NO. 3223
DRAWN BY	CH	IECKED BY
NS	DA	T
B-043C	OF	2018 / 19
B-044C	OF	2018 / 19
DRAWING NO.		

SHEET 9 OF 10

NEW PANEL BOARDS.

PANEL BOARD SCHEDULE NOTES

TURN ALL SPARE CIRCUIT BREAKERS TO "OFF" POSITION AT COMPLETION OF WORK.

PROVIDE TYPED SCHEDULE FOR PANEL BOARDS
 UTILIZED AT COMPLETION OF PROJECT INDICATING
 ACTUAL AS-BUILT CONDITIONS.
 NEW CIRCUIT BREAKER (IF PROVIDED) MUST BE

THE ACTUAL CIRCUIT NUMBERS MAY BE DIFFERENT

PROVIDE ARC FLASH WARNING LABELS FOR ALL

COMPATIBLE WITH EXISTING PANELBOARD (UL LISTED, MANUFACTURED BY THE PANELBOARD MANUFACTURER AND WHICH HAVE AN AIC RATING

TO MATCH THE EXISTING PANEL RATING). 4. ALL SPARE CIRCUIT BREAKERS NUMBER MADE AVAILABLE AFTER DEMOLITION ARE BASED ON THE EXISTING DOCUMENTS AND MAY BE INACCURATE.

AND SHALL BE VERIFIED IN FIELD DURING

ORIGINAL DRAWING SIZE IS 30"x 42"; SCALE ENTITIES ACCORDINGLY IF REDUCED/ENLARGED

CONSTRUCTION.

KEY PANELS

"LB" "LF" "LC"

2/27/2019 5:32:53 PM C:\Users\Nicole.serafin\Documents\3223_Electrical Link - Morris_Nicole.Serafin.rvt