THE SCHOOL DISTRICT OF PHILADLPHIA SCHOOL REFORM COMMISSION

Office of Capital Programs 440 North Broad Street, 3rd Floor – Suite 371 Philadelphia, PA 19130

TELEPHONE: (215) 400-4730

Addendum No. 03

Subject: Camelot Academy – Generator Replacement

SDP Contract No. B-036C of 2018/19

Location: Camelot Academy

1435 N. 26th Street

Philadelphia, Pennsylvania 19121

This Addendum, dated September 18, 2019, shall modify and become part of the Contract Documents for the work of this project. Any items not mentioned herein, or affected by, shall be performed strictly in accordance with the original documents.

Pre-Bid RFI Questions and Responses:

1. Drawing E-501 Detail #10. Please confirm that re-bar is required in the duct bank

Response – Duct bank is no long required, these details have been removed.

2. Drawing E-501 Detail #4. Please confirm that this footer detail is not required on this project.

Response – As per drawings E-501 Detail #4, the footer detail for each fence post is required.

3. Drawing E-501 Detail #1 and Detail #5. Detail #1 states that metal fence post shall be grounded. Detail #5 states that each corner ground post shall be grounded. Please confirm the number of fence post to be grounded.

Response – As per drawings E-101 and E-501, fence post grounding is required. The EC's fencing contractor shall determine the exact quantity of fence posts. Assume a minimum of (8) metal fence post will be required as per drawing E-501 Detail #1.

Drawing Revisions:

Please note, a complete conformed drawing set has been issued with the following revisions noted below.

E001 - No revisions

ED100 - No revisions

ED101 - No revisions

E100 - No revisions


E101 – Generator location has been moved closer to the building. Duct bank has been removed, all exterior conduit shall be surface mounted. Quantity of bollards have been reduced.

E501 – Duct bank details have been removed.

E601 – No revisions

End of Addendum No. 03.

POWER

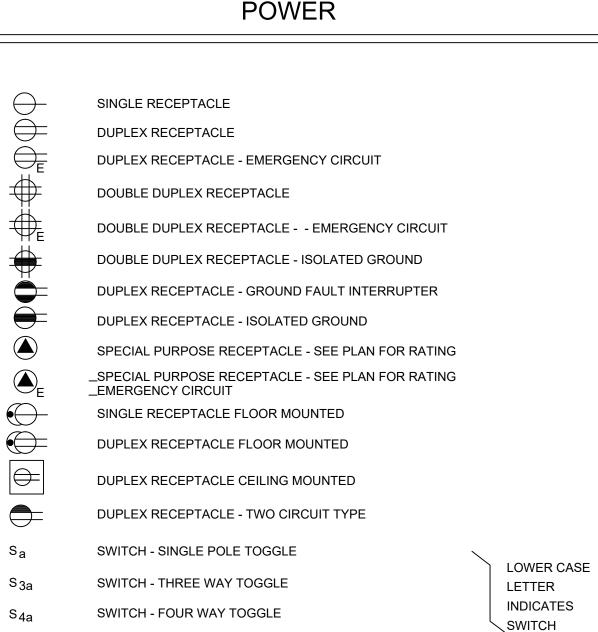

SWITCH - DIMMER SWITCH - TIMER SWITCH - SINGLE POLE TOGGLE LIGHTED FRACTIONAL HORSEPOWER MANUAL MOTOR STARTER WITH OVERLOADS FOR MOTOR ("P" INDICATES PILOT LIGHT) CEILING MOUNTED DUAL TECHNOLOGY OCCUPANCY SENSOR WALL MOUNTED DUAL TECHNOLOGY OCCUPANCY SENSOR DISCONNECT SWITCH - NONFUSED DISCONNECT SWITCH - FUSED MOTOR STARTER - COMBINATION TYPE C/B WITH CIRCUIT SIZE AND BREAKER, F = FUSED SWITCH, NF = NONFUSED No. OF DISCONNECT SWITCH POLES INDICATED ENCLOSED CIRCUIT BREAKER TYPE DISCONNECT SWITCH ON PLANS

REFERENCE

AT LIGHT FIXTURE

ON PLAN

MANUAL MOTOR STARTER (1HP AND ABOVE) ("P" INDICATES PILOT LIGHT) MAGNETIC CONTACTOR OR MOTOR STARTER W=WALL PHONE TELEPHONE OUTLET FLUSH MOUNTED P=PAY PHONE H=HOUSE PHONE

SWITCH - SINGLE POLE AND PILOT

SWITCH - SINGLE POLE TOGGLE KEY OPERATED

LIGHT COMBINATION

DOUBLE COMPUTER OUTLET FLUSH MOUNTED DOUBLE DATA/COMMUNICATIONS OUTLET

TELEVISION OUTLET (CATV, MATV, SATV) AS INDICATED PUSH-BUTTON STATION SINGLE

LIGHTING OR POWER PANEL

DISTRIBUTION PANEL - 277/480V

- HT - HT - HEAT TRACE CONDUIT HOMERUN ARROW INDICATES CONDUIT AND WIRE TO BE RUN TO PANEL AS INDICATED (AMOUNT OF ARROWHEADS = AMOUNT OF CIRCUITS) PHOTO ELECTRIC CELL

> CLOCK OUTLET WALL MOUNTED JUNCTION BOX - SIZE AS REQUIRED

TRANSFORMER - SIZE AS INDICATED ON PLAN TIME CLOCK

MECHANICAL/ELECTRICAL

ELECTRIC HEATER DUCT TYPE PRESSURE SWITCH FCU FAN COIL UNIT UNIT HEATER - ELECTRIC UNIT HEATER - HOT WATER OR STEAM MECHANICAL TO SPECIFY TYPE -WATTAGE WITH/OR WITHOUT THERMOSTAT O— BB — ELECTRIC BASEBOARD HEATER **ELECTRIC MOTOR**

FIRE ALARM

FLOW SWITCH

TAMPER SWITCH

-	FIRE ALARM - VISUAL LIGHT - WALL MOUNTED
O -	FIRE ALARM - VISUAL LIGHT - CEILING MOUNTED
FACP	FIRE ALARM - CONTROL PANEL
	FIRE ALARM - REMOTE ANNUNCIATOR
	FIRE ALARM - PULL STATION
FK	FIRE ALARM - HORN
ΗĒΧ	FIRE ALARM COMBINATION HORN AND AUDIO VISUAL LIGHT WALL MOUNTED
F	FIRE ALARM COMBINATION HORN AND AUDIO VISUAL LIGHT CEILING MOUNTED
⊢ FS X	FIRE ALARM COMBINATION SPEAKER AND AV LIGHT
S	SMOKE DETECTOR - CEILING MOUNTED
S	REMOTE INDICATING LIGHT WHEN REQUIRED
	SMOKE DETECTOR - WALL MOUNTED
<u> </u>	SMOKE DETECTOR - MOUNT ON AC DUCT
lacksquare	HEAT DETECTOR - CEILING MOUNTED
FS	FIRE ALARM SPEAKER
F	FIREMANS PHONE JACK
⊱EOL	END OF LINE DEVICE
М	MONITOR MODULE
С	CONTROL MODULE
—	DOOR HOLDER
—	COMBINATION FIRE/SMOKE DAMPER

SINGLE LINE SYMBOLS

<u>ww</u>	TRANSFORMER - ISOLATED GROUND-SHIELDED(ISX)
www.	TRANSFORMER - NORMAL- VOLTAGE AS INDICATED
	CIRCUIT BREAKER
	SWITCH
———	FUSE
	THERMAL ELEMENT
→	CAPACITOR
—••	LIGHTNING ARRESTER
←	CIRCUIT BREAKER - DRAWOUT TYPE
	CONTACTS - NORMALLY OPEN
*	CONTACTS - NORMALLY CLOSED
11	GROUND
HP	MOTOR, HP = HORSEPOWER
E ● _● N	TRANSFER SWITCH E = EMERGENCY SOURCE
	N = NORMAL SOURCE
	L = LOAD
TYPE—X AMPACITY—XXXX	FEEDER CONDUCTORS IDENTIFICATION TAG

GENERAL

EXISTING EQUIPMENT TO REMAIN RELOCATED EXISTING EQUIPMENT TERMINATION POINT OF DEMOLITION

DETAIL CALL OUT

EQUIPMENT IDENTIFICATION

EXISTING EQUIPMENT TO BE REMOVED EXISTING EQUIPMENT TO BE RELOCATED CONNECT NEW TO EXISTING SHEET NOTE EQUIPMENT DESIGNATION

1. ALL MOUNTING HEIGHTS LIST ARE TO CENTER OF DEVICE UNLESS OTHERWISE NOTED AND MUST CONFORM TO ADA, NFPA, ANSI 117.1 REQUIREMENTS UNLESS OTHERWISE NOTED.

MOUNTING HEIGHTS

2. CONTRACTOR TO VERIFY FINAL LOCATION OF ALL DEVICES WITH ARCHITECT AND/OR INTERIOR DESIGNER. 3. WHERE DEVICES FALL ON TWO SURFACE FINISHES, RAISE THE DEVICE TO BE ON A SINGLE FINISH. COORDINATE WITH ARCHITECT.

FIRE ALARM GONG AND BELL (WALL MOUNTED)	6'-8" MAX. HT. OR 6" BELOW CLG. WHICHEVER IS LOWER
FIRE ALARM STROBE LIGHT & SIGNALING DEVICES (WALL MOUNTED)	ENTIRE LENS IS NOT LESS THAN 80" AND NOT GREATER 96" AFF. WHERE LOW CEILINGS DO NOT PERMIT MOUNTING AT MIN. 80", DEVICE SHALL BE MOUNTED WITHIN 6" OF THE CEILING.
TOP OF LIGHTING AND/OR POWER PANELS IN COMMON BUILDING SPACES TOP OF TELEPHONE CABINET(MAXIMUM)	6' - 2" AFF
TOP OF LIGHTING AND/OR POWER PANELS IN LIVING UNITS	4' - 6" AFF TO HIGHEST OPERABLE DEVICE
TOP OF BACK MOUNTED EXIT FIXTURE (NOT LOCATED ABOVE DOORS)	12" BELOW FINISHED CEILING TO CENTERLINE
TOP OF SAFETY DISCONNECT SWITCH, CONTACTORS, MAGNETIC MOTOR STARTERS	6' - 0" MAXIMUM AFF
'++'	6" BELOW FINISHED CEILING
'+'	4' - 0" AFF OR 6" ABOVE COUNTER
Ÿ	BELOW COUNTER
TELEPHONE (TOP OF COIN SLOT) TELEPHONE OUTLET (WALL), LIGHT SWITCHES	3' - 6" AFF
MANUAL CONTROL DEVICES, FIRE ALARM PULL STATION, FIRE PHONE JACKS	3' - 6" AFF
RECEPTACLES, TELEPHONE OUTLETS (DESK) TELEVISION OUTLETS COMPUTER OUTLETS	1' - 6" (MIN.) AFF
FINISHED FLOOR ELEV. (BASE)	0' - 0"

LEGEND NOTES

THIS SHEET IS A GENERAL LIST OF SYMBOLS AND ABBREVIATIONS AND SHALL BE USED AS A DICTIONARY TO DEFINE ITEMS INDICATED ON DRAWINGS. NOT ALL SYMBOLS OR ABBREVIATIONS ARE NECESSARILY USED ON THIS PROJECT.

BUILDING CODE SUMMARY

APPLICABLE CODES:

2018 INTERNATIONAL BUILDING CODE 2018 INTERNATIONAL EXISTING BUILDING CODE

2017 NATIONAL ELECTRICAL CODE (NFPA 70) 2005 NFPA 110 - STANDARD FOR EMERGENCY AND STANDBY POWER SYSTEMS

GENERIC ELECTRICA	AL ABBRI	EVIATIONS
AMPERE(S)	LP	LIGHTING PANEL
ALTERNATING CURRENT	LPS	LOW PRESSURE SODIUM
AMP FRAME	MATV	MASTER ANTENNA TELEVISION
ABOVE FINISHED FLOOR	MC	MECHANICAL CONTRACTOR
ABOVE FINISHED GRADE	MCC	MOTOR CONTROL CENTER
ALUMINUM	MCM	THOUSAND CIRCULAR MIL(S)
AMP TRIP	MAGSTR	MAGNETIC STARTER
AUTOMATIC TRANSFER SWITCH	MH	MANHOLE
AMERICAN WIRE GUAGE	MIC	MICROPHONE
BOTTOM OF CONDUIT	MTD	MOUNTED
BELOW FINISHED CEILING	MTG	MOUNTING
CONDUIT	MTR	MOTOR
CABLE TELEVISION	MUH	MAKE-UP AIR UNIT
CIRCUIT BREAKER	NC	NORMALLY CLOSED
CONTROL CABINET	NF	NONFUSED
CLOSED CIRCUIT TELEVISION	NIC	NOT IN CONTRACT
CIRCUIT	NL	NIGHT LIGHT
CEILING	NO	NORMALLY OPEN
CONDUIT ONLY	NTS	NOT TO SCALE
CONTROL PANEL	OL	OVERLOAD ELEMENT
CURRENT TRANSFORMER	PC	PLUMBING CONTRACTOR
COPPER	PE	PHOTO ELECTRIC CELL
DIRECT CURRENT	PF	POWER FACTOR
DUAL ELEMENT	PL	PILOT LIGHT
DOUBLE POLE	PP	POWER PANEL
DISCONNECT SWITCH	PRI	PRIMARY
DOUBLE THROW	PS	PULL SWITCH
ELECTRICAL CONTRACTOR	PTZ	PAN/TILT/ZOOM CAMERA
EXHAUST FAN	R	RELAY
ELECTRIC HEATER	RC	REMOTE CONTROL
EMERGENCY LIGHTING	RCP	REFLECTED CEILING PLAN
ELECTRICAL METALLIC TUBING	RECPT	RECEPTACLE
END OF LINE RESISTOR	SATV	SATELLITE ANTENNA TELEVISION
ELECTRIC UNIT HEATER	SEC	SECONDARY
ELECTRIC WATER COOLER	SP	SINGLE POLE
FUSED	SPKR	SPEAKER
FIRE ALARM	ST	SHUNT TRIP
FIRE ALARM CONTROL PANEL	SW	SWITCH

CKT

FACP

FEEDER

GROUND

HORSEPOWER

INTERCOM

GENERAL CONTRACTOR

GROUND FAULT INTERRUPT

HIGH INTENSITY DISCHARGE

HIGH PRESSURE SODIUM

HEAVYWALL RIGID CONDUIT

THOUSAND CIRCULAR MIL(S)

ELECTRIC HEAT TRACE

ISOLATED GROUND

KILOVOLT AMPERE(S)

INCANDESCENT

JUNCTION BOX

KILOVAR(S)


KILOWATT(S)

SWITCH SWBD SWITCHBOARD **TELEPHONE** TIME CLOCK TIME DELAY TIME DELAYED CLOSED TIME DELAYED OPEN **TELEVISION** TYPICAL UNDERFLOOR DUCT UNDER GROUND HERTZ(FREQ. IN CYCLES PER SECOND) UNIT HEATER UNLESS OTHERWISE NOTED VOLTS **VOLT AMPS REACTIVE** VAPOR PROOF WEATHERPROOF TRANSFORMER EXPLOSION PROOF

	DRAWING SCHEDULE
DRAWING NUMBER	DRAWING TITLE
E001.0	COVER SHEET
ED100.0	BASEMENT DEMOLITION PLAN
ED101.0	FIRST FLOOR DEMOLITION PLAN
E101.0	BASEMENT NEW WORK PLAN
E102.0	FIRST FLOOR NEW WORK PLAN
E501.0	DETAILS
E601.0	SCHEDULES AND DIAGRAMS

PROJECT LOCATION ----



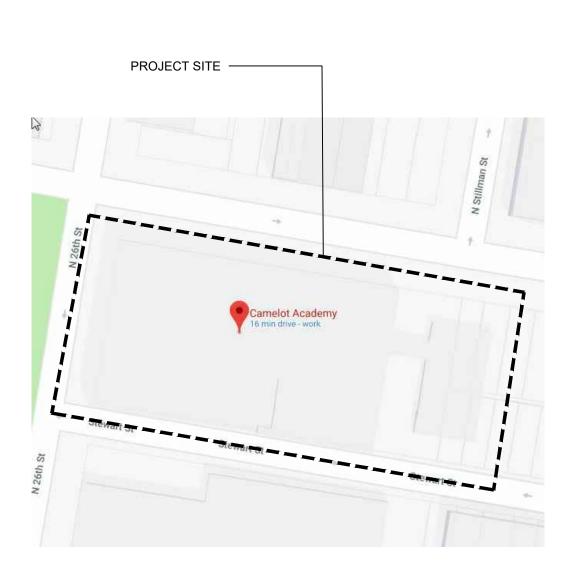

PROJECT STREET MAP



THE SCHOOL DISTRICT OF PHILADELPHIA

OFFICE OF CAPITAL PROGRAMS

440 NORTH BROAD STREET PHILADELPHIA, PA 19130 - 4015

(215) 400 - 4730 | (215) 400 - 4731 (fax)

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SEAL:

NAYAN VINUBHAI PATEL, PE PENNSYLVANIA LICENSE NO:

MEP Engineer

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ADDENDUM #03 SEPTEMBER 18, 201

2 | 09/18/19 | ADDENDUM #03 1 08/15/19 ADDENDUM #02 NO. DATE REVISION

SCHOOL & LOCATION CAMELOT ACADEMY 1435 N. 26TH STREET PHILADELPHIA, PA 19121

PROJECT TITLE


GENERATOR REPLACEMENT

DRAWING TITLE **COVER SHEET**

DRAWING SCALE AS NOTED LOCATION NO. FILE NO. 2310 DRAWN BY CHECKED BY

OF 2018 / 19

DRAWING NO.

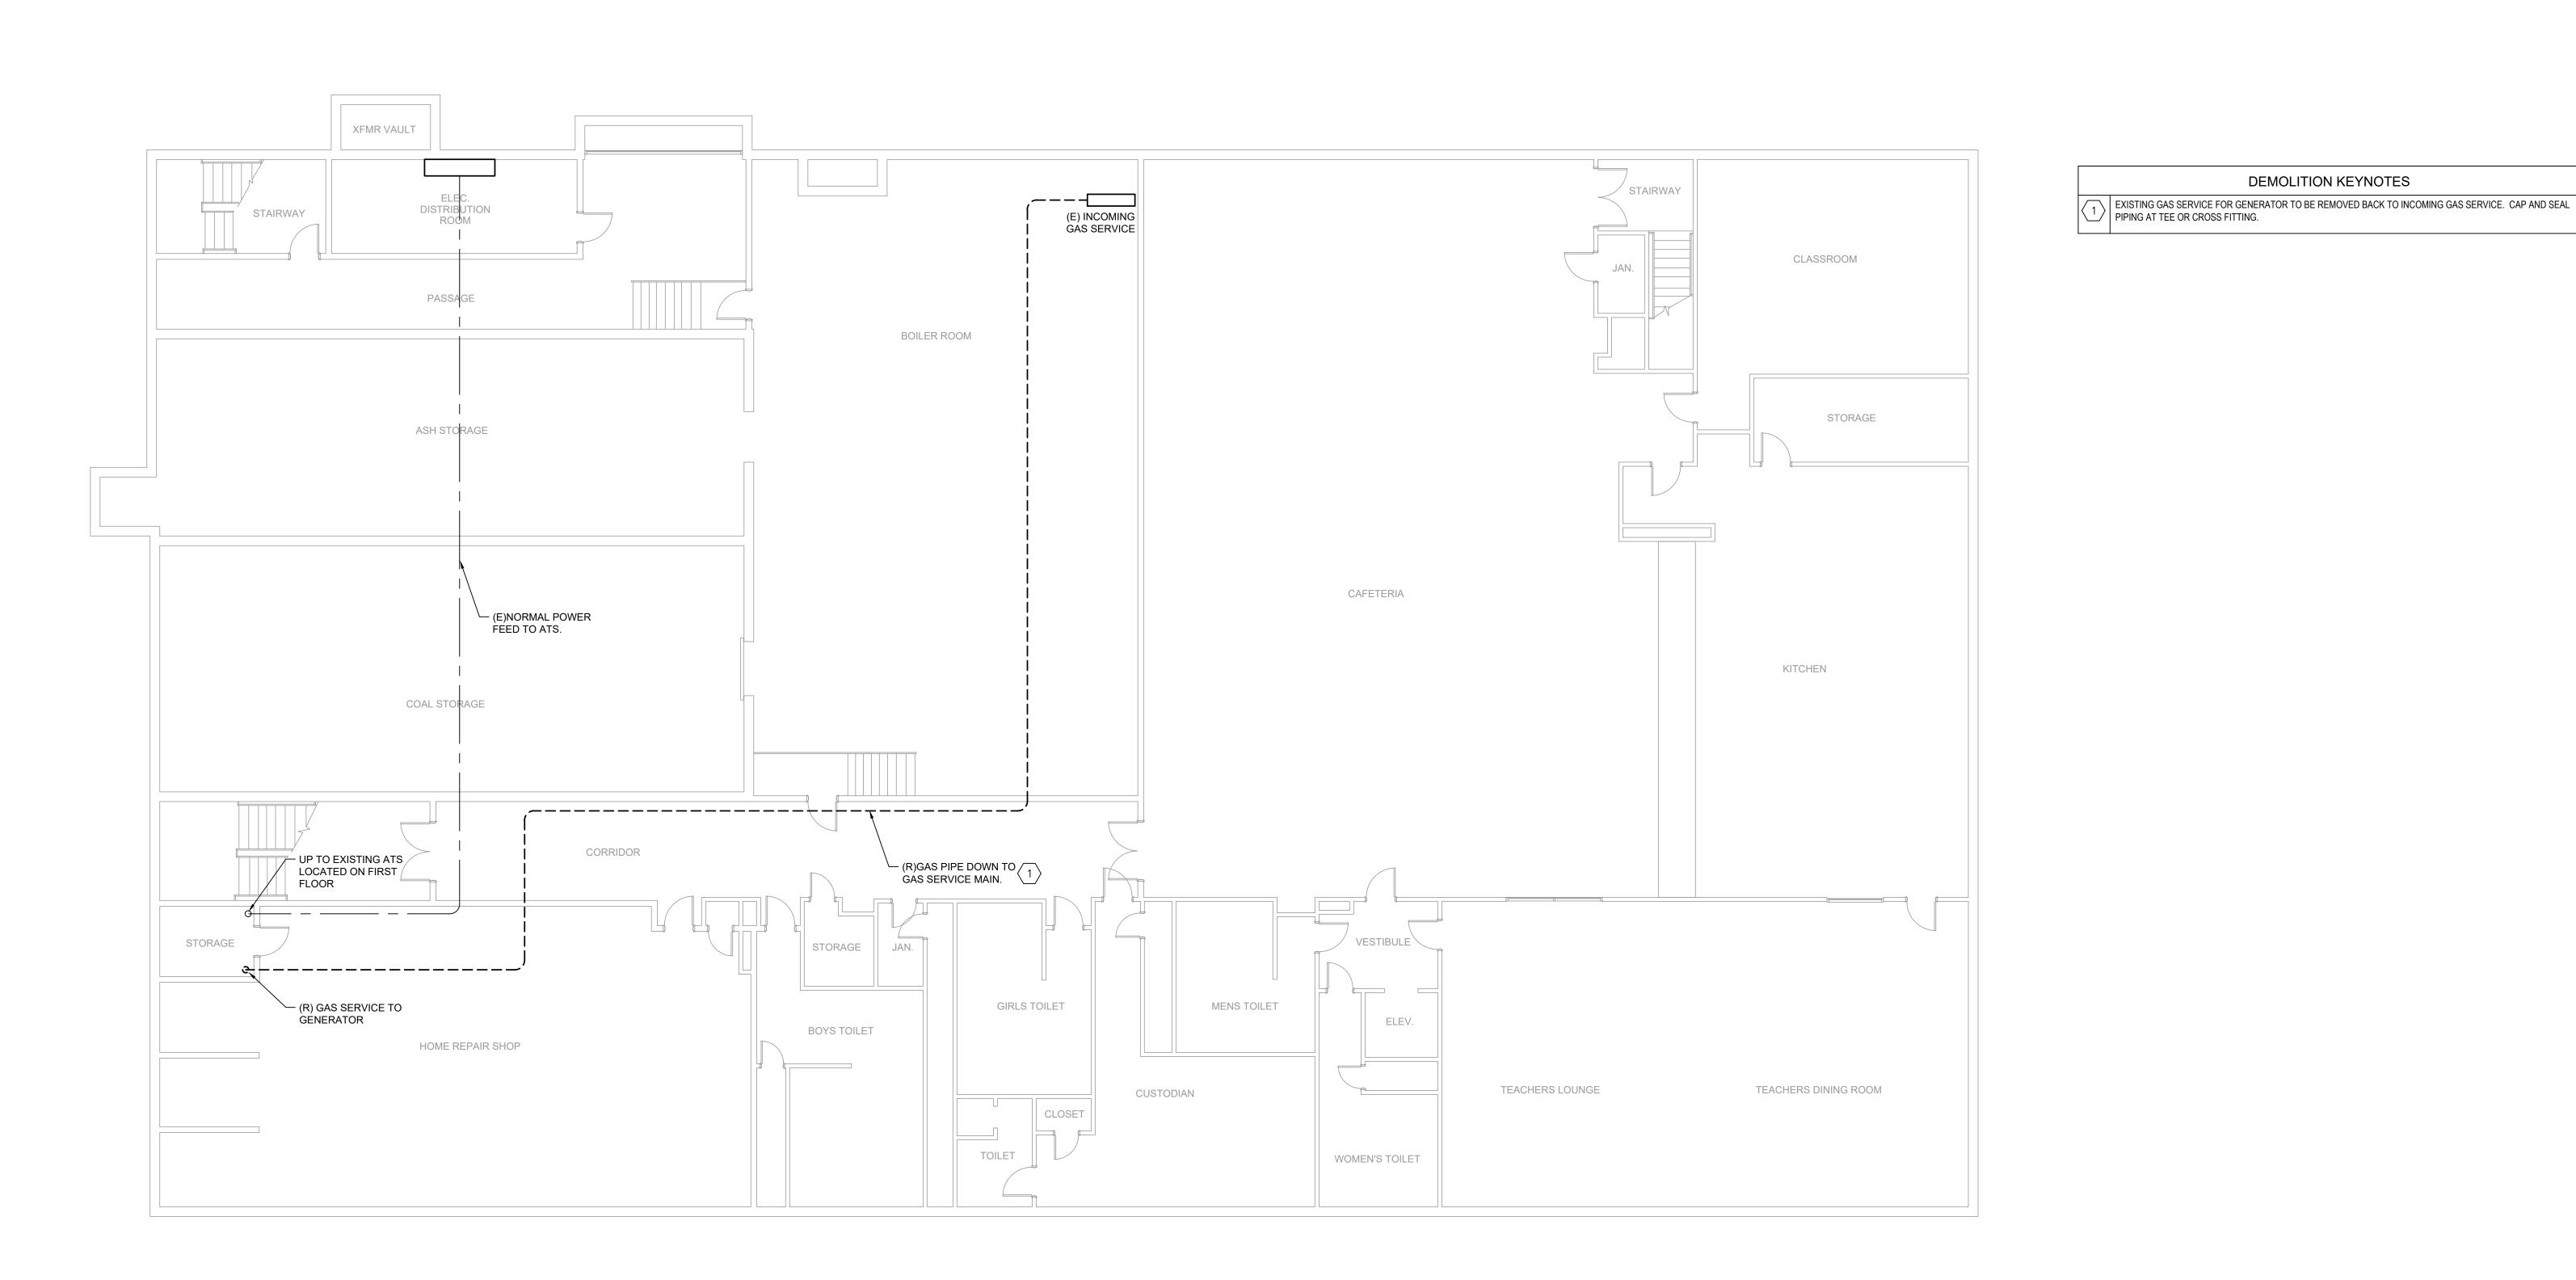

DEMOLITION KEYNOTES

BASEMENT DEMOLITION PLAN 1

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THE SCHOOL DISTRICT OF PHILADELPHIA

SEAL:

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ADDENDUM #03 SEPTEMBER 18, 2019

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NO.	DATE	REVISION

SCHOOL & LOCATION **CAMELOT ACADEMY** 1435 N. 26TH STREET PHILADELPHIA, PA 19121

PROJECT TITLE

GENERATOR REPLACEMENT

DRAWING TITLE

BASEMENT DEMOLITION PLAN

B-036C (OF 2018 / 19
DRAWN BY AD	CHECKED BY NVP
LOCATION NO. 2310	FILE NO.
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SHEET 2 OF 7

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SEAL:

DEMOLITION KEYNOTES

DISCONNECT AND REMOVE GENERATOR, ALL ASSOCIATED ACCESSORIES (BATTERY CHARGERS, EXHAUST MANIFOLD, ETC), AND ALL ASSOCIATED WIRING AND CONDUIT. EXISTING CONCRETE HOUSEKEEPING PAD FOR GENERATOR TO REMAIN. CLEAN EXISTING HOUSE-KEEPING PAD AND PREPARE FOR EXTENSION UNDER NEW

LINE FEEDERS, LOAD FEEDERS, AND ASSOCIATED CONDUIT. NORMAL POWER FEED FROM MDP TO BE

DISCONNECTED AND PREPARED FOR CONNECTION TO NEW AUTOMATIC TRANSFER SWITCH.

DISCONNECT AND REMOVE EXISTING 60A, 240V, 3 POLE DISCONNECT SWITCH.

PENETRATION FOR EXHAUST PIPING.

GAS SERVICE.

TO EXISTING AUTOMATIC TRANSFER SWITCH.

WORK. DISCONNECT AND REMOVE ALL EXHAUST AND GAS PIPING AND HANGERS. PATCH AND REPAIR WALL

DISCONNECT AND REMOVE 60A, 2-POLE, 240V AUTOMATIC TRANSFER SWITCH (ATS). DISCONNECT EMERGENCY

DISCONNECT AND REMOVE FUSED EMERGENCY PANEL. DISCONNECT AND SAFE OFF ALL (20) BRANCH CIRCUITS, PREPARE FOR RECONNECTION TO NEW PANEL BOARD. REMOVE EXISTING POWER FEEDERS AND CONDUIT BACK

EXISTING GAS SERVICE FOR GENERATOR TO BE REMOVED BACK TO MAIN INCOMING GAS SERVICE LOCATION. CAP AND SEAL PIPING AT TEE OR CROSS FITTING. REFER TO DRAWING ED100 FOR CONTINUATION OF EXISTING

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TOILET STAIRWAY VESTIBULE BOYS LOCKER ROOM LIBRARY STAGE **AUDITORIUM** GYMNASIUM STOR. ADMIN. ASSISTANT COUNSELOR STORAGE CORRIDOR GENERAL OFFICE LOBBY WOMEN'S TOILET (R) GENERATOR (R) EXHAUST PIPE — CAR WASHING & POLISHING (R) GAS PIPE DOWN TO BASEMENT BOYS TOILET MEN'S TOILET WOOD PRODUCTION SHOP PROJECT SUPPLIES & STORAGE (E) STORM —/ WATER GRATE PRINCIPAL FINISHING ROOM LUMBER STORAGE TOILET ROOM

ADDENDUM #03 SEPTEMBER 18, 2019

2 09/18/19 ADDENDUM #03 1 08/15/19 ADDENDUM #02

SCHOOL & LOCATION CAMELOT ACADEMY 1435 N. 26TH STREET PHILADELPHIA, PA 19121

NO. DATE REVISION

PROJECT TITLE


GENERATOR REPLACEMENT

DRAWING TITLE

FIRST FLOOR DEMOLITION PLAN

DRAWING SCALE AS NOTED LOCATION NO. DRAWN BY CHECKED BY

DRAWING NO.

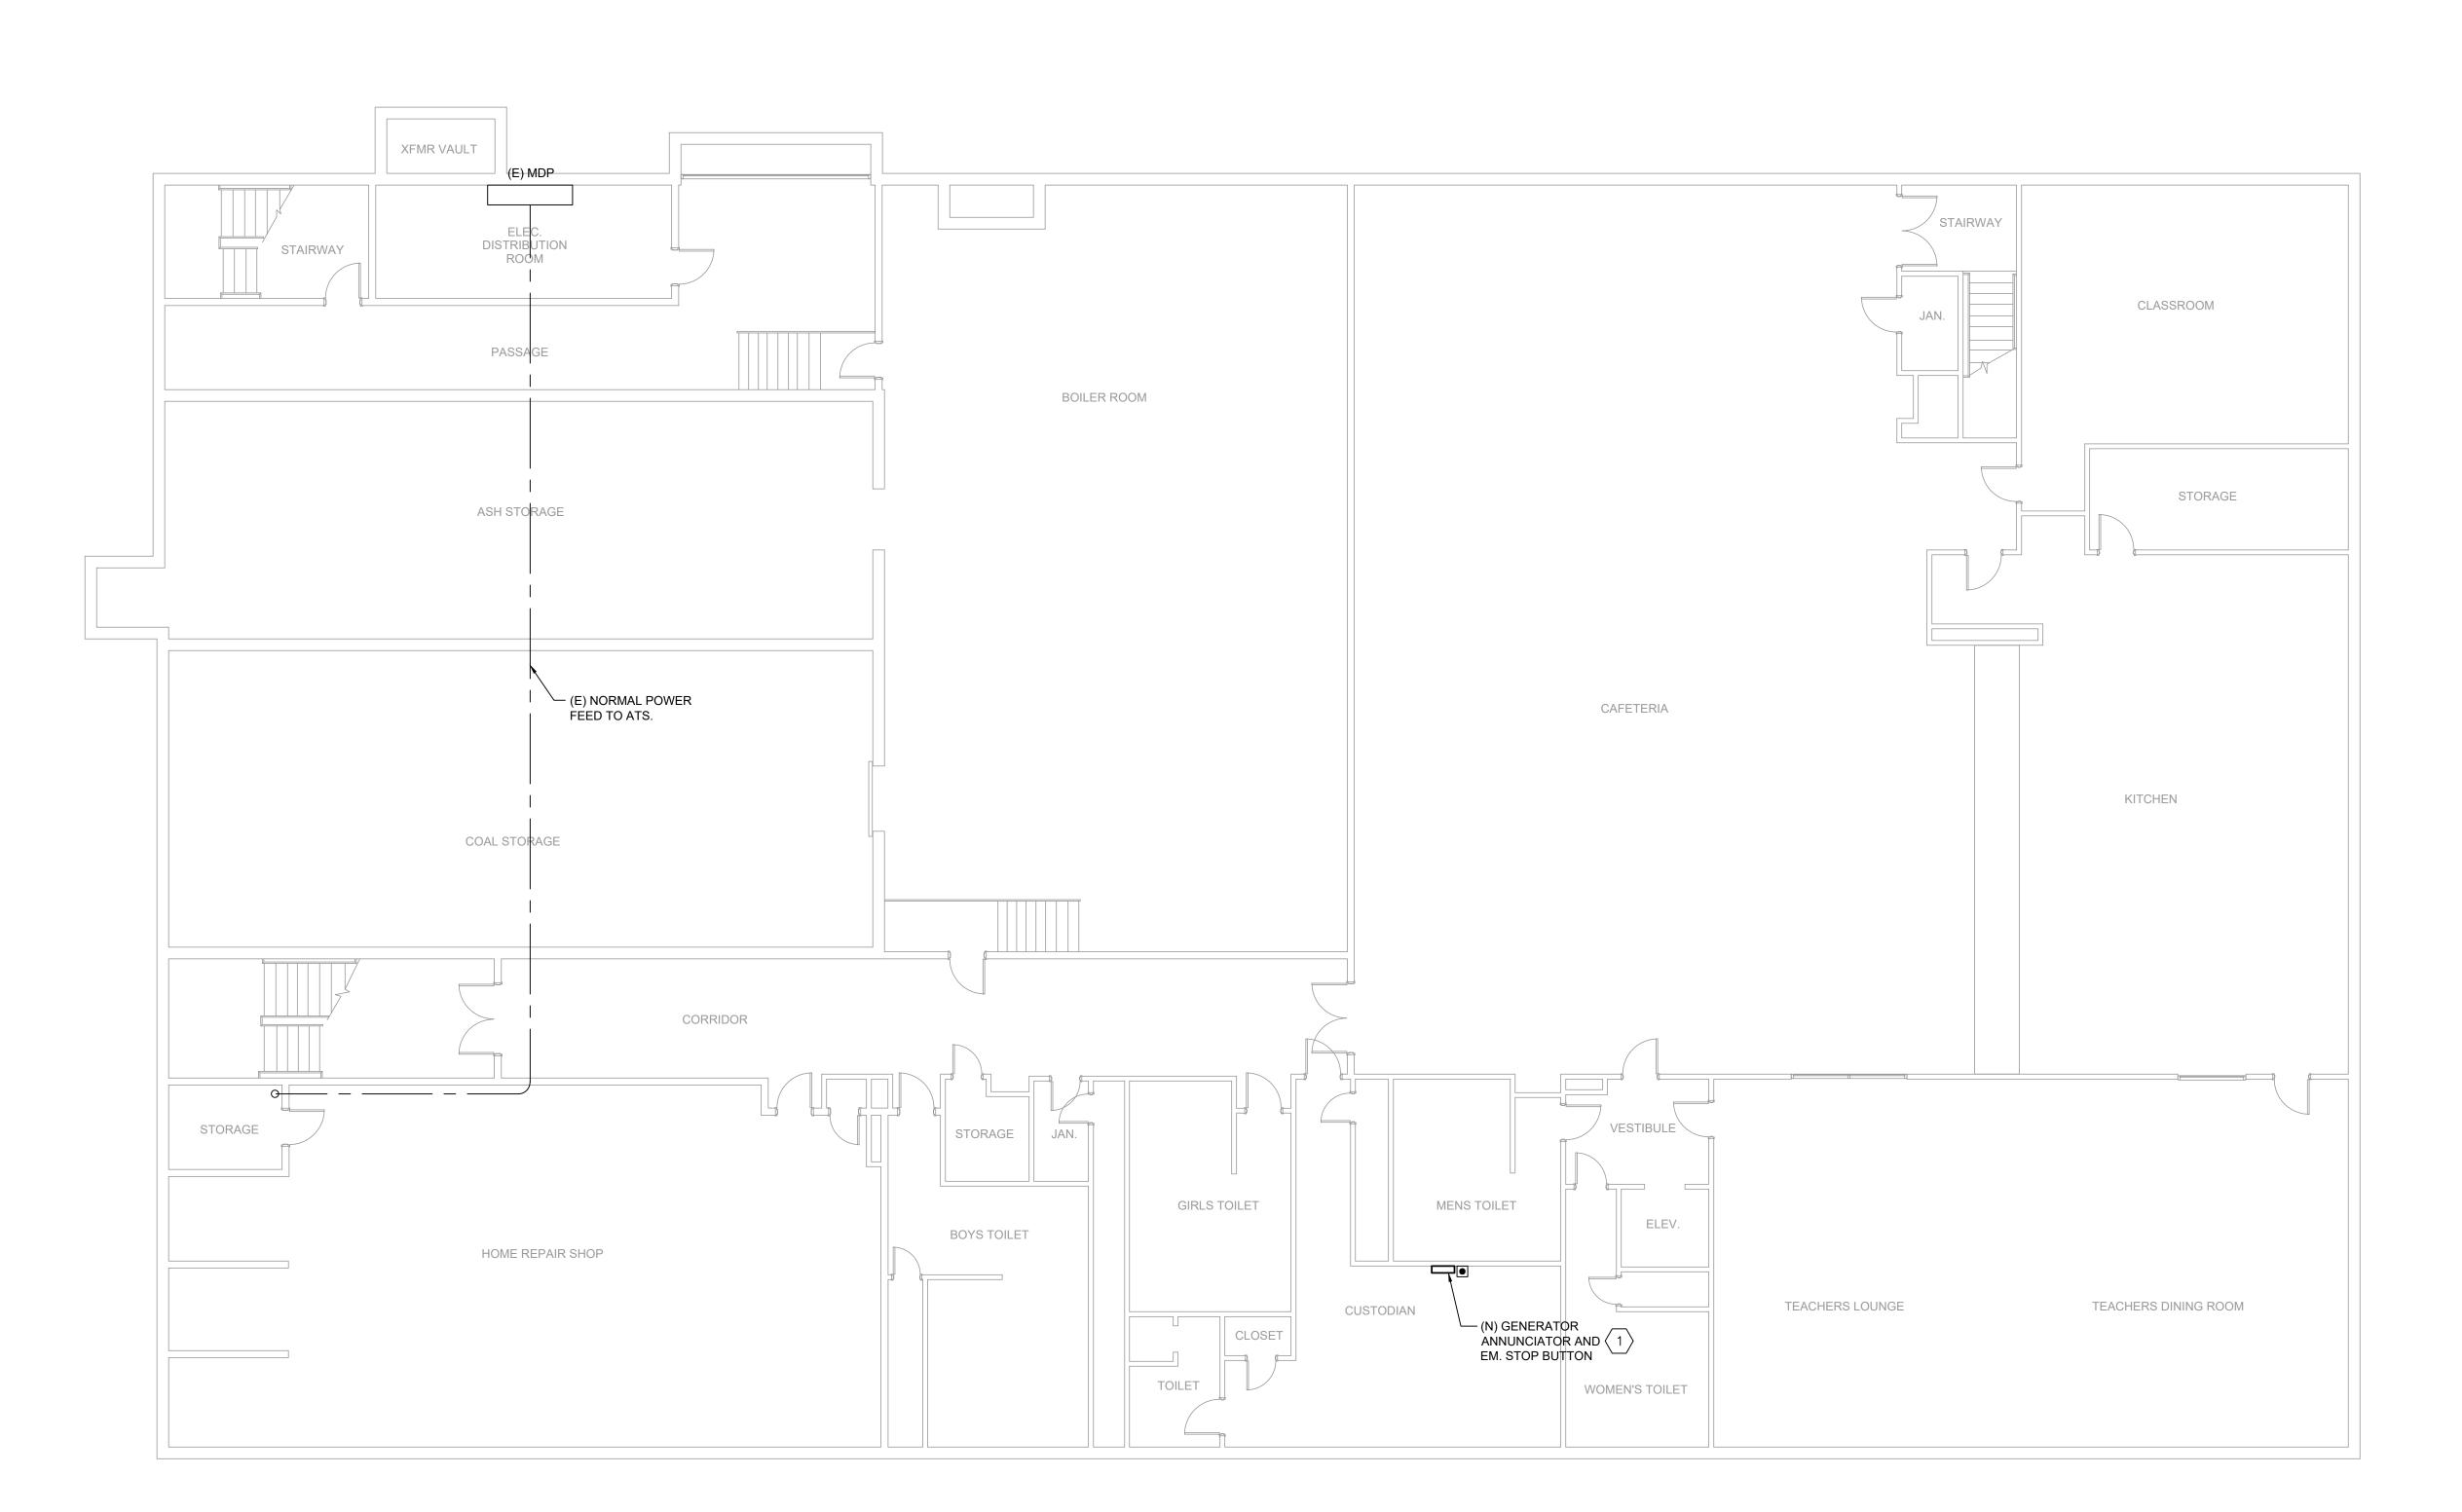

GENERAL NOTES:

A. ALL CONDUIT SHALL BE THREADED GALVANIZED RIGID METAL (STEEL) CONDUIT ONLY.B. CONTRACTORS SHALL COORDINATE INSTALLATION WITH SDP ENVIRONMENTAL TEAM.

BASEMENT NEW WORK PLAN

NEW WORK KEY NOTES

PROVIDE NEW EMERGENCY STOP BUTTON AND GENERATOR ANNUNCIATOR WITH WIRE GUARD CAGE,
COMPATIBLE WITH NEW GENERATOR. PROVIDE 1" CONDUIT FROM GENERATOR TO EM. STOP BUTTON AND ANNUNCIATOR FOR INTERCONNECTION OF BUTTON AND ANNUNCIATOR TO GENERATOR CONTROL PANEL. PROVIDE WIRING INTERCONNECTION PER GENSET MANUFACTURER REQUIREMENTS. ANNUNCIATOR PANEL AND EM. STOP BUTTON TO BE LOCATED WITHIN BUILDING ENGINEER'S OFFICE. ALL EXTERIOR AND INTERIOR WALL PENETRATION SHALL BE FIRE STOPPED.

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SCHOOL & LOCATION **CAMELOT ACADEMY** 1435 N. 26TH STREET

PHILADELPHIA, PA 19121 PROJECT TITLE


GENERATOR REPLACEMENT

DRAWING TITLE

BASEMENT NEW WORK PLAN

B-036C (OF 2018 / 19
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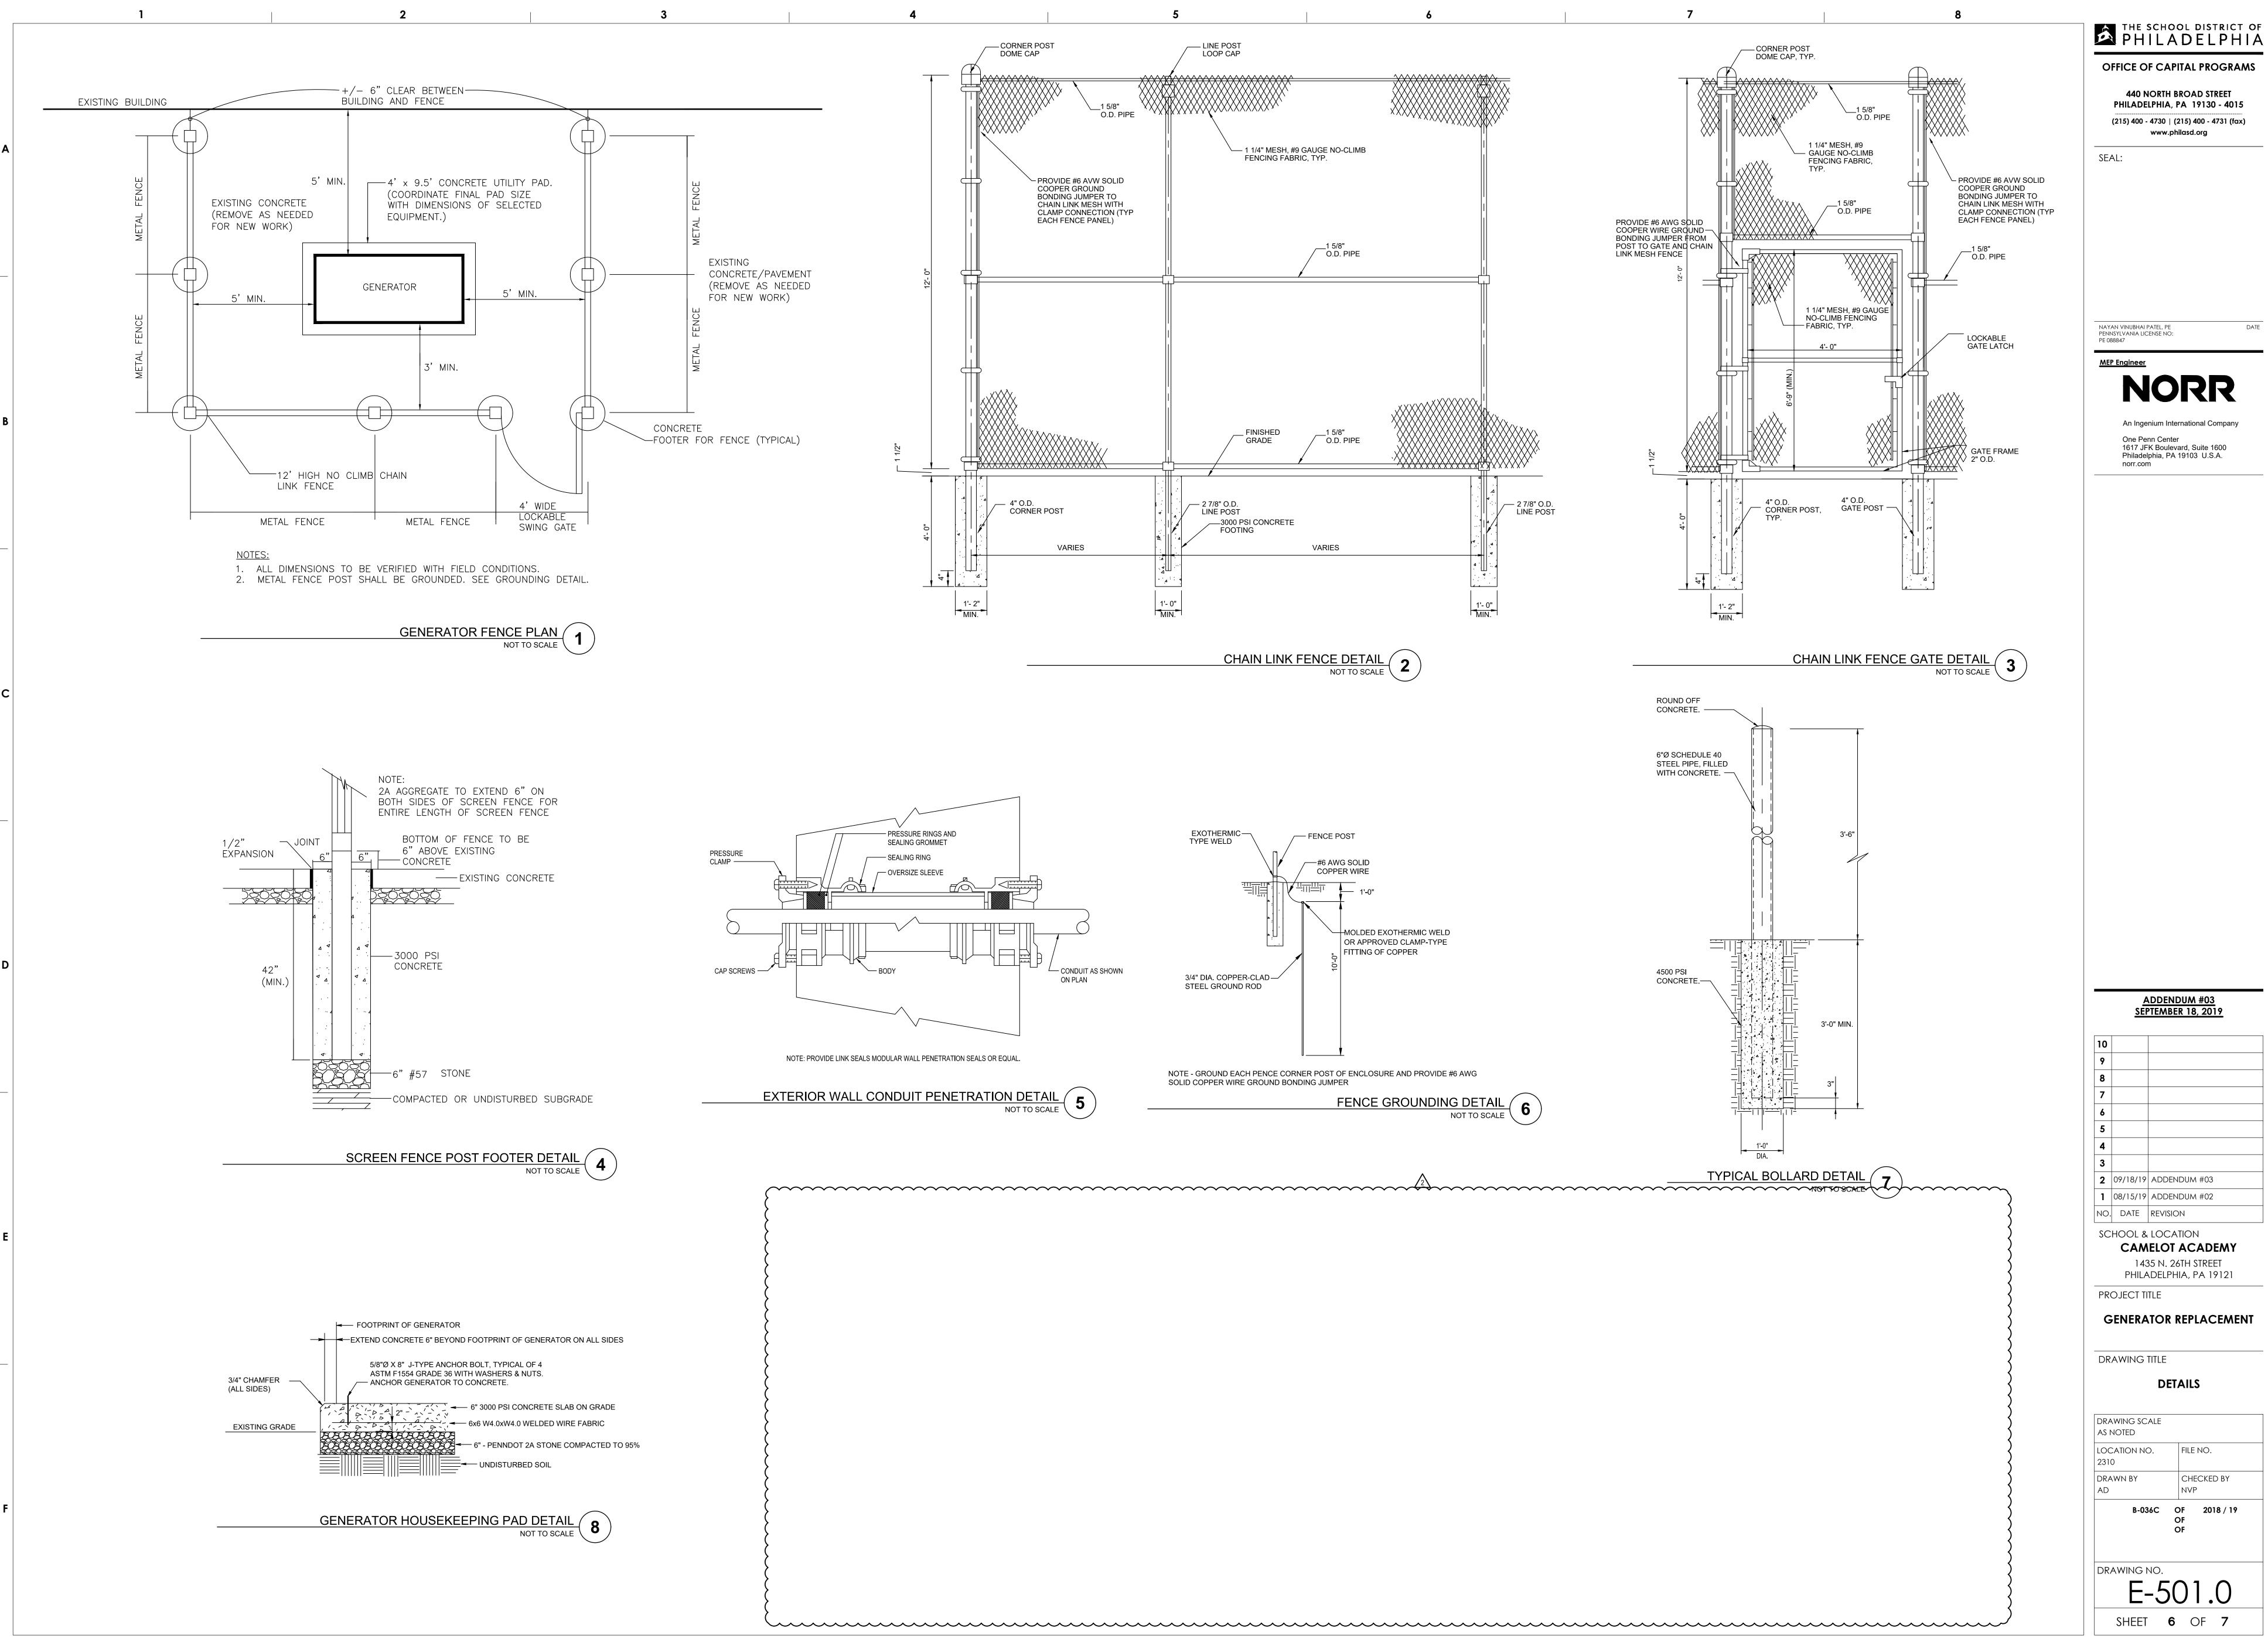
GENERATOR REPLACEMENT

DRAWING TITLE

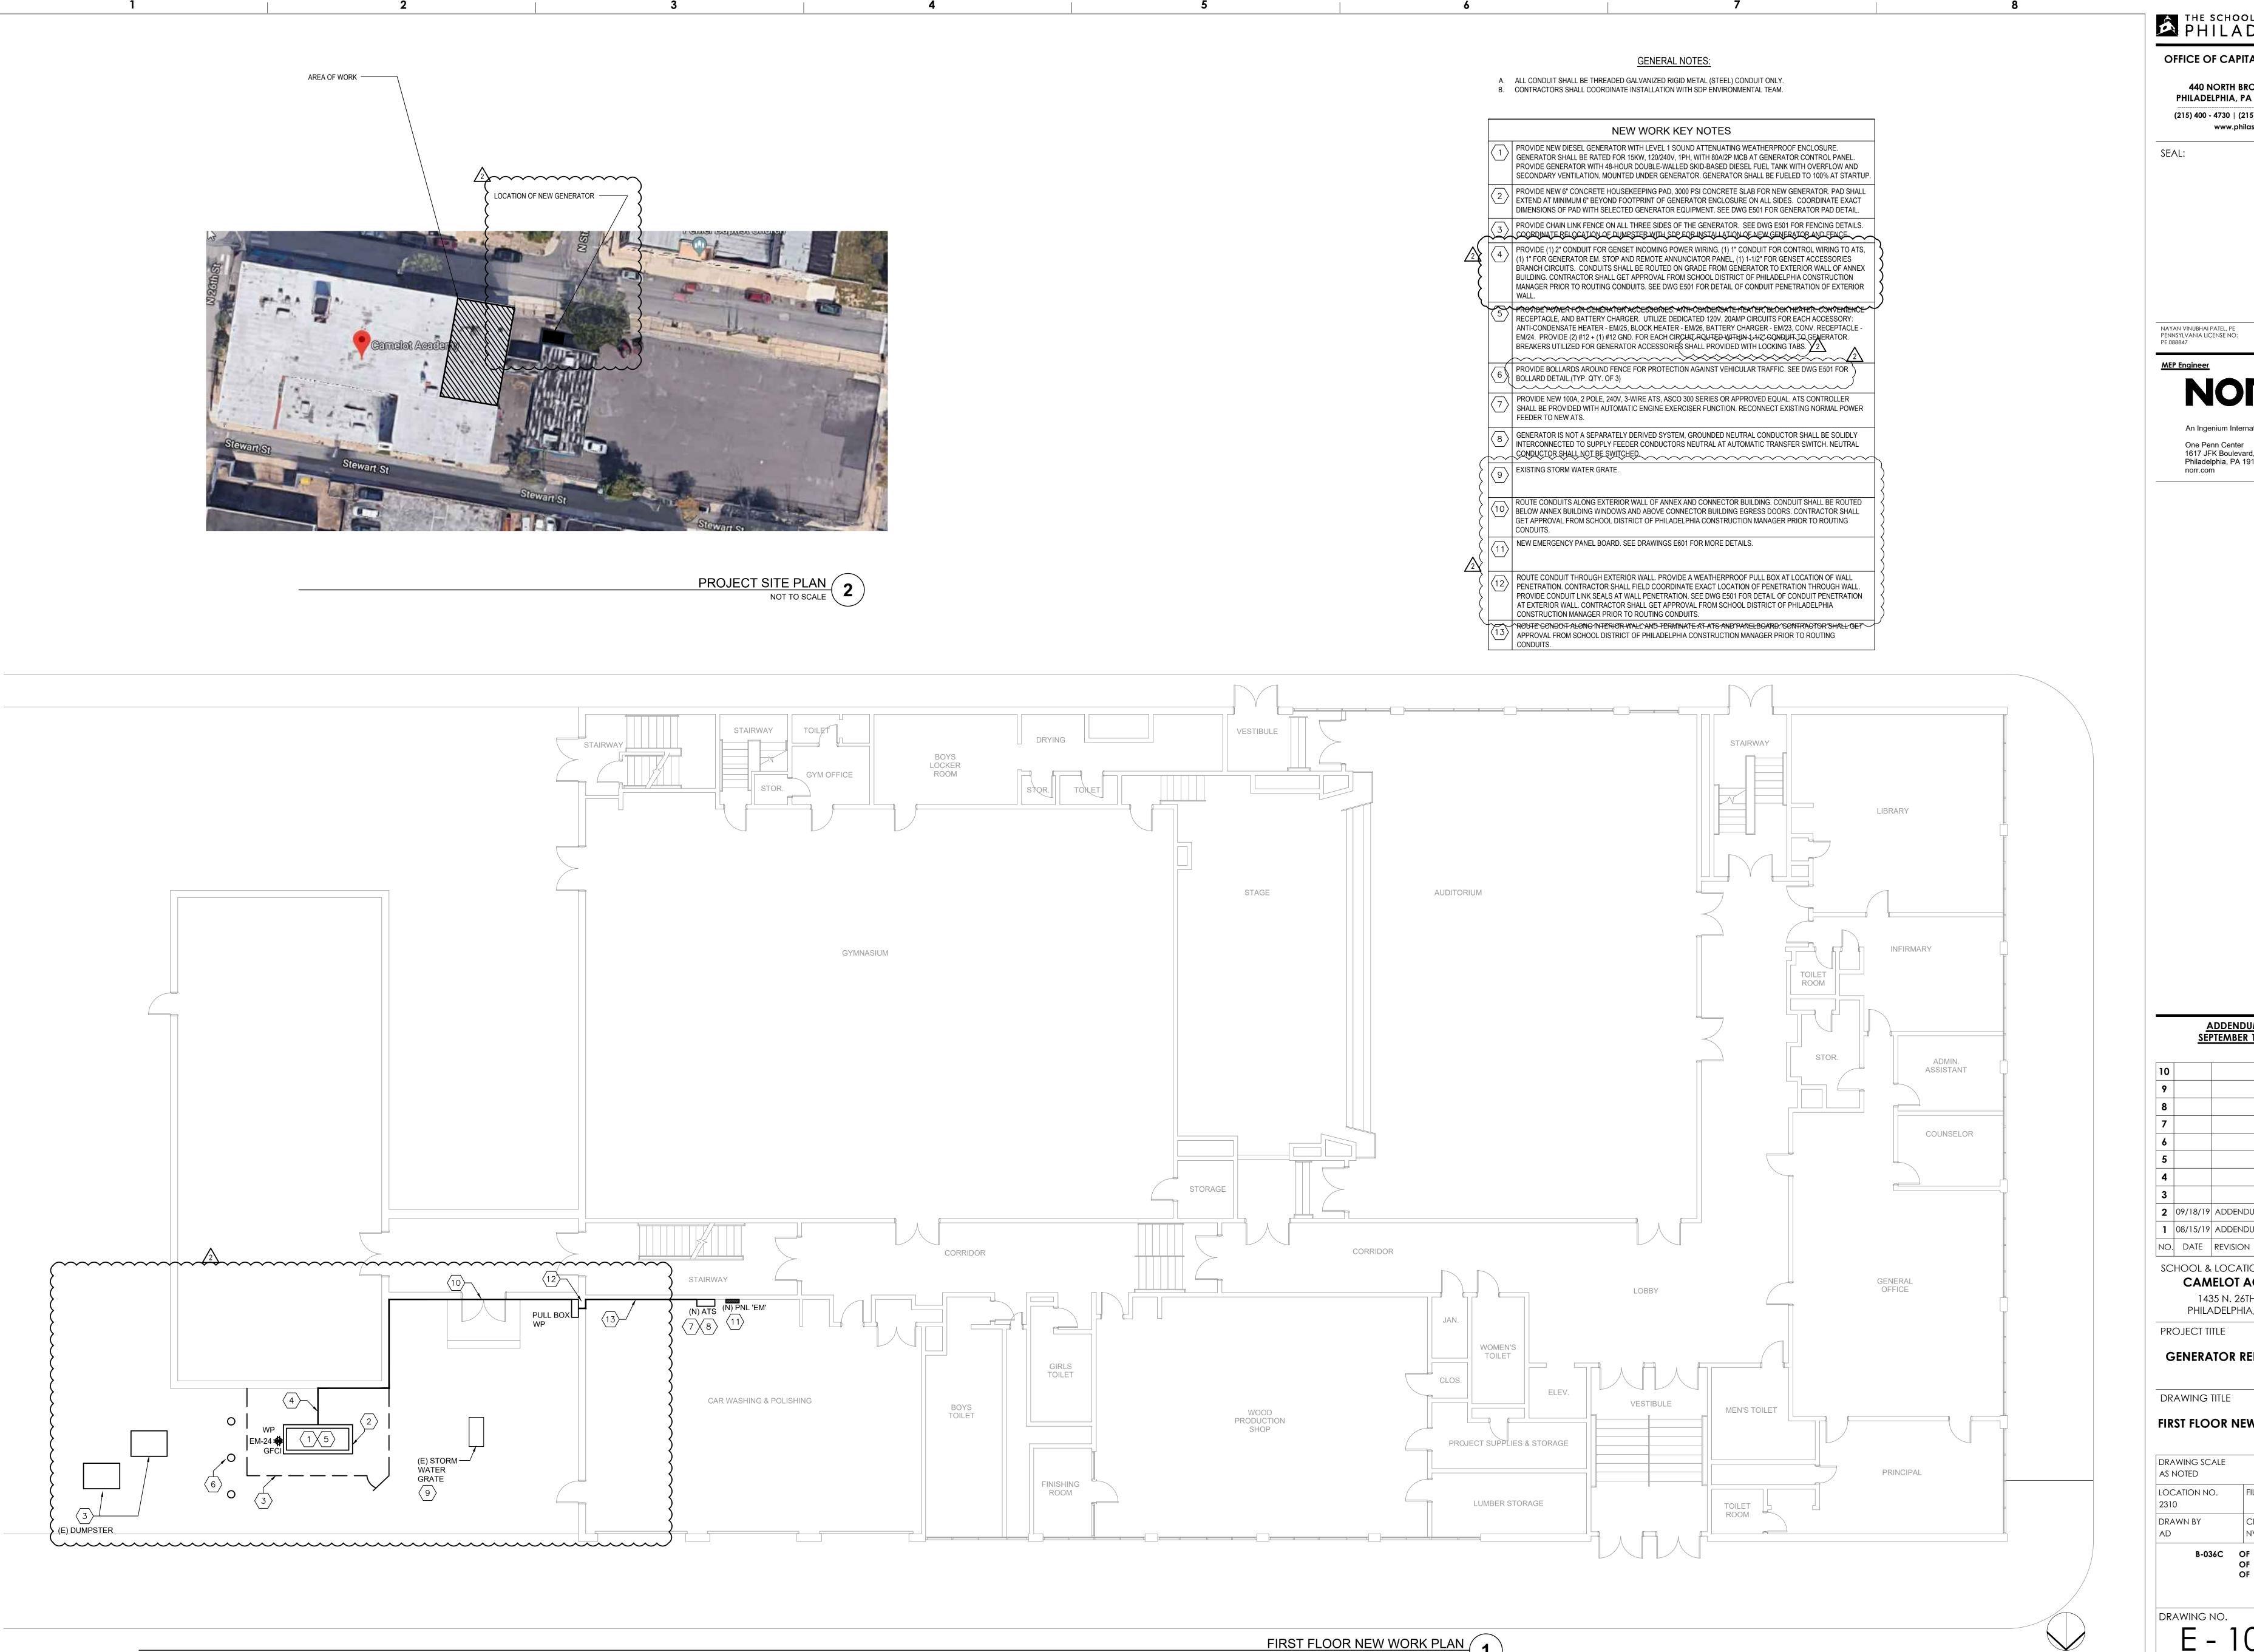FIRST FLOOR NEW WORK PLAN

DRAWING SCALE AS NOTED LOCATION NO. FILE NO.

> CHECKED BY 2018 / 19



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(R) 12.5KW GEN
120/240V, 1PH, 3W

(R) CONDUCTORS AND CONDUIT

(E) MDP

(R) DISCONNECT SWITCH

(R) CONDUCTORS AND CONDUIT

(R) 2P ATS
60A, 240V

(R) CONDUCTORS AND CONDUIT

(R) EMERGENCY PANEL

DEMOLITION SINGLE LINE DIAGRAM NOT TO SCALE

1" TO ATS
1" TO REMOTE ANNUN. & EM STOP BUTTON
1.5" TO PNL EM GENSET ACCESSORIES

FROM
(E) MDP
(E) MDP
(E) EXISTING DISCONNECT SWTICH
(I) #4GND.
(N) 2"C. W/ (3) #1 &
(1) #8 GND.
(N) EM
PANEL

NEW WORK KEY NOTES

FEEDER TO NEW ATS.

CONDUCTOR SHALL NOT BE SWITCHED.

ALL MANUFACTURERS WARRANTY REQUIREMENTS.

PROVIDE NEW 100A, 2 POLE, 240V, 3-WIRE ATS, ASCO 300 SERIES OR APPROVED EQUAL. ATS CONTROLLER SHALL BE PROVIDED WITH AUTOMATIC ENGINE EXERCISER FUNCTION. RECONNECT EXISTING NORMAL POWER

GENERATOR IS NOT A SEPARATELY DERIVED SYSTEM, GROUNDED NEUTRAL CONDUCTOR SHALL BE SOLIDLY INTERCONNECTED TO SUPPLY FEEDER CONDUCTORS NEUTRAL AT AUTOMATIC TRANSFER SWITCH. NEUTRAL

PROVIDE NEW PANEL "EM". SEE SINGLE LINE DIAGRAM AND DWG E601 FOR MORE DETAILS. RECONNECT ALL EXISTING (QTY 20) BRANCH CIRCUITS TO NEW PANEL BOARD. PROVIDE NAME PLATE PLACARDS FOR EACH BRANCH CIRCUIT. PANEL BOARD SHALL BE PROVIDED WITH (1) MCB FOR NORMAL/EMERGENCY FEEDER TO PANEL

BOARD. PROVIDE PLACARD LABEL FOR MAIN BREAKER. PROVIDE A TVSS FOR NEW PANEL BOARD.

CONTRACTOR IS RESPONSIBLE FOR FUELING OF GENERATOR TO 100%, START-UP, TESTING, COMMISSION, AND

NOTE - ALL CONDUIT SHALL BE THREADED GALVANIZED RIGID METAL (STEEL) CONDUIT ONLY.



												IVIA IINS						
	PANEL: EM (NEW)	EL: EM (NEW)						VOLTAGE: 120/240V1 PHASE 3 WRE					BUS:	100A	AMPS	10000	AIC	
	LOCATION:						MOUNT	ING: S	SURFACE		FLUSH				LUGS C	NLY		
	FED FROM:						X	DENOTI	ESARCE	AULTIN	TERRUP	TER C.B.			MCB	80A	AMPS	
							•	DENOTI	ES GFI C.	B. REQ'D				COPPE	R BUS C	NLY	_	
CIR	EQUIPMENT SERVED	FEEDE	RSIZE		Breake	r	LOAD	⟨VA		LOAD	(VA	Breake	r	FEEDER	SIZE		EQUIPMENT SERVED	CIR
#		Wire	GND	I.G.	Am ps	Poles	L1	L2	Ø	L1	L2	Am ps	Poles	Wire	GND	I.G.	1	#
1	(E) EXIT LIGHTS	12	12	-	20	1	1.0		Α	1.0		20	1	12	12	-	(E) BASEMENT CORRIDOR LIGHTS	2
3	(E) EXTERIOR LIGHTS	12	12	-	20	1		1.0	В		1.0	20	1	12	12	-	(E) 1ST FLOOR CORRIDOR LIGHTS	4
5	(E) LIBRARY LIGHTS	12	12	-	20	1	1.0		Α	1.0		20	1	12	12	-	(E) 2ND FLOOR CORRIDOR LIGHTS	6
7	(E) BOILER RM LIGHTS	12	12	-	20	1		1.0	В		1.0	20	1	12	12	-	(E) 3RD FLOOR CORRIDOR LIGHTS	8
9	(E) ELECTRICAL RM LIGHTS	12	12	-	20	1	1.0		Α			20	1	12	12	-	(E) SPARE	10
11	(E) SPARE	12	12	=	20	1		1.0	В		1.0	20	1	12	12	-	(E) STAIR#1 LIGHTS	12
13	(E) AUDITORIUM LIGHTS	12	12	=	20	1	1.0		Α	1.0		20	1	12	12	-	(E) STAIR#2 LIGHTS	14
15	(E) GY MNA SIUM LIGHTS	12	12	-	20	1		1.0	В		1.0	20	1	12	12	-	(E) STAIR#3 LIGHTS	16
17	(E) CA FETERIA LIGHTS	10	10	-	30	2	1.0		Α			20	1	12	12	-	(E) SPARE	18
19	EXISTING LOAD	-	-	-				1.0	В			20	1	12	12	-	(E) SPARE	20
21	(E) SPARE	12	12	-	20	1			Α			20	1	-	12	-	SPARE	22
23	(N) BATTERY CHARGER	12	12		20	1		1.5	В		1.5	20	1	12	12	•	(N) CONV. RECEPT.	24
25	(N) ANTI-CONDENSATE HTR.	12	12		20	1	1.5		Α	1.5		20	1	12	12	•	(N) BLOCK HEATER	26
27	(N) TVSS	10	10		30	2			В			20	1	-	12	-	SPARE	28
29		10	10	_	30	2			Α			20	1	-	12	-	SPARE	30
31	SPARE	I	-	H	20	1			В			20	1	Н	12	T.	SPARE	32
33	SPARE	U		=	20	1			Α			20	1	-	12	i	SPARE	34
35	SPARE	-	-	-	20	1			В			20	1	-	12	ı	SPARE	36
37	SPARE	-	; -	-	20	1			Α			20	1	-	12	-	SPARE	38
39	SPARE	-	-	-	20	1			В			20	1	-	12	-	SPARE	40
	SPARE	-	-	-	20	1			Α			20	1	-	12	-	SPARE	42
Rem	arks:		LINET				6.5	6.5		4.5	5.5					MITH B	USES FOR ALL	
			TOTAL	CONN	l. KVA				23.0			CB'S	ANDS	PACES S	HOWN			
			TOTAL	CONN	I. AMPS				95.8				200% N	EUTRAL	BUS		FEED THRU LUGS	
												☐ ISOLATED GROUND BUS						
															S. 1D DOC			
													GROUN	ID BUS				

THE SCHOOL DISTRICT OF PHILADELPHIA

OFFICE OF CAPITAL PROGRAMS

www.philasd.org

440 NORTH BROAD STREET
PHILADELPHIA, PA 19130 - 4015
(215) 400 - 4730 | (215) 400 - 4731 (fax)

SEAL:

NAYAN VINUBHAI PATEL, PE PENNSYLVANIA LICENSE NO: PE 088847

MEP Engineer

NORR

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One Penn Center
1617 JFK Boulevard, Suite 1600
Philadelphia, PA 19103 U.S.A.
norr.com

ADDENDUM #03 SEPTEMBER 18, 2019

10		
9		
8		
7		
6		
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3		
2	09/18/19	ADDENDUM #03
1	08/15/19	ADDENDUM #02
NO.	DATE	REVISION

SCHOOL & LOCATION CAMELOT ACADEMY 1435 N. 26TH STREET

PHILADELPHIA, PA 19121
PROJECT TITLE

GENERATOR REPLACEMENT

DRAWING TITLE

SCHEDULES AND DIAGRAMS

2310	AD B-036C	NVP OF 2018 / 19
	LOCATION NO. 2310 DRAWN BY	FILE NO.

OF OF

E - 601.0

SHEET 7 OF 7