

**THE SCHOOL DISTRICT OF PHILADELPHIA
Office of Capital Programs
440 North Broad Street, 3rd Floor – Suite 371
Philadelphia, PA 19130**

TELEPHONE: (215) 400-4730

Addendum No. 4

Subject: Pennypacker Elementary School – ATC Replacement
SDP Contract Nos. B-016 C, B-015 C of 2017/18

Location: Pennypacker Elementary School
1850 East Washington Lane
Philadelphia, Pennsylvania 19138

This Addendum No. 4, dated January 12, 2021, shall modify and become part of the Contract Documents for the work of this project. Any items not mentioned herein, or affected by, shall be performed strictly in accordance with the original documents.

NOTICE: BID OPENING IS POSTPONED UNTIL TUESDAY, JANUARY 19, 2021

The following items, clarifications and/or revisions are to be included in the Contract Documents:

BIDDER'S QUESTIONS

1. Addendum 3 dated 12/22/20 states Drawing 103 is in the addendum, it is not in the two page addendum. Should we bid the job with no work included on the 3^d floor?

Response: Drawing E103 included to this response.

2. Dates for addendums are not in sequence and addendum 3 shows as addendum 1 at bottom of page 1, addendum 2 and 4 on 2^d page and states it's for the Beeber School ADA Bathroom upgrades. Should we list addendums and dates on our bid form?

Response: Addendum response footers have been corrected

CHANGES TO DRAWINGS

E103 – THRID FLOOR POWER PLAN

End of Addendum 4

SEAL:

NAYAN VIKRAMJI PATEL, PE
PENNSYLVANIA LICENSE NO:
PE 088847


MEP Engineer
NORR
1617 JFK Blvd, Suite 1600
Philadelphia, PA 19103
Phone: 215-525-4849
Fax:
Email: MICHAEL.SIGLO@NORR.com
Attn: Michael Siglo

GENERAL POWER NOTES

- A. FOR ELECTRICAL SYMBOLS, ABBREVIATIONS, REFER TO DRAWING E001.
- B. CONTRACTOR SHALL PROVIDE COMPLETE AND ACCURATE CIRCUIT DIRECTORIES FOR ALL NEW AND EXISTING PANELS AFTER NEW WORK IS COMPLETED.
- C. FIRE ALARM SHALL BE OPERATIONAL AND MAINTAINED DURING ALL ASPECTS OF DEMOLITION AND NEW CONSTRUCTION.
- D. MAINTAIN THE CONTINUITY OF ALL EXISTING TO REMAIN OUTSIDE THE SCOPE OF WORK AREA.

KEY NOTES

- 1 PROVIDE JUNCTION BOX FOR LOW VOLTAGE THERMOSTATIC RADIATOR VALVE CONTROLLER. EXTEND BRANCH CIRCUIT WIRING FROM EXISTING PANEL RM 110 (LOCATED IN FIRST FLOOR ROOM 110) AND CONNECT TO CONTROLLER TRANSFORMER.

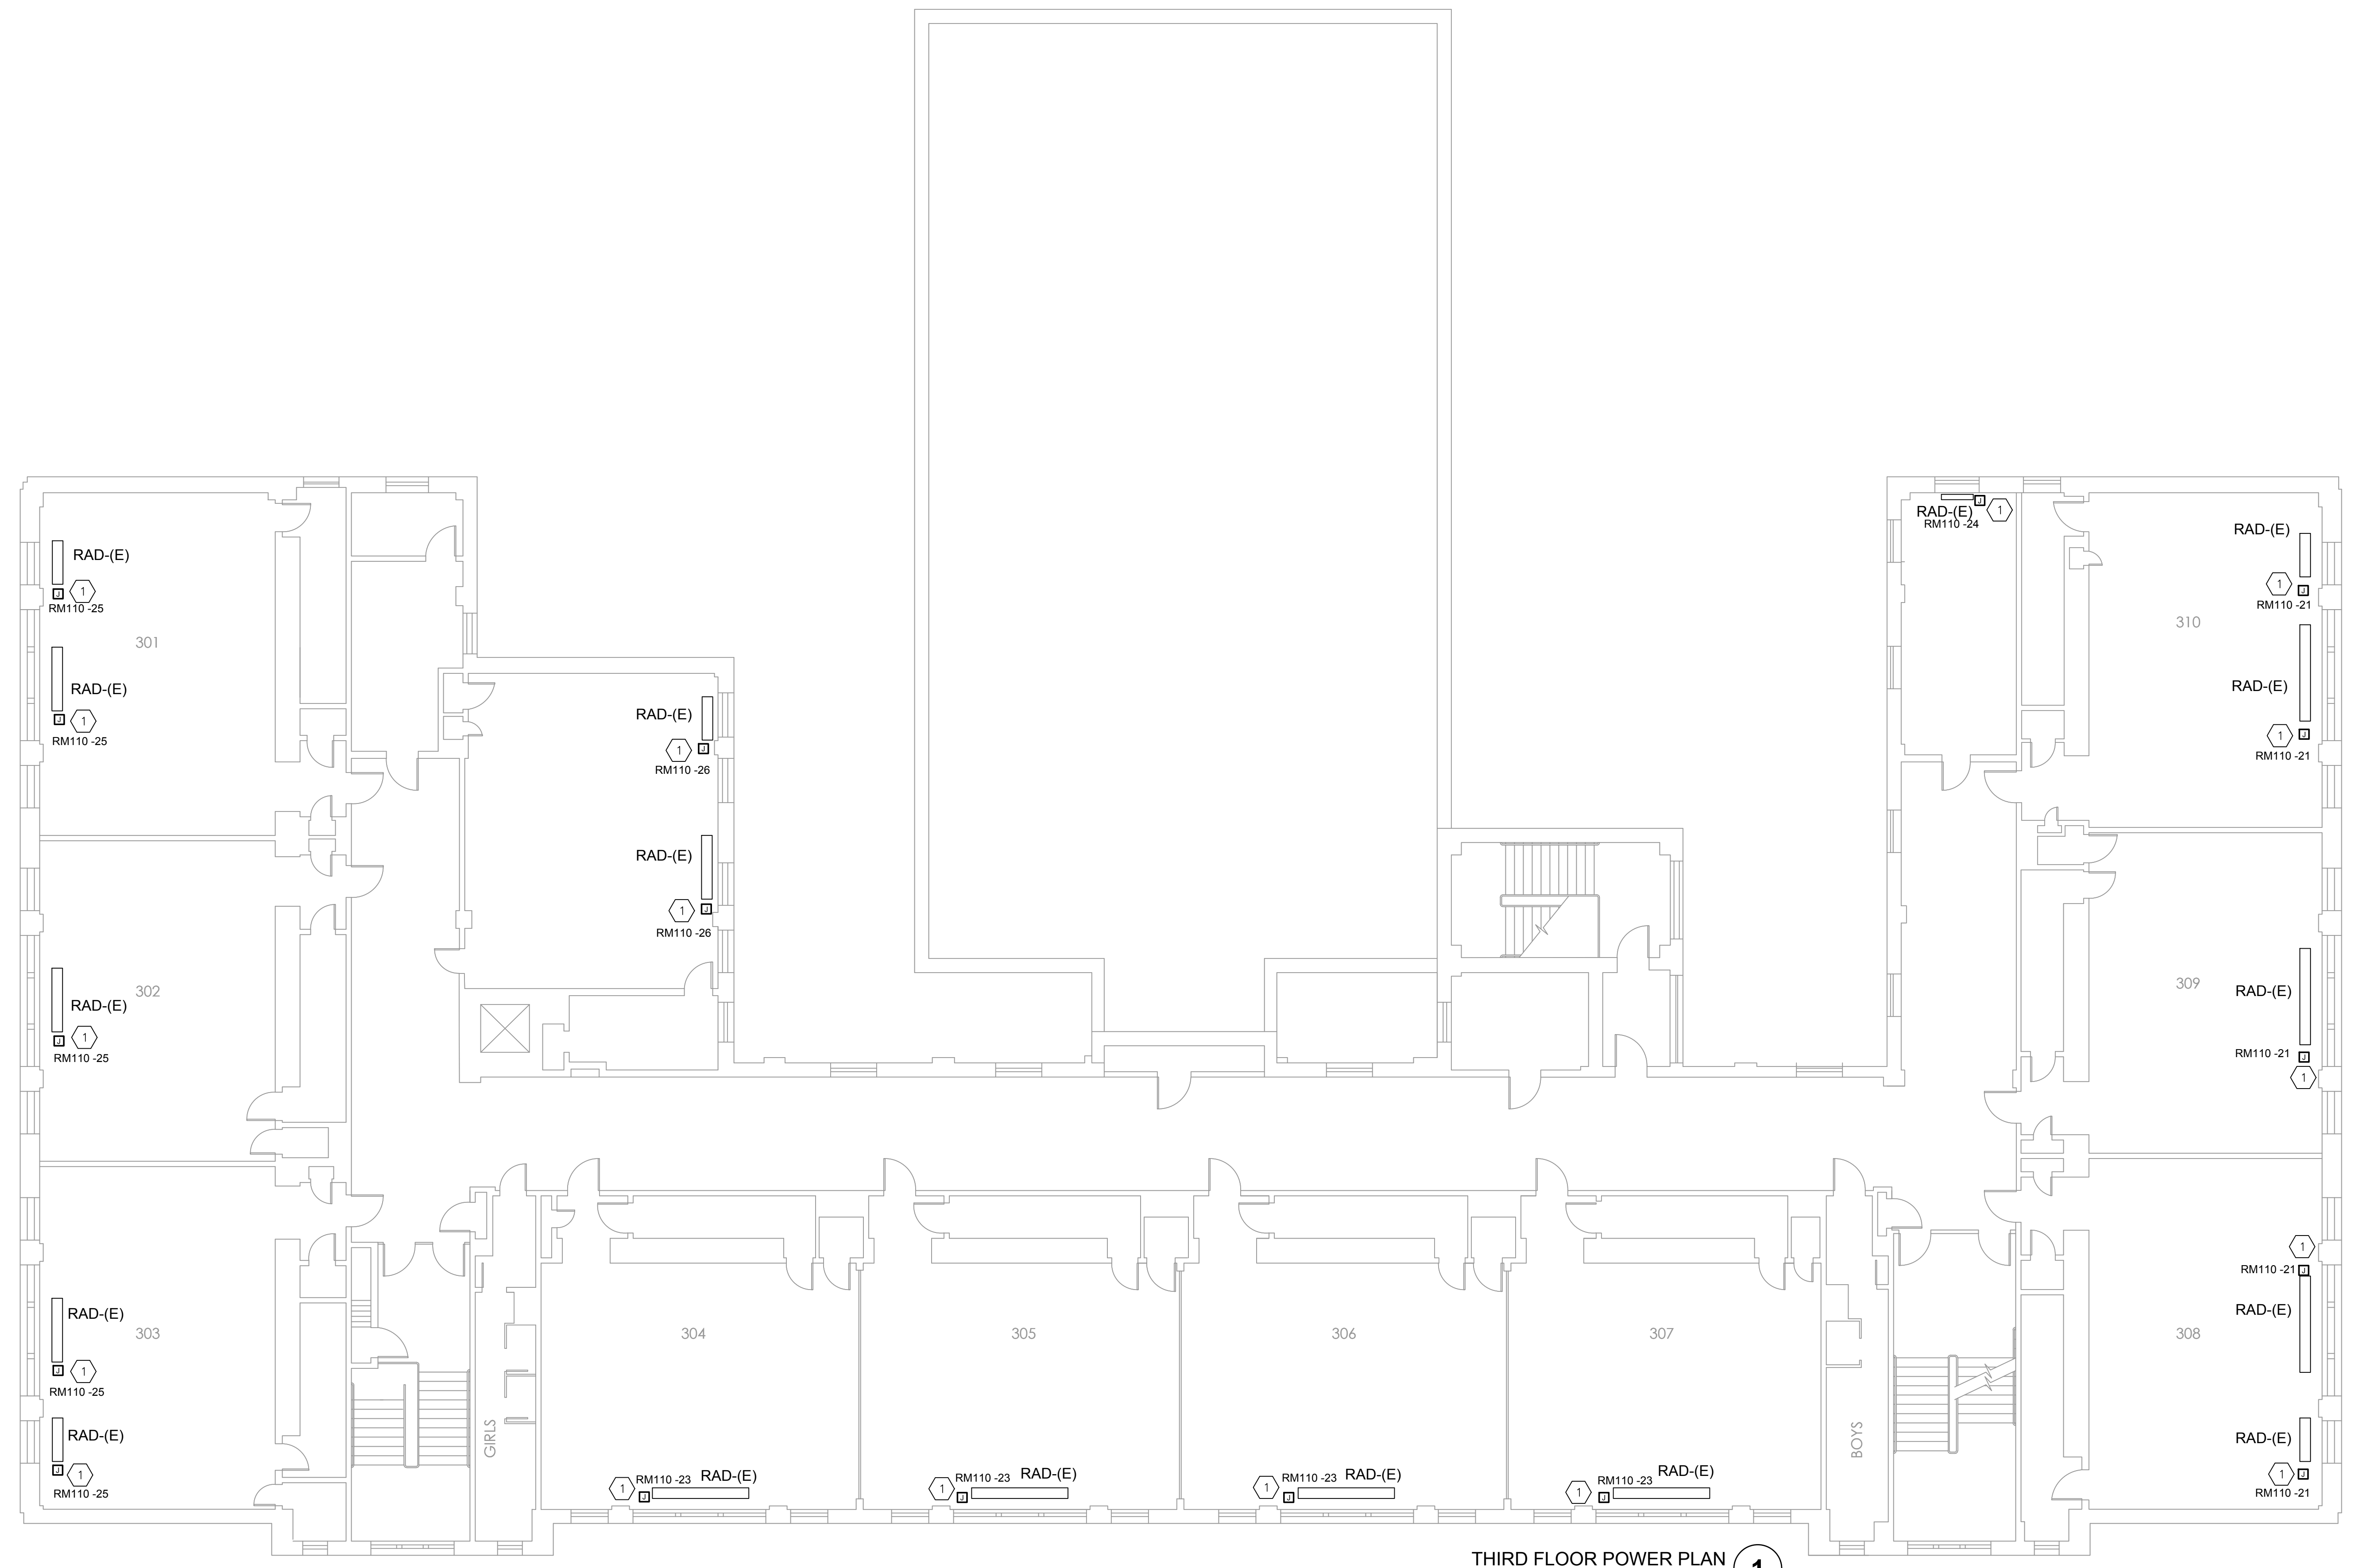

THIRD FLOOR POWER PLAN
1/8" = 1'-0" 1

BID DOCUMENTS SUBMISSION
AUGUST 28, 2019

10		
9		
8		
7		
6		
5		
4		
3		
2	12/13/20	ADDENDUM 1
1	11/11/20	ISSUE FOR BID
NO.	DATE	REVISION

SCHOOL & LOCATION
PENNYPACKER ELEM. SCHOOL
1850 WASHINGTON LANE
PHILADELPHIA, PA 19138

PROJECT TITLE
ATC REPLACEMENT

DRAWING TITLE
THIRD FLOOR POWER PLAN

DRAWING SCALE AS NOTED	
LOCATION NO. 4300	FILE NO. XX
DRAWN BY AD	CHECKED BY NP
8-115C OF 2017 / 18	8-116C OF 2017 / 18

DRAWING NO.
E - 103.0
SHEET 12 OF 12