

# BOARD OF EDUCATION Office of Capital Programs 440 North Broad Street, 3<sup>rd</sup> Floor – Suite 371 Philadelphia, PA 19130

TELEPHONE: (215) 400-4730

#### Addendum No. 003

**Subject:** Rhawnhurst Elementary School- Additions and Renovations

SDP Contracts No. B-070, B-071, B-072 and B-073 of 2019/20

Location: Rhawnhurst Elementary School

7809 Castor Avenue

Philadelphia, Pennsylvania 19152

This Addendum, dated March 30, 2021 shall modify and become part of the Contract Documents for the work of this project. Any items not mentioned herein, or affected by, shall be performed strictly in accordance with the original documents.

#### **BID PROPOSAL FORMS**

REPLACE GC BID PROPOSAL FORM with the attached Revised Bid Proposal Form-GC.

It adds a Unit Price Item for Disposal of Contaminated Soils

#### **DIVISION 0-1 SPECIFICATIONS**

**SECTION 01 1145 - SOILS MANAGEMENT** 

1. ADD SECTION 01 1145 SOILS MANAGEMENT-Attached

#### SECTION 015214 - MODULAR CLASSROOM BUILDING

1. REPLACE SPECIFICATION SECTION 015214 – MODULAR CLASSROOM BUILDING in its entirety. Page 8 was added to the classroom building detailing additional electrical scope to be provided by the general contractor as part of the modular classroom building.

#### **ARCHITECTURAL SPECIFICATIONS**

#### **SECTION 095113 – ACOUSTICAL PANEL CEILINGS**

**1. ADD** 2.8.a.3 as follows:

3.Rockfon LLC, Curvagrid Metal Ceiling System with full range of colors, acoustical characteristics and perforations to match basis of design, 2.8.A.1.

#### PLUMBING SPECIFICATIONS

#### **SECTION 220010 - PLUMBING GENERAL PROVISIONS**

1. Paragraph 1.25 **DELETE** Section 1.25 PLUMBING MATERIAL ALLOWANCES in their entirety.

#### **MECHANICAL SPECIFICATIONS**

#### **SECTION 230010 MECHANICAL GENERAL PROVISIONS**

- **1. REPLACE** paragraphs 1.4.B through 1.4.D with the following:
  - b. Conduit, raceways, boxes and fittings for control wiring shall be provided by the MC but must be installed by an electrical contractor licensed per City of Philadelphia requirements. Materials and installation shall be in accordance with applicable Division 26 sections. All wiring shall be plenum rated.
  - c. Power wiring from panelboard or similar source through all equipment disconnects to motors or heating equipment shall be furnished and installed by the EC.
  - d. Equipment disconnect switches, unless otherwise specified to be supplied by the equipment manufacturer as an integral part of the equipment, shall be furnished and installed by the EC.
- **2. REPLACE** the first sentence of paragraph 1.23.A with the following:
  - This Contractor shall be responsible for all cutting and patching required for demolition or installation of work on this project.

#### **SECTION 230900 ATC SYSTEMS**

- **1. ADD** Monitoring of lon levels in each Bi-polar Ionization system.
- 2. ADD An alarm for low ion levels in each Bi-polar Ionization system per manufacturers recommended ion levels.

#### **SECTION 230510 HVAC PIPING AND SPECIALTIES**

- 1. **REPLACE** The first sentence in Paragraph 2.1B with the following:
  - b. PEX-a Plastic Tubing (Uponor HePEX or equal): ASTM F876, AST F 877. (for piping 3" and smaller)

#### **ELECTRICAL SPECIFICATIONS**

#### **SECTION 260940 Distributed Digital Lighting Control System**

1. ADD Acuity nLight to the list of alternate manufacturers in paragraph 2.1.B.

#### **SECTION 262420 Panelboard Schedules**

- 1. Panel HDPB, ckt #12: **DELETE** 3P.200A breaker for Panel HPV (Photovoltaic System).
- 2. Panel HDPB, ckt #13: **DELETE** 2P.600A breaker for Temporary Modular Classrooms.
- 3. Panel HC1, ckt #41: ADD 15A, 1P in Breaker pole and amp descriptions.
- 4. Panel OS-LBB, ckt #20: ADD 1P.30A breaker with notes 3,5, for "Chiller Heat Trace".

#### **SECTION 2631000 Photovoltaic System**

- **1. ADD** paragraph 2.3.Q as follows:
  - Q. Listings/Certifications:
    - 1. UL 1741
    - 2. IEEE 1547

#### **SECTION 265200 Luminaire Schedule**

1. **DELETE** Note 8 from Fixture Type CH1.

#### **CIVIL DRAWINGS**

#### **DRAWING C-500 Utility Plan**

- 1. **REVISED** SMP-3 6" cast iron storm sewer connection
- 2. **ADD** Modification of existing summit manhole on Chandler Street.
- 3. **ADD** Two (2) 30" pre-cast concrete manholes with gray iron frame and covers.
- 4. ADD Sixty-five (65) L.F. new 18" stormwater conduit with wye connection.

#### ARCHITECTURAL DRAWINGS

#### DRAWING D1.3 - FIRST FLOOR DEMOLITION PLAN UNITS "A & B"

**1. REPLACE** D1.3 in its entirety as part of Addendum #3. Chase walls are being demoed in B109, B110E, B115A, B116A, B117A and B118A.

#### DRAWING A1.4 - FIRST FLOOR PLAN UNIT "A" & A4.1 - LARGE SCALE TOILET PLANS

1. REPLACE A1.4 AND A4.1 in their entirety as part of Addendum #3. Walls are being demolished and replaced as indicated on the revised drawing to allow for plumbing demolition and replacement in the plumbing chases. These walls include B109, B110E, B115A, B116A, B117A and B118A.General contractor shall coordinate for the new installation of new plumbing and penetrations, sleeves etc. through these walls.

#### DRAWING 17.9 - OVERALL FIRST FLOOR - FINISH PLAN

1. ADD notes for tile accent wall at A107, B103, C124, & C125.

#### DRAWING 17.10 - OVERALL SECOND FLOOR - FINISH PLAN

1. ADD notes for tile accent wall at B202, B210, C203, & C204.

#### **STRUCTURAL DRAWINGS**

#### DRAWING S1.9 - S1.14 - STRUCTURAL DRAWINGS

- 1. ADD the following wording to MASONRY LINTEL PLAN NOTE #1:
  - a. Note #1 is for general construction lintels, all mechanical, plumbing, fire protection and electrical sleeves and lintels that need to penetrate NEW walls are to be provided by mechanical, electrical and plumbing contractors for their work as detailed on the MASONRY LINTEL SCHEDULE on S1.9, provided to the general contractor and installed by the general contractor during construction of walls. If mechanical, plumbing and electrical contractor do not coordinate prior to construction of walls with the general contractor they are responsible to cut, install and patch walls for the installation of their sleeves, lintels and work.

#### **MECHANICAL DRAWINGS**

#### DRAWING M0.0 LEGEND, ABBREVIATION AND NOTES

- **1. ADD** the following General Note:
  - a. All mechanical sleeves and lintels that need to penetrate **NEW** walls are to be provided by mechanical contractor for their work as detailed on the MASONRY LINTEL SCHEDULE on S1.9, provided to the general contractor and installed by the general contractor during construction of walls. If mechanical contractor does not coordinate prior to construction of walls with the general contractor, the contractor is responsible to cut, install and patch walls for the installation of their sleeves. lintels and work.

#### DRAWING MO.0 - LEGEND, ABBREVATIONS AND NOTES

1. REPLACE drawing with the attached.

#### DRAWING M2.1 - FIRST FLOOR UNITS "A" & "B" HVAC

1. **REPLACE** drawing with the attached.

#### DRAWING M2.8 - FIRST FLOOR UNIT "C" HVAC PIPING

1. ADD a Thermostat in room "Girls C124"

#### DRAWING M2.9 - SECOND FLOOR UNITS "A" & "B" HVAC PIPING

1. **REPLACE** drawing with the attached.

#### DRAWING M2.12 - ENLARGED MECHANICAL PLAN

1. REPLACE drawing with the attached.

#### PLUMBING DRAWINGS

#### DRAWING P0.0 PLUMBING SYMBOLS, NOTES

- **2. ADD** the following General Note:
  - b. All plumbing sleeves and lintels that need to penetrate NEW walls are to be provided by plumbing contractor for their work as detailed on the MASONRY LINTEL SCHEDULE on S1.9, provided to the general contractor and installed by the general contractor during construction of walls. If plumbing contractor does not coordinate prior to construction of walls with the general contractor, the contractor is responsible to cut, install and patch walls for the installation of their sleeves, lintels and work. Plumbing contractor is also responsible for their own cutting and patching of existing walls and installation of sleeves, lintels to allow for their work.

#### **DRAWING P0.2 - SITE PLAN**

- 1. **REVISE** drawing notes 6 and 7 to read as follows:
  - 6. PLUMBING CONTRACTOR SHALL RUN 4" SANITARY PIPING TO MODULAR BUILDING (FOR EXTENSION BY MODULAR BUILDING CONTRACTOR). COORDINATE EXACT LOCATION AND INVERT OF PIPING WITH ALL OTHER TRADES AND MODULAR BUILDING CONTACTOR. WHEN MODULAR BUILDING IS REMOVED FROM THE SITE IN PHASING PLAN, REMOVE ALL PIPING SERVING MODULAR BUILDING BACK TO THE BRANCH CONNECTION AT THE MAIN AND CAP.
  - 7. PLUMBING CONTRACTOR SHALL RUN 2" DOMESTIC COLD WATER PIPING TO MODULAR BUILDING (FOR EXTENSION BY MODULAR BUILDING CONTRACTOR). COORDINATE EXACT LOCATION OF PIPING WITH ALL OTHER TRADES AND MODULAR BUILDING CONTRACTOR. WHEN MODULAR BUILDING IS REMOVED FROM THE SITE REMOVE ALL PIPING SERVING MODULAR BUILDING BACK TO THE BRANCH CONNECTION AT THE MAIN AND CAP INCLUDING ALL BRANCH PIPING INSIDE BUILDING.

#### DRAWING P1.0 - BASEMENT UNIT A & B PLUMBING DEMOLITION

- **1. ADD** removal of all existing piping insulation from all existing domestic water piping and prepare piping for replacement insulation.
- 2. ADD removal of all existing domestic water branch piping back to the main and cap all piping that is not being reused in the new plumbing system.

#### DRAWING P1.1 - BASEMENT UNIT C PLUMBING DEMOLITION

- **1. ADD** removal of all existing piping insulation from all existing domestic water piping and prepare piping for replacement insulation.
- 2. ADD removal of all existing domestic water branch piping back to the main and cap all piping that is not being reused in the new plumbing system.

#### DRAWING P2.0 - BASEMENT UNIT A & B PLUMBING

**1. ADD** new insulation as specified, insulation shall be furnished and installed for all existing domestic water piping.

#### DRAWING P2.1 - BASEMENT UNIT C PLUMBING

**1. ADD** new insulation as specified, insulation shall be furnished and installed for all existing domestic water piping.

#### DRAWING P2.5 - SECOND FLOOR UNIT C PLUMBING

- **1.** Refer to exterior wall at Faculty Planning C207 at overflow storm piping. Drawing note at exterior shall be Note 10. **ADD** drawing note 10 to drawing to read as follows:
  - 10. RUN OVERFLOW PIPING ABOVE CEILING AND TERMINATE OUTSIDE BUILDING AT EXTERIOR WALL WITH OVERLFOW STORM SPOUT OSS-1.
- 2. Refer to Science Classroom C210. Revise the domestic water piping to the sink on the right to be run in a similar manner as the sanitary piping along the wall at the back of the casework.
  DELETE the vent piping from the sink on the right. REVISE the vent piping size to be 2" from the sink on the left.

#### FIRE PROTECTION DRAWINGS

#### **DRAWING FP1.0 FIRE PROTECTION ZONING PLANS**

- **1. ADD** the following General Note:
  - c. All fire protection sleeves and lintels that need to penetrate **NEW** walls are to be provided by plumbing contractor for their work as detailed on the MASONRY LINTEL SCHEDULE on S1.9, provided to the general contractor and installed by the general contractor during construction of walls. If plumbing contractor does not coordinate prior to construction of walls with the general contractor, the contractor is responsible to cut, install and patch walls for the installation of their sleeves, lintels and work. Plumbing contractor is also responsible for their own cutting and patching of existing walls and installation of sleeves, lintels to allow for their work.

#### **ELECTRICAL DRAWINGS**

#### **DRAWING E0.0 SYMBOLS**

- **1. ADD** the following General Note:
  - d. All electrical sleeves and lintels that need to penetrate **NEW** walls are to be provided by electrical contractor for their work as detailed on the MASONRY LINTEL SCHEDULE on S1.9, provided to the general contractor and installed by the general contractor during construction of walls. If electrical contractor does not coordinate prior to construction of walls with the general contractor, the contractor is responsible to cut, install and patch

walls for the installation of their sleeves, lintels and work. Electrical contractor is also responsible for their own cutting and patching of existing walls and installation of sleeves, lintels to allow for their work.

#### **DRAWING E0.2 - SITE PLAN**

1. REPLACE drawing with the attached.

#### DRAWING E3.6 - ROOF POWER

1. REPLACE drawing with the attached.

#### DRAWING E5.2 - FIRST FLOOR FIRE ALARM

- 1. ADD one TS (tamper switch) and one FS (flow switch) in Custodial B102.
- 2. ADD two TS (tamper switches) and two FS (flow switches) in Custodial C127.
- **3. ADD** weatherproof speaker/strobe with Drawing Note 1 and 2 tags on exterior wall outside of Principal B101B office.
- **4. DELETE** FMP fire alarm addressable module from the elevator.
- **5. ADD** Drawing Note 2 as follows: Alarm on sprinkler water flow.

#### DRAWING E5.3 - SECOND FLOOR FIRE ALARM

- 1. ADD one TS (tamper switch) and one FS (flow switch) in pipe chase outside of Boys B202.
- 2. ADD one TS (tamper switch) and one FS (flow switch) in Custodial C201.

#### **DRAWING E8.2 - POWER RISER DIAGRAM**

1. **REPLACE** drawing with the attached.

#### **DRAWING E9.3 – ELECTRICAL DETAILS**

1. DELETE each instance of "and Wireless Network Bridges" from details on this Drawing.

# BIDDER QUESTIONS SUBMITTED TO DATE & RESPONSES ARE AS FOLLOWS:

1. Restrooms B115/C, B116B/C, B117B/C, B118B/C, B110E, B109 require that the behind the wall plumbing risers be removed and replaced, drawing P1.2. The walls are not shown to be removed on drawing D1.3. Who will be responsible for cutting and patching of the wall to permit the plumbing demolition and installation of the new work? This question will apply any locations not specifically mentioned above?

**Answer**: Yes, the plumbing is to bring the new underground water and sanitary connections to the trailer to a single point connection for the modular trailer supplier to connect to under the general construction contract. General and plumbing contractors are required to coordinate these connections. After the trailers are removed from the construction site as part of the phasing, plumbing and electrical contractors will be required remove their lines to the modular and replace soil for site contractor to preform final paving in these areas.

2. Will the new underground water and sanitary connections to the modular trailers be single point connection?

**Answer**: Yes, the plumbing is to bring the new underground water and sanitary connections to the trailer to a single point connection for the modular trailer supplier to connect to under the general construction contract. General and plumbing contractors are required to coordinate these connections. After the

trailers are removed from the construction site as part of the phasing, plumbing and electrical contractors will be required remove their lines to the modular and replace soil for site contractor to preform final paving in these areas.

3. Does the crawl space extend under the existing kitchen?

**Answer**: Yes, as per EX1.0 EXISTING BASEMENT FLOOR PLAN the crawl space does extend under the existing kitchen.

4. Will the crawl space extend under the new kitchen addition?

**Answer**: No as per floor plans and sections the crawl space will not extend under the new kitchen addition.

5. Will temporary lighting be installed in the crawl space?

**Answer**: This is a contractor means and methods for temporary conditions between the prime contractors. The crawl space currently has lighting as shown on the E1.1 that is being replaced with new lighting. It is assumed that the old lighting will be kept in place until the new lighting is installed and operational, however, this will be a task for the prime contractors to coordinate among each other or provide temporary lighting.

6. Drawing notes referenced on drawing S1.9 thru S1.14, indicate that the Contractor for General Construction is responsible for Masonry Lintels and Masonry Reinforcing for mechanical penetrations.

Please confirm, is the GC likewise responsible for wall openings (penetrations) for mechanical systems going thu the masonry walls?

**Answer**: ALL contractors are to reference notes added to S1.9 through S1.14 and M0.0, P0.0, FP1.0 and E0.0 that define each contractors responsibilities in both new and existing wall construction.

7. The summary of work for Contract B-070C of 2019/2020 GC: Item 22 indicates that the General Contractor is responsible to make utility connections including water, electrical and IT to the Modular Classroom Building (MCB). Please consider limiting the GC's responsibility to site water services to within 5' outside the MCB building footprint only. It will be more cost effective to have the Electrical Prime provide the service, final connections, IT connections and related disconnections – and the Plumbing Prime all water and sewer connections/disconnections.

**Answer**: See end of REPLACED Specification Section 015214 – Modular Classroom Building. Electrical and plumbing will bring water, power, IT and sanitary to one location for modular classroom building installer under the General Contractor. Due to exact layout and number of connections that are only known to each MCB fabricator/installer no change can be made to the approach.

Refer to Drawing P0.2 for water and sewer services to the modular classrooms. Refer to E0.2 and E8.2 for electrical (power) service to the modular classrooms. Refer to E0.2 for conduit pathway provided for low-voltage systems from the modular classrooms to the Rhawnhurst ES building (wiring and connections to be provided by the modular contractor).

8. Please clarify which prime has the scope of providing the security bollards shown on drawing E0.2 note 13 - GC or EC?

**Answer**: The EC shall provide bollards at the padmount transformer as shown on E0.2.

9. Drawing note 8 on drawing E0.2 does not appear to be shown in plan. Please confirm this note can be ignored.

**Answer**: Chiller heat trace circuit with Note 8 reference added on Drawing E0.2. See ELECTRICAL DRAWINGS revisions above.

10. Specification section 260940-2.8 specifies (3) different photocells - open loop, closed loop, and dual loop. It is not clear from the specs or drawings which type we are to provide. Please clarify which type are to provide for this project.

**Answer**: Provide open loop photosensors unless otherwise recommended by the lighting controls system manufacturer.

11. Please confirm the motorized shade scope for the EC only includes install and wiring per detail 8 on E9.1. Please confirm all devices will be furnished by the GC.

**Answer**: Motorized shades, controllers, and switches are furnished by the GC. Shades and shade controllers shall be installed by the GC; control switches shall be installed by the EC. All wiring and raceways shall be provided by the GC.

12. Specification section 281600-2.1C lists (3) different motion detectors. It is unclear from the specs and drawings which type of motion sensor should be provided in each area. Please indicate which type should be specified for each location.

**Answer**: The Intrusion Detection System manufacturer shall provide the motion sensor type(s) best suited to provide optimal coverage of each space.

13. Specification section 262817 for the elevator disconnect is mentioned in note 5 on drawing E8.2 and mentioned in spec 260180, but this specification section has not been provided. Please provide this specification or clarify design. Please confirm the elevator disconnect should be a 100A-3P 480V fused safety switch in a NEMA 1 enclosure with 70A fuses.

**Answer**: Specification 262817 elevator disconnect switch is not applicable. Please provide a 3P.100A, 480V fused disconnect switch with auxiliary contact. Assume 70A

fuses for bidding purposes. Final fuse size will be based on approved elevator submittal.

14. Luminaire Note 8 in specification section 265200 for fixture types CH1 and RD4 states to include ceiling slope adapters, but sloped ceiling locations have not been indicated on the electrical plans. Please indicate the areas where sloped ceiling adapters are required.

**Answer**: Note 8 is not applicable, and will be deleted, for Type CH1 fixtures. Provide sloped ceiling adapters for Type RD4 mounted in curved ceiling clouds in Cafeteria C105.

15. A fire alarm addressable relay is shown outdoors at the generator on drawing E0.2, but addressable relays are not rated for outdoors. Please confirm it is acceptable to locate this relay inside as close to the generator as possible.

Answer: This is acceptable.

16. The lighting control details on E9.3 include a note at the room controllers to provide cables to wireless network bridges. It is our understanding that the design intent is to have lighting controls that are local/standalone for each room and <u>not</u> networked together. Please confirm our understanding is correct and that we <u>do not</u> need to provide network bridges or head end equipment to control rooms from a computer workstation. If we do need to provide network bridges and headend equipment, please provide details and specs for this design.

**Answer**: Lighting controls for this project are non-networked. Wireless network bridges are not required. References to network bridges will be removed from E9.3 details.

17. M2.11 - There is supply and return duct on the roof, but no outdoors insulation spec. Please provide if this is lined duct or to be exterior insulated.

**Answer:** Refer to Paragraph 2.3 in specification section 230890 for premanufactured exterior ductwork product. This product shall be used for all exterior ductwork.

18. What is the existing Fire Alarm System at Rhawnhurst?

**Answer:** The main Fire Alarm System is a 120V, 1948 vintage, manual system with bell annunciation; manufacturer unknown. An existing EST FireShield Plus fire alarm panel monitors duct detectors on two air handling units.

19. We need lighting Fixture Panel Schedule we went through all drawings and can't find.

**Answer:** Luminaire schedules, panelboard schedules and lighting control schedules are found in the specifications as follows:

#### **ATTACHMENTS**

This Addendum includes the following attachments:

#### **Bid Proposal Forms**

REVISED BID PROPOSAL FORM-GC

#### **Project Specifications**

SECTION 01 1145 SOILS MANAGEMENT SECTION 015214 - MODULAR CLASSROOM BUILDING

#### **Civil Drawings**

Drawing C-500 UTILITY PLAN (Revised for Addendum #3)

#### **Architectural Drawings:**

DRAWING D1.3	FIRST FLOOR DEMOLITION PLAN UNITS "A & B"
DRAWING A1.4	FIRST FLOOR PLAN UNIT "B"
DRAWING A4.1	LARGE SCALE TOILET PLANS
DRAWING 17.9	OVERALL FIRST FLOOR – FINISH PLAN
DRAWING 17.10	COLOR SECOND FLOOR – FINISH PLAN

#### **Mechanical Drawings**

M0.0 – LEGEND, ABBREVATIONS AND NOTES
M2.1 – FIRST FLOOR UNITS "A" & "B" HVAC
M2.9 – SECOND FLOOR UNITS "A" & "B" HVAC PIPING
M2.12 – ENLARGED MECHANICAL PLAN

#### **Electrical Drawings**

DRAWING E0.2 SITE PLAN
DRAWING E3.6 ROOF POWER
DRAWING E8.2 POWER RISER DIAGRAM

**END OF ADDENDUM #003** 

# BID PROPOSAL FORM-Revised MAJOR ADDITION and RENOVATIONS

at

#### RHAWNHURST ELEMENTARY SCHOOL

#### Contract No. B-070 C of 2019/2020 General Construction

TO:	The School District of Philadelphia Board of Education	OWNER
	Office of Capital Programs The School District of Philadelphia 440 North Broad Street Third Floor - Suite 371 Philadelphia, PA 19130-4015	ADDRESS
FROM	l:	CONTRACTOR ADDRESS
		CITY/STATE CONTACT NAME PHONE NO.
BASE	CONTRACT PROPOSAL:	
the site Contra and Cagrees as ne	1. Having become completely familiar with the local form of Work at the place where Work is to be executed, and se conditions as they currently exist, and having carefully exist Documents prepared for this project, together with an contract Documents as listed hereinafter, the Undersigns to provide all labor, materials, plant, equipment, transposes and/or required to execute all of the Work of the ments for the above cited Contract for the lump sum contract.	having carefully examined examined the Bidding and yellow Addenda to such Bidding and proposes and portation and other facilities described by the Contraction of:
(\$	), said amount being here	Dollars
θase lapplica	Proposal Amount. Base proposal Amount includes Unit	Price Items listed below, in

**BID ALTERNATES (Not applicable to this Contract – No Alternates)** 

#### **UNIT PRICES:**

#### **UNIT PRICE NO. 1: EXCAVATION AND DISPOSAL OF CONTAMINATED SOILS**

PA DEP Clean Fill	Regulations, includ nce with Section 01	ing all costs of excavation	nated, in accordance with on, stockpiling, testing and MENT, as directed by the
2. Unit of Measurer	ment: per ton (T)		
3. <u>Payment:</u> Payme 01 1600-UNIT PRI		he actual quantities in ac	ccordance with Section
4. Estimated Quant	tity included in Base	e Bid: 400 TONS	
5. <u>Unit Price Calcul</u>	ation (to be include	ed in Base Bid Amount):	
400 TONS @ \$			per TON =
\$			Total*
*This amount incl	uded in Base Bid	Amount	
<u>ACKNOWLEDGEN</u>	MENT OF RECEIPT	Γ OF ADDENDA:	
2. The l number and date a	_	•	ollowing Addenda (list by
Addendum No.	<u>Date</u>	Addendum No.	<u>Date</u>
	<del></del>		

**TIME OF COMPLETION:** 

3. The Undersigned agrees to Substantially Complete all Work under this Contract within the time periods specified in Division 1, General Requirements, Section 00 1300 entitled "Time of Completion, Milestones and Phasing or Sequencing Requirements".

#### **INSURANCE**:

4. All Bidders are instructed to refer to Article GC-11 of the General Conditions. All Contractors or Subcontractors bidding Work on the Project shall include in their bids the costs of Workers Compensation and Employer's Liability Insurance, Commercial General Liability Insurance, Automobile Liability Insurance, Excess Umbrella Liability Insurance (Commercial Umbrella Liability Insurance) and any other types of insurance identified in Division 1- General Requirements, Section 01200 (or 01 1200) entitled "Special Insurance Requirements".

#### **LIQUIDATED DAMAGES**:

- 5. Upon failure by the Contractor to achieve Substantial Completion within the time specified in Article GC-8 of the General Conditions from the Date of Commencement as set forth in the Notice to Proceed, the Contractor shall pay to the School District, as liquidated damages and not as a penalty, the sum of One Thousand Dollars (\$1,000.00) per day for each consecutive calendar day of delay until such time as Substantial Completion of the Work is achieved.
- 6. In addition, the Contractor shall be responsible for and pay for the cost of completion of construction of the Work, as well as for any and all additional charges of the School District, Architect/Engineer, other Project Contractors, and any other Consultants to the School District relating to the Contractor's failure to achieve Substantial Completion on a timely basis, including, but not limited to, delay damages, disruption damages, acceleration costs or expenses, investigative expenses, consulting fees, experts' fees, and attorneys' fees.
- 7. The Contractor and the School District agree that the amounts so fixed herein as liquidated damages are reasonable forecasts of just compensation for the harm that will be caused to the School District by the Contractor's breach.

#### **GENERAL STATEMENT**:

- 8. The Undersigned declares that the person or persons signing this Proposal is/are fully authorized to sign on behalf of the firm listed and to fully bind the firm listed to all the Proposal's conditions and provisions thereof.
  - 9. It is agreed that the Undersigned has complied or will comply with all

requirements of local, state, and federal laws, and that no legal requirement has been or will be violated in making or accepting this Proposal, in awarding the Contract to it and/or in prosecution of the Work.

·
10. Bid Security in the amount of ten percent (10%) of the Base Bid, plus all additive Alternates Proposal amounts, is attached hereto and made a part hereof, without endorsement, in the sum of Dollars (\$), which shall become the property of the School District in the event the Contract and Performance Bond and Labor and Materialmen's Bond are not executed within the time set forth, as liquidated damages.
11. The Undersigned further agrees within five (5) calendar days from date of Notice of Acceptance of this Proposal or Contract award, to sign and deliver to the School District, all required copies of the School District/Contractor Agreement, the Performance Bond, the Labor and Materialmen's Bond, and the Maintenance Bond, in the forms included in the Bidding Documents, and the policies of insurance or insurance certificates as required by the General Conditions. In case the undersigned fails or neglects to deliver within the specified time the School District/Contractor Agreement, the Performance Bond, the Labor and Materialmen's Bond, and the Maintenance Bond, and the insurance policies or certificates, all as aforesaid, the undersigned shall be considered as having abandoned the Contract, and the Bid Bond accompanying this Proposal shall be forfeited to the School District by reason of such failure on the part of the undersigned, as liquidated damages and not as a penalty.
12. The Undersigned further agrees that the Bid Security may be retained by the School District and shall remain with the School District until the School District/Contractor Agreement has been signed and delivered to the School District and the Performance Bond, the Labor and Materialmen's Bond, and the Maintenance Bond, and insurance policies or certificates have been made and delivered to the School District.
Respectfully submitted thisday of, 201
Individual Proprietorship or Partnership
If Contractor is an individual proprietorship or is a partnership, sign here:
(Trade Name of Firm)
By: By: (SEAL) (Owner or Partner)

#### Corporation

If Contractor is a corporation, s	ign here:
ATTEST:	(Name of Corporation)
By: (Secretary or Treasurer)	By: (SEAL) (President or Vice President)
(CORPORATE SEAL)	

Signature by anyone other than the President or Vice President and the Secretary or Treasurer of the Corporation must be accompanied by a power of attorney, executed by the proper corporate officers under the corporate seal indicating authority to execute this Bid.

#### **SECTION 01 1145 - SOIL MANAGEMENT**

#### 3.1 EXCAVATED SOIL MANAGEMENT

- A. The Contractor shall remove, and recycle or dispose of all excess soil. All disposal of regulated soil/fill material shall be by the Contractor in accordance with local, State, and Federal regulations. Regulated material disposal shall be to an Owner-approved recycling method, an approved recycling facility, or an approved non-hazardous landfill. The removal and subsequent recycling or disposal of all excess soil needs to be managed in accordance with the PADEP Management of Fill Policy, effective January 1, 2020
- B. The Contractor is responsible for all testing required by the landfill or other site selected for recycling or disposal of excavated soil
- C. The excavation activities of known or suspected contaminated soil/fill material will be monitored by the Project Environmental Engineer on a continuous basis to advise the Contractor regarding the segregation of excavated soil. The Project Environmental Engineer is required to be onsite during all excavation activities of known or suspected contaminated soil/fill material.
- D. The Contractor shall stage all excavated soil, as advised by the Project Environmental Engineer to be potentially contaminated, on six-mil thick polyethylene plastic, and cover with same, pending analysis and subsequent disposal/recycling. A six- to eight-inch berm shall be placed at the perimeter of the staging area to prevent run-on/run-off.
- E. Soil samples shall be collected from the stockpiles by the testing entity selected by the Contractor and samples submitted to a PADEP-certified analytical laboratory for analyses. The Project Environmental Engineer will receive results back from the laboratory on a standard laboratory turnaround basis, typically 10 business days. The Contractor cannot claim a delay while soil samples are being analyzed. Expedited turnaround may be arranged for by the Contractor at no additional cost to the Owner.
- F. Soil that meets the definition of a non-hazardous soil as defined within the Resource Conservation Recovery Act, Title 40 of the CFR parts 239 through 259 that cannot be reused onsite, will be sampled and analyzed by the Contractor in order to obtain disposal approval at a landfill or recycling facility. Sampling and analysis of the soil will be at the Contractor's expense at no additional cost to the Owner.
- G. The Contractor shall provide a per ton Unit Price to transport and dispose of an estimated 400 tons of soil that does not meet the criteria to be certified as PADEP Clean Fill but meets the definition of a non-hazardous soil as defined within the Resource Conservation Recovery Act, Title 40 of the CFR parts 239 through 259.
- H. All excess soil will be recycled or disposed off-site in a manner consistent with all applicable local, State, and Federal regulations. The disposal or recycling facility shall be approved by the Owner before the excess soil is transported off-site. The name of the proposed disposal or recycling facility is to be submitted to the Owner a minimum of 7 days prior to disposal.
- I. The Contractor must follow the recommendations concerning handling of excavated excess Soil onsite as presented in PADEP's Management of Fill Policy, dated January 1, 2020.
- J. In the event suspected contaminated soil is encountered that is unrelated to the excess soil described, the Contractor will notify the Owner. Following notification, the Owner will provide the

# RHAWNHURST ADDITIONS AND RENOVATIONS SDPP CONTRACTS NO. B-070C, B-071C, B-072C, B-073C OF 2019/20

Contractor with the necessary procedures to manage the handling and disposal of the suspected contaminated soil

#### 3.2 SPECIAL CONDITIONS FOR SOIL MANAGEMENT

A. The following Special Conditions apply to all Work to be conducted in order to complete this project:

- 1. The Contractor shall make all required notifications and take all necessary precautions to ensure against damage including but not limited to access roads, sidewalks and driveways, utilities and structures. Any damage to such items shall be repaired or replaced by the Contractor at no additional cost to the Owner.
- 2. The use of burning at the Site for the disposal of refuse and debris will not be permitted.
- 3. The Contractor will furnish and install all fencing, barricades, warning signs, lights, etc., wherever necessary to protect the public during work on this project. Fencing, barricades, and other protection devices will remain in place until all tasks associated with the contract are completed.
- 4. Procedures used to accomplish the Work shall be as specified herein unless submitted to the Project Environmental Engineer for approval prior to project implementation.
- 5. Any alternative procedures submitted for approval shall provide for safe conduct of Work, careful removal and disposition of materials specified, and protection of property. The procedures submitted shall include a detailed description of the methods and equipment to be used for each operation, and the sequence of operations.
- 6. All disposal or recycling shall be by the Contractor in accordance with local, State, and Federal regulations. Excess soil shall be disposed at an Owner-approved recycling facility, or an owner approved landfill. The name of the proposed disposal or recycling facility is to be submitted to the Owner a minimum of 7 days prior to disposal.
- 7. The Contractor shall install appropriate measures to control surface water run-on to and run-off from the stockpiled excess soil, and from any open excavation. Engineering controls and best-management practices must be utilized to prevent stormwater runoff from the stockpiled soil.
- 8. The Contractor shall maintain the job site in a neat and orderly condition. This includes the daily removal of rubbish, waste, tools, equipment, and material not required for the Work in progress.
- 9. The Contractor assumes all liability for soil that is transported off-site and shall indemnify and hold Owner harmless for improper transportation and disposal that is not in accordance with local, State and/or Federal regulations.

#### 3.3 TEST DOCUMENTATION AND REPORTING

- A. The Contractor shall document all testing and provide copies to the Owner and authorities having jurisdiction. Test records shall include:
- 1. Date and time of tests;
- 2. Name of person performing the tests;

# RHAWNHURST ADDITIONS AND RENOVATIONS SDPP CONTRACTS NO. B-070C, B-071C, B-072C, B-073C OF 2019/20

- 3. Location and depth of samples;
- 4. Names of any inspectors present;
- 5. Field observations and field screening procedures;
- 6. Daily field notes, including photographs;
- 7. Test procedures followed;
- 8. Test results:
- 9. A narrative describing how field tests were completed and sampling locations were chosen.
- B. The Contractor shall provide documentation to the Owner for all testing before the excess soil Is transported off-site and with Contract close-out documentation to the Owner. The test documentation shall include, but not be limited to, laboratory analytical reports, laboratory chainof custody, Contractor field notes and daily logs.
- C. Laboratory analytical testing shall be completed by a National Environmental Laboratory Accreditation Program (NELAP) accredited laboratory.
- 3.4 DISPOSAL OR RECYCLING DOCUMENTATION
- A. The Contractor shall provide the following to the Engineer and Owner upon completion of the Work:
- 1. Excess excavated soil disposal or recycling documentation;
- 2. Disposal facility profile sheets or acceptance forms;
- 3. PADEP Form U (if applicable); Manifests; and, Bills of Lading.
- 3.5 FUGITIVE EMISSIONS
- A. The following additional Special Conditions apply to all Work to be conducted in order to complete this project:
- 1. The Contractor shall incorporate means to prevent the carryout or track out of soil and other materials from the area where work is being performed onto undisturbed areas of the School property and onto areas of public access, including but not limited to road sand sidewalks.
- 2. The Contractor shall incorporate appropriate means to prevent fugitive dust emissions resulting from all construction activities, including but not limited to excavation, demolition, soil placement, stockpiling and transportation.
- 3. The Contractor is solely responsible for preventing the generation of fugitive dust emissions resulting from wind and other natural and man-made forces. The Contractor shall control the speed of vehicles and equipment moving on the site as it relates to safety and the creation of fugitive dust and shall make appropriate use of wind screens and dust suppressants.
- 4. No liquid dust suppressant other than water shall be used without the specific advanced approval of the School District. Information to be submitted to the School District for approval of any dust suppressant, other than water, shall include the product specification, manufacturer's

# RHAWNHURST ADDITIONS AND RENOVATIONS SDPP CONTRACTS NO. B-070C, B-071C, B-072C, B-073C OF 2019/20

usage instructions, information on environmental impacts associated with usage and approvals or certifications related to appropriate and safe usage for ground application.

5. Any fugitive dust and/or soil materials which leaves the site in an uncontrolled form shall be immediately cleaned up by the Contractor to the satisfaction of the School District. At the discretion of the School District, cleanup may incorporate on-site or off-site environmental sampling, performed by the School District at the Contractor's sole expense.

#### SECTION 01 5214 - MODULAR CLASSROOM BUILDING

#### PART 1 GENERAL

#### 1.01 SECTION INCLUDES

- A. Temporary classrooms.
- B. Maintenance and removal.

#### 1.02 UTILITIES

- A. Provide temporary electricity connection from local utility.
  - 1. Owner will pay for electric connection and usage if they are billed directly by the utility.

#### 1.03 SUBMITTALS

- A. Product Data: Provide data on profiles, component dimensions, finishes, and specialties.
- B. Site Plan: Showing areas for temporary construction and classrooms.

#### 1.04 QUALITY ASSURANCE

- A. Manufacturer Qualifications: Company specializing in manufacturing products specified in this section, with not less than three years of experience.
- B. Installer Qualifications: Company specializing in performing work of the type specified and with minimum three years of experience.

#### PART 2 PRODUCTS

#### 2.01 PERFORMANCE REQUIREMENTS

- A. General Contractor shall provide a Modular Classroom Building (MCB) on site as located on Phasing Drawings PH.1, PH.2 and PH.3.
  - 1. Basis of Design Manufacturer: MOBIEASE MODULAR SPACE, INC.
    - a. Contact: Murph Barton
      - Ph: 856-686-9600
      - 856-686-9240 (fax)
      - murph@mobileasemodular.com
  - 2. Main Classroom Building shall include
    - a. Overall Dimensions: approximately 124'-5" long X64'-0"
    - b. (8) eight classrooms.
    - c. Include separate boys and girls restrooms, each bathroom shall have 5 water closets as shown on PH.3 and 4 sinks
    - d. (1) Separate Single Occupancy Toilet.
    - e. Ramps and Stairs as required to accommodate modular on site at approximate elevation of 121'-0" on slope of site as located on Phasing Drawings.
    - f. Foundation system to accommodate Modular Classroom Building.
    - g. Contractor shall be responsible coordinate and to make final electrical, and plumbing connections brought to the MCB as stub up connections.
    - h. All work shall be designed to meet applicable building codes for the City of Philadelphia.
  - 3. MCB shall be designed to meet Specifications provided in following MOBILEASE

# RHAWNHURST ELEMENTARY SCHOOL SDP CONTRACTS NO. B-070C GC, B-071C MC, B-072C PC & B-073C EC OF 2019/20

MODULAR SPACE, INC. Specification document dated February 19, 2021

#### PART 3 EXECUTION

#### 3.01 PREPARATION

A. Fill and grade sites for temporary structures to provide drainage away from buildings.

#### 3.02 INSTALLATION

A. Install classroom spaces ready for occupancy for dates as shown on the phasing drawings.

#### 3.03 MAINTENANCE AND CLEANING

A. Maintain approach walks free of mud, water, and snow.

#### 3.04 REMOVAL

A. At completion of use by the school district as shown on the phasing drawings remove buildings, foundations, utility services, and debris. Restore areas to original condition including the removal of all footings and restoration of turf, grasses and pavement restoration.

#### **END OF SECTION**

Murphy Barton 856-686-9600 856-686-9240 (fax) murph@mobileasemodular.com



201 Rt. 130 Pedricktown NJ 08067 856-686-9600

murph@mobileasemodular.com

February 19, 2021

#### **SPECIFICATIONS**

Modular Building Institute Seal

100 MPH Wind Speed

Occupancy: Educational

Destination: Philadelphia, PA

#### FRAME:

- Perimeter Type with center C-Channel
- 64' or longer perimeter frame
- I-Beam Size as Required

#### FLOOR:

- Nylon Impregnated Bottom Board
- 2 x 8 Joists, 16" OC
- 3/4" T & G Plywood Decking
- 1/8" Vinyl Composite Block Tile

#### **WALLS & PARTITIONS:**

- Wall Height: 8'-6"
- 2 x 4 Wood Studs, 16" OC
- Double Top Plate
- 2 x 6 Wood Studs Endwalls extended to roof decking
- 2 x 6 Wood Studs Exterior Walls
- LF Interior Partition Walls (per print)
- Double Mateline Walls
- 5/8" Type X Vinyl Covered Gypsum Wallboard
- Standard Interior Trim Package
- 4" Vinyl Base Cove

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murph@mobileasemodular.com

February 19, 2021

#### **INTERIOR DOORS:**

- Restroom doors Passage/ Lever Hardware with Hydraulic Closer With classroom function deadbolt
- 36" x 80" Sol. Core Imp. Oak St. Fr. 20 Min. GRADE 2 HARDWARE
- 36" x 80" Sol. Core Imp. Oak St. Fr. 60 Min. GRADE 2 HARDWARE (janitor)
- 5" x 20" VIEW BLOCKS FOR CLASSROOM DOORS ONLY
- All door hardware to accept best IC cores

#### ROOF:

- Ground Snow Load: 30 psf
- Truss Spacing: 24" O.C.
- Transverse no bottom cord 24" o.c.
- FR-Deck
- 45 Mil White EPDM with FR
- Ceiling: 2 x 2 Acoustical T-Grid (MC required)
- Mateline Ridgebeam
- Ridgebeam: 4 Layer 24", 3/4" Plywood
- 1 Hour Rated Ceiling in Corridor (no dropdown)
   1 HOUR RATED CEILING TO BE SAME HEIGHT AS REST OF BUILDING.
- Attic Ventilation as Required

#### **PLUMBING:**

- Multi-station Restroom
- Handicap accessible ½ bath
- Wall mount lavatory with mirror & single lever faucet
- HC water closet with grab bars
- Standard elongated water closet
- SDP standard restroom accessories
- 30 Gal Water Heater
  - \*\*\* set water heater at 110 degrees\*\*\*
- Urina
- Steel modesty partitions
- Steel urinal screen
- Utility sink with legs (PVC)
- Hi/Lo Handicap accessible water cooler
- Type L Copper Supply Lines (per fixture)
   \*\*\*INSTALL PLUMBING IN CEILING, DO NOT USE ZIP TIE'S FOR STAPPING, USE PLUMBER STRAP\*\*\*
- CAST IRON DRAINS

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murph@mobileasemodular.com

February 19, 2021

#### **ELECTRICAL:**

- 125 Amp Panel (1) Per Classroom, (1) For Common Space
   \*\*KEYED LOCKS ON PANELS\*\*
- 2 x 2 LED T-GRID FLAT PANEL
   24-FPL1-LED-4000L-DIM 10-MVOLT-50K
- Emergency Lights (dual heads) (as required)
   \*\*\*LED IN ALL RESTROOMS, CLASSROOM & CORRIDOR\*\*\*
- Combo Lighted Exit Sign/Emergency Light with Battery
   \*\*LED\*\*
- Exterior Remote Heads (Dual Head Type)
   \*\*LED\*\*
- Empty 2 x 4 J-Box with 3/4" Conduit Stub
- Alarm Junction Boxes 2 x 4 with ½" conduit
- Commercial Grade 20 Amp 110v Recepts approx. 12' oc
- GFI Protected Receptacle 20 Amp
- Exterior GFI Receptacle (in-use type) 20 Amp
- Dedicated 110v 20 Amp rec for water cooler
- Heat Tape Receptacle (GFI) 20 Amp
- Occupancy Sensors Intermatic IOS-DOV
- MC Cable Wiring
- Ceiling mount occ sensor with power pack in gang restrooms / classrooms
- L-200 CFM EXHAUST IN STAFF RESTROOMS
- NUVO 65-062 13W LED Wall Pack Fixture with Photocell
- Exhaust fans in Boys and Girls restroom to be on fan controller
   \*\*Model 57V winnelec\*\*
- Boys and Girls RESTROOMS & CLASSROOM should be on occupancy sensors tied into HOT leg. NO SWITCH
- L-300 cfm broad fan with Model 57V Speed control switch winnelec

#### See Attached

#### **HVAC:**

- 3 Ton Wall Mount Unit with 10kw Heat, heat pump, dehumidification, energy recovery ventilators, humidistat
- CRV Unit on Wall Mount HVAC
- Programmable Thermostats
- LF Fiberglass Supply Duct with Grilles
- Std. Return Air Grilles at Unit Only (No Duct) ALL CLASSROOMS
- LF Fiberglass Return Duct with Grills for toilet unit
- LF Plenum Wall
- 10" x 10" Fire Dampers (as required)
- 2 x 2 Supply Grilles for Suspended T-Grid Ceiling
- 2 x 2 Return Grilles for Suspended T-Grid Ceiling
- NO RETURN IN CORRIDOR

201 Rt. 130 Pedricktown NJ 08067 856-686-9600 murph@mobileasemodular.com

February 19, 2021

#### **EXTERIOR:**

- Hi-Rib 29ga Steel Siding with Steel Trim
- 100% House Wrap
- Hi-Rib 29ga Steel Mansard (20" to 24" avg. height)
- 100% 7/16" OSB Sheathing
- Skirting: Hi-rib 29ga St. with 2 x 2 T, Vents (36" avg.)

#### **WINDOWS:**

- 36" X 60" vs Lowe E Insulated. This is an egress window.
- Bronze Aluminum Frames
- Bronze Tinted Glass
- Vinyl Mini-Blinds
- Security Screens Over Windows

#### **EXTERIOR DOORS:**

- 72" x 80" ST/ST (Panic Ready) with 10"ADA Vision panel & Center Post Both sides are active. Center Post is secured with 4 screws and is removable.
- 6" x 32" view block mounted 43" to bottom of view block
- Removable Post, Both Sides Active (ST/ST only)
   Post is secured with 4 screws
- STANDARD CLOSER
- Panic Hardware with Lever handle GRADE 1 PANIC

#### **INSULATION:**

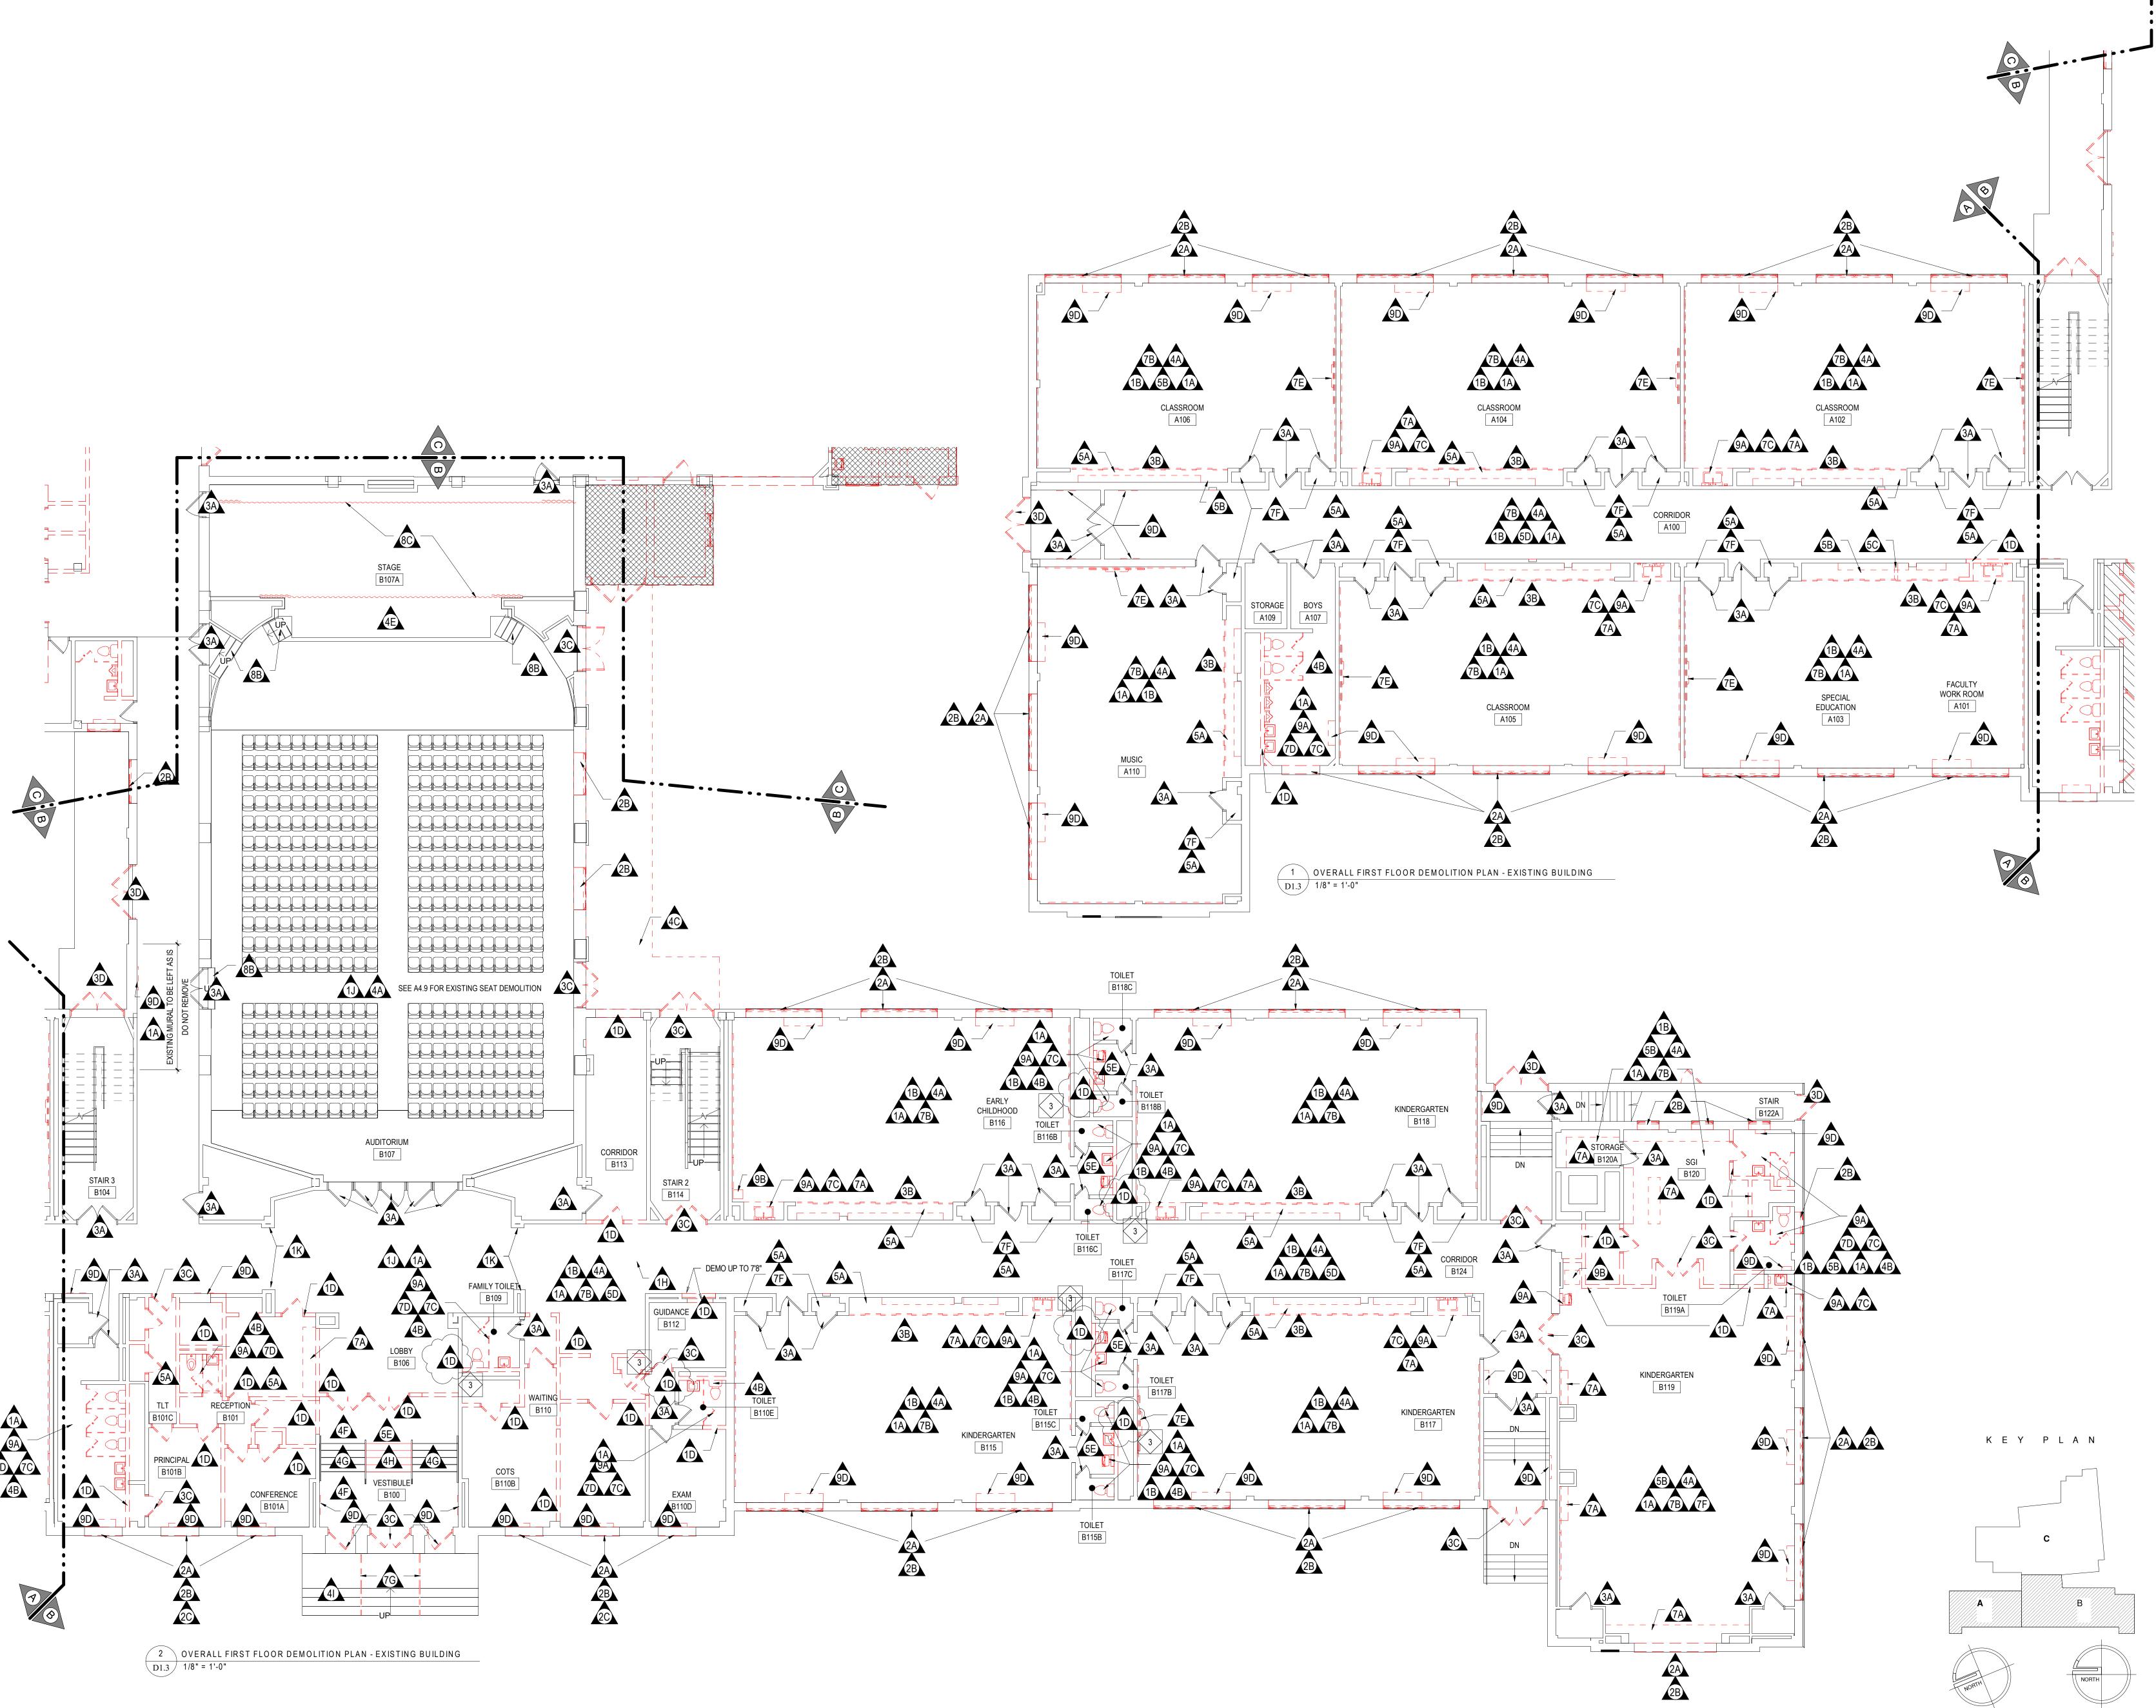
- Floor R-30, 10"
- Exterior Wall R-19
- Roof-R-60
- Interior Partitions R-11, 3.5"

#### **ELECTRICAL SCOPE (CONTINUED):**

- Provide MC Cable feeders and connections from MDP (Provided by EC) to Classroom and Common Area panelboards.
- Provide complete Fire Alarm system in accordance with NFPA and ADA requirements and School District of Philadelphia standards; including cabling and connections to Rhawnhurst ES building Fire Alarm system and programming.
- Provide Telecommunications system including wall mount data rack in Common Area with all required patch panels and cable management, and fiber optic and copper telecommunications cabling connections from modular telecommunications rack to Rhawnhurst ES telecommunications systems.
- Provide Cat-6 data wall outlets (9 per classroom), and lockable wall mount WAP enclosure (1 per classroom) per District standards and associated Cat-6 UTP cabling and all required terminations.
- Provide surveillance cameras per District standards; including Cat-6 UTP cabling, terminations and all cabling/connections required for connection to Rhawnhurst ES surveillance camera system.
- Provide (1) PA system speaker and (1) clock per classroom per District standards and associated wiring and connections to Rhawnhurst ES PA/Clock systems.
- Provide all additional components and accessories required to tie Modular Classroom systems identified above into Rhawnhurst ES building systems.
- Provide all backboxes, raceway, j-hooks, and wiring required for the above. (EC provides empty conduit pathway from Modular Classroom to Rhawnhurst ES basement crawlspace for low voltage systems cabling).
- Provide all system programming and testing required to confirm proper system operation.

#### **GENERAL NOTE:**

Electrical and Plumbing contractor will bring electrical, IT, water and sanitary to one location for the MCB, it is the general contractor's responsibility form this point to make connections as needed throughout the MCB for electrical, water and sanitary. This is due to to the MCB being provided by the general contractor which may facilitate small variations of layouts and connections that are not available to the other prime contractors during bidding.



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Attn: Ken Kistler

Email: kkistler-mka@comcast.net

# 03/02/2021

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3	03/26/2021	ADDB\DUM#3
2	03/19/2021	ADDBNDUM#2
1	03/15/2021	ADDB\DUM#1
NO.	DATE	REVISION

SCHOOL & LOCATION
RHAWNHURST ELEMENTARY
SCHOOL

7809 Castor Ave, Philadelphia, PA 19152

PROJECT TITLE

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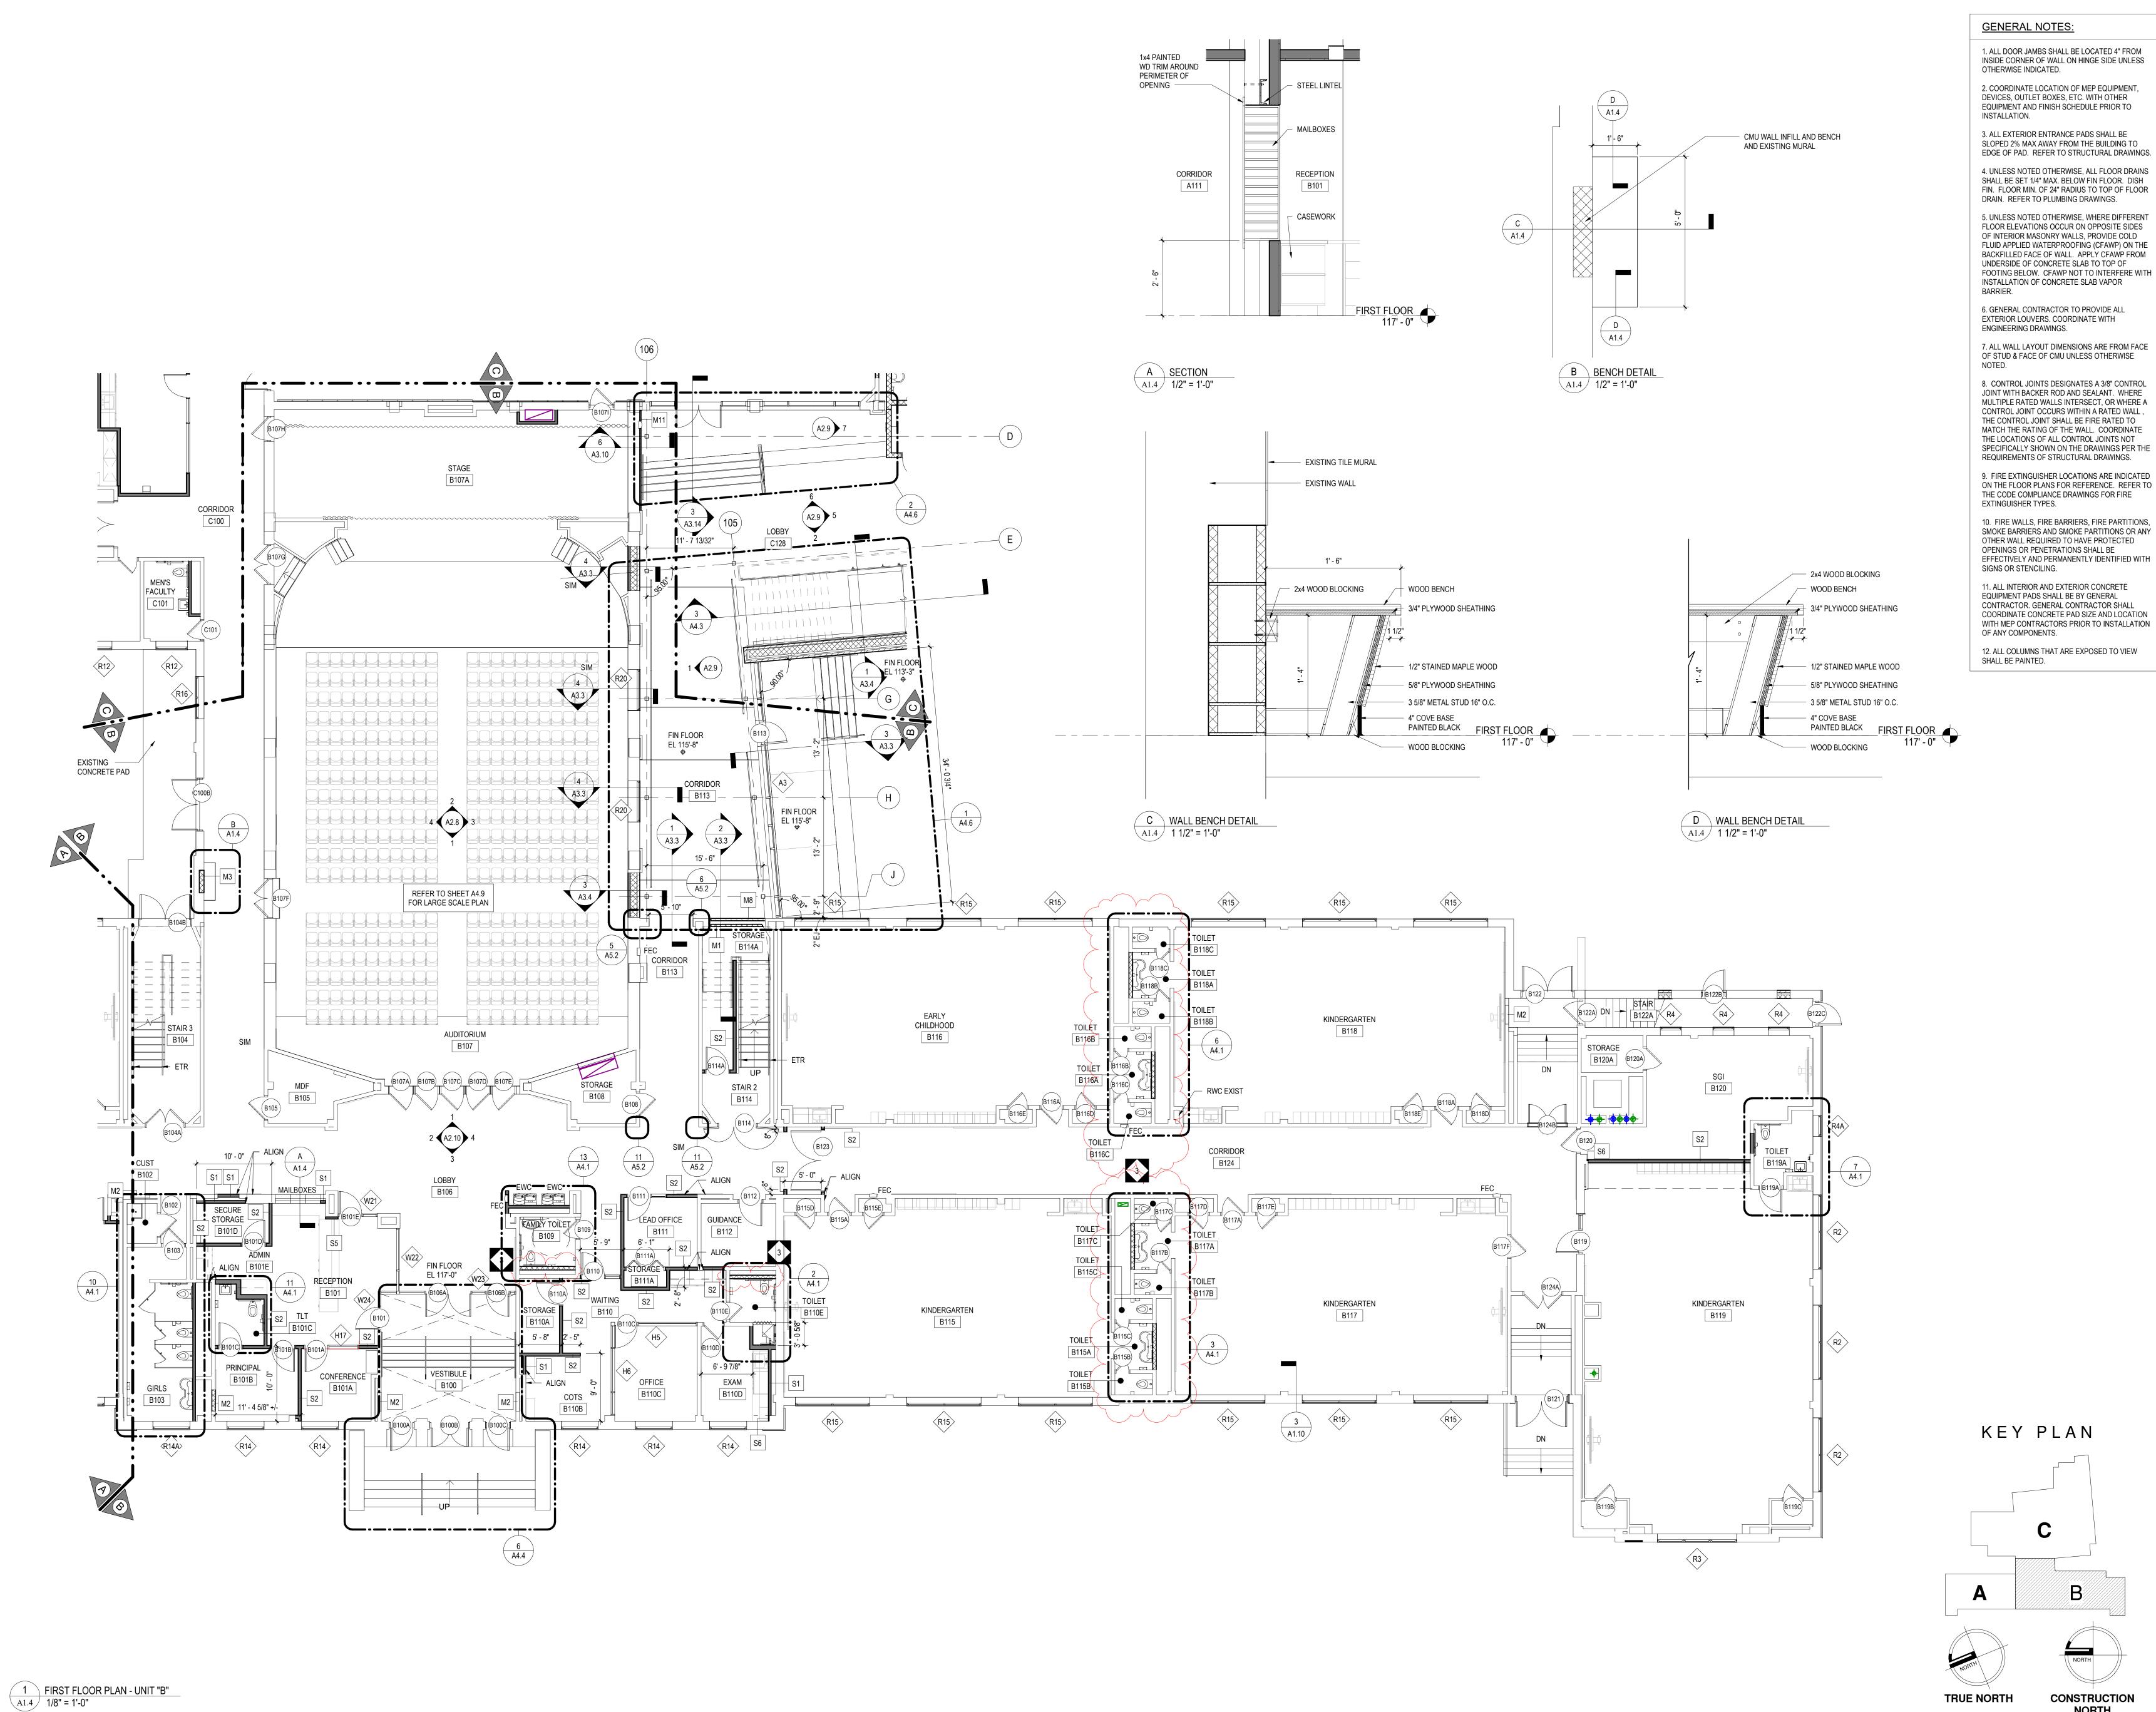
DRAWING TITLE

CONSTRUCTION

FIRST FLOOR DEMOLITION
PLAN UNITS "A" & "B"

B-070 OF 2019 / 20
B-071 OF 2019 / 20
B-072 OF 2019 / 20
B-073 OF 2019 / 20

DRAWING NO.
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3	03/26/2021	ADDENDUM #3			
2	03/19/2021	ADDENDUM #2			
1	03/15/2021	ADDENDUM #1			

SCHOOL & LOCATION RHAWNHURST ELEMENTARY SCHOOL

7809 Castor Ave, Philadelphia, PA 19152

PROJECT TITLE

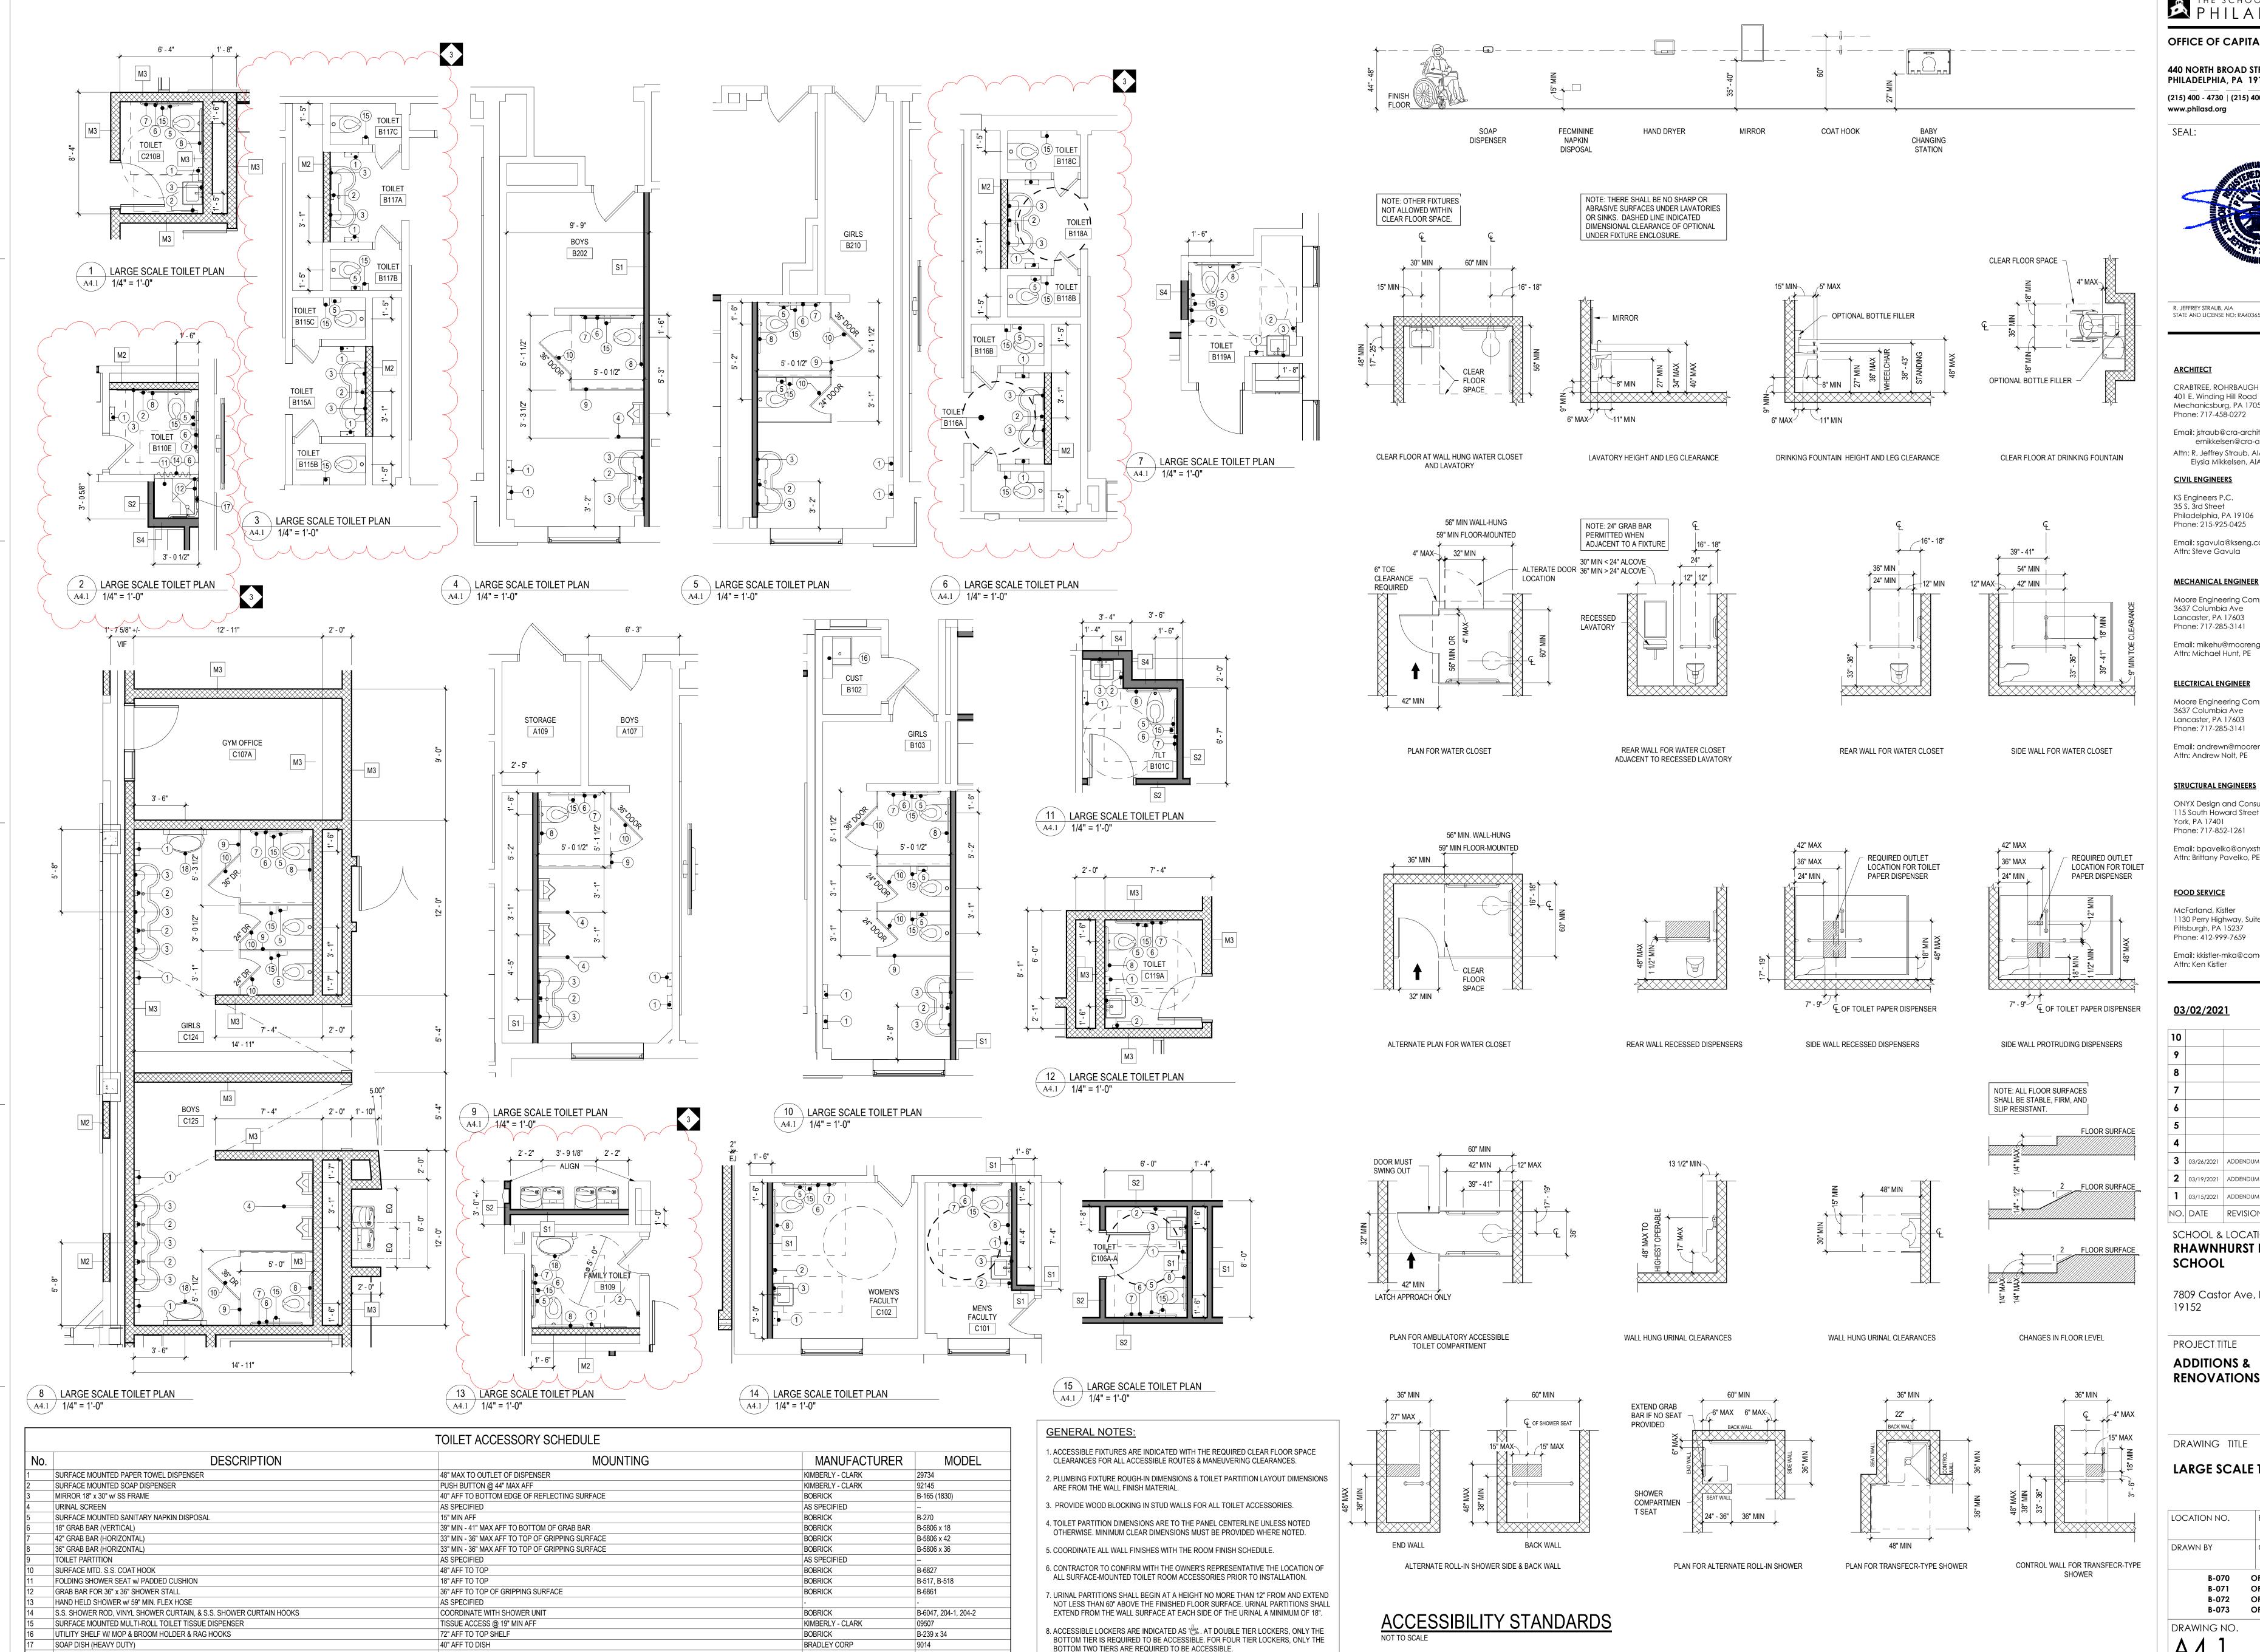
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**ADDITIONS & RENOVATIONS** 

DRAWING TITLE

FIRST FLOOR PLAN UNIT "B"

LOCATION NO. FILE NO. DRAWN BY CHECKED BY OF 2019 / 20 B-073 DRAWING NO.



34" AFF TO CHANGING SURFACE (DOWN POSITION)

BABY CHANGING STATION

THE SCHOOL DISTRICT OF PHILADELPHIA

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# 03/02/2021

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3	03/26/2021	ADDENDUM #3
2	03/19/2021	ADDENDUM #2
1	03/15/2021	ADDENDUM #1
NO	DATE	REVISION

### NO. DATE REVISION SCHOOL & LOCATION RHAWNHURST ELEMENTARY SCHOOL

7809 Castor Ave, Philadelphia, PA

PROJECT TITLE

## **ADDITIONS & RENOVATIONS**

DRAWING TITLE

# LARGE SCALE TOILET PLANS

LOCATION NO.		ENO.
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B-070	OF	2019 / 20
B-071	OF	2019 / 20
B-072	OF	2019 / 20
B-073	OF	2019 / 20



BASE AS SCHEDULED

4 DECORATIVE PROTECTION PANEL ELEVATION

I7.9 1/2" = 1'-0"

THE SCHOOL DISTRICT OF PHILADELPHIA

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03/02/2021 **2** 03/19/12 ADDENDUM #2

NO. DATE REVISION SCHOOL & LOCATION RHAWNHURST ELEMENTARY SCHOOL

**1** 03/15/12 ADDENDUM #1

7809 Castor Ave, Philadelphia, PA 19152

PROJECT TITLE **ADDITIONS &** 

**RENOVATIONS** 

DRAWING TITLE

**OVERALL FIRST FLOOR -FINISH PLAN** 

LOCATION NO. FILE NO. DRAWN BY CHECKED BY Checker B-070 OF 2019 / 20

OF 2019 / 20 B-071 B-072 OF 2019 / 20 B-073 OF 2019 / 20

DRAWING NO.

— — = PAINTED ACCENT COLOR, COLOR TBD

= WALL GRAPHIC - REFER TO ARCHITECTURAL DWG

GENERAL NOTE IN REFERENCE TO ALL FINISH PLAN DRAWINGS

ROOM FINISH SCHEDULE, INTERIOR AND ARCHITECTURAL ELEVATIONS/PLANS

1. DRAWINGS ARE FOR CLARIFICATION OF MATERIAL LOCATIONS. REFER TO

AND SPECIFIFCATIONS FOR ADDITIONAL INFORMATION.



1 OVERALL SECOND FLOOR FINISH PLAN
17.10 1/16" = 1'-0"

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# 03/02/2021

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2	03/19/12	ADDENDUM#2
1	03/15/12	ADDB\DUM#1

# NO. DATE REVISION SCHOOL & LOCATION RHAWNHURST ELEMENTARY

7809 Castor Ave, Philadelphia, PA

19152

PROJECT TITLE

A D D ITIO N S &

RENOVATIONS &

DRAWING TITLE

O V E R A L L S E C O N D F L O O R FIN ISH P L A N

B-070 B-071 B-072	C	)F )F )F	2019 / 20 2019 / 20 2019 / 20	
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B-073	OF	2019 / 20
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GENERAL NOTE IN REFERENCE TO ALL FINISH PLAN DRAWINGS

\_\_\_\_\_ = WALL GRAPHIC - REFER TO ARCHITECTURAL DWG

FINISH PLAN LEGEND

\_\_\_\_ = STAIN EXISTING WOOD

= EXISTING RED BRICK

\_\_\_\_ = NEW RED BRICK

\_\_\_\_ = NEW BLUE BRICK

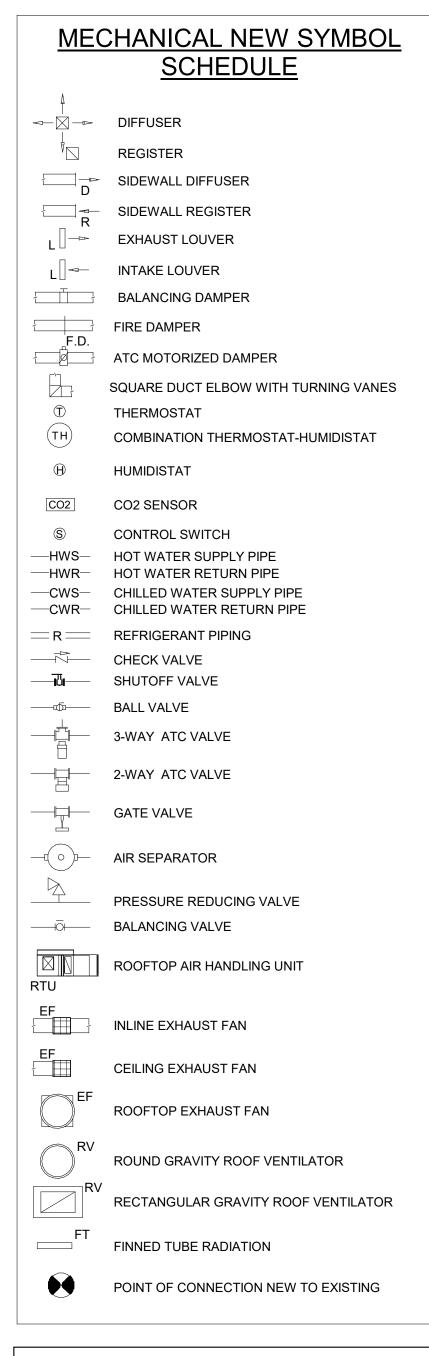
\_\_\_\_ = TILE

\_\_\_\_ = NEW YELLOW BRICK

\_\_\_\_ = EXISTING MOSIAC TILE

\_\_\_\_ = DECORATIVE PROTECTION PANEL

\_\_\_ = PAINTED ACCENT COLOR, COLOR TBD



# KITCHEN DUCTWORK NOTES:

- ALL KITCHEN HOOD MAKE-UP AIR DUCTWORK SHALL BE WRAPPED WITH FIBERGLASS INSULATION IN LIEU OF DUCT LINER.
- DISHWASHER EXHAUST SHALL BE ALL ALUMINUM CONSTRUCTION WITH SEALED JOINTS. DUCTWORK SHALL BE SLOPED BACK TOWARD THE DISHWASHER HOOD CONNECTION.
- MAINTAIN MINIMUM 6" CLEARANCE AROUND ALL SIDES OF KITCHEN HOOD EXHAUST DUCTWORK.
- MAINTAIN MINIMUM 10'-0" CLEARANCE BETWEEN INTAKE OF MAKE-UP AIR FANS ON ROOF AND DISCHARGE FROM ANY EXHAUST FAN OR VENT ON
- FIELD VERIFY EXHAUST HOOD CONNECTION SIZES AND LOCATIONS BEFORE FABRICATION OF DUCTWORK.

# **DEMOLITION NOTES:**

- RESPECTIVE CONTRACTOR IS RESPONSIBLE FOR PERFORMING ANY DEMOLITION WORK (EVEN IF NOT SHOWN ON THE PLANS) NECESSARY FOR COMPLETION OF PROJECT. THIS INCLUDES REMOVAL OF ANY EQUIPMENT AND MATERIALS THAT WILL NO LONGER BE UTILIZED AFTER COMPLETION OF THIS PROJECT.
- EQUIPMENT THAT IS REMOVED SHALL BE TURNED OVER TO OWNER. IF OWNER DOES NOT WANT EQUIPMENT, IT SHALL BE DISPOSED OF PROPERLY BY RESPECTIVE CONTRACTOR.

### **MECHANICAL NOTES:**

- (THESE NOTES APPLY TO ALL MECHANICAL DRAWINGS)

  1. FOR THE HOT WATER AND CHILLED WATER SYSTEMS, THE MECHANICAL CONTRACTOR SHALL PROVIDE MANUAL AIR WENTS AT ALL HIGH POINTS IN THE SYSTEM AND AT EACH UNIT AND SHALL PROVIDE DRAINS AT ALL LOW POINTS.
- 2. ALL REFRIGERATION PIPING SHALL BE INSTALLED IN STRICT ACCORDANCE WITH THE MANUFACTURER'S SPECIFICATIONS AND RECOMMENDATIONS.
- 3. ALL REFRIGERANT PIPING SHALL BE PITCHED A MINIMUM OF 1/4" IN 10'-0" IN THE DIRECTION OF THE REFRIGERANT FLOW.
- 4. ALL UNDERGROUND OR CONCEALED REFRIGERATION LINES SHALL BE INSULATED WITH 1" FOAMGLAS INSULATION BY PITTSBURG-CORNING WITH PITTWRAP PROTECTIVE COVERING. INSTALL IN ACCORDANCE WITH MANUFACTURER'S SPECIFICATIONS AND RECOMMENDATIONS.
- 5. ALL PIPE PENETRATIONS THROUGH CHASES, WALLS OR FLOORS WHICH ARE FIRE-RATED SHALL BE PROPERLY SEALED TO MAINTAIN FIRE PROTECTION RATING.
- 6. ALL DUCTS THAT PENETRATE CHASES, WALLS OR FLOORS WHICH ARE FIRE-RATED SHALL BE INSTALLED WITH FIRE DAMPERS IN ACCORDANCE WITH NFPA 90A. THIS APPLIES EVEN IF THEY ARE NOT SPECIFICALLY SHOWN ON THE DRAWINGS.
- . PROVIDE AND INSTALL RADIATION DAMPERS ON ALL DIFFUSERS, REGISTERS AND GRILLES THAT PENETRATE CEILINGS WHICH ARE FIRE-RATED OR PART OF A FIRE-RATED ASSEMBLY.
- 8. ALL MATERIALS USED IN PLENUM CEILING AREAS SHALL BE PLENUM RATED AND MEET FLAME/SMOKE INDEXES OF 25/50.

### **GENERAL NOTES:**

- (THESE NOTES APPLY TO ALL MECHANICAL DRAWINGS)
- 1. ANY PHYSICAL INSTALLATION MODIFICATIONS DUE TO FIELD CONDITIONS SHALL BE RESOLVED BY THE MECHANICAL CONTRACTOR IN ACCORDANCE WITH THE RECOMMENDATIONS OF THE MECHANICAL
- 2. THE ENTIRE INSTALLATION SHALL COMPLY WITH ALL CODES, LOCAL, STATE, AND NATIONAL
- 3. THIS CONTRACTOR SHALL PROVIDE ALL MISCELLANEOUS STEEL AND
- SUPPORTS TO SUSPEND DUCTWORK AND EQUIPMENT.
- 4. ALL EQUIPMENT SHALL BE INSTALLED WITH VIBRATION ISOLATORS.
- 5. THIS CONTRACTOR SHALL PROVIDE ALL LABOR, MATERIALS, AND EQUIPMENT TO ENSURE A COMPLETE SYSTEM.
- 6. THIS CONTRACTOR SHALL COORDINATE HIS WORK WITH ALL OTHER
- 7. THE MECHANICAL CONTRACTOR SHALL SEAL ALL HIS RESPECTIVE WALL AND ROOF PENETRATIONS.
- 8. ALL ROOF OPENINGS SHALL BE BY MECHANICAL CONTRACTOR.
- FLASHING SHALL BE PROVIDED BY THE GENERAL CONTRACTOR. COUNTER-FLASHING WILL BE BY THE MECHANICAL CONTRACTOR.
- 9. THE MECHANICAL CONTRACTOR SHALL PAY FOR ALL FEES AND PERMITS AS NECESSARY TO COMPLETE THE INSTALLATION.
- 10. CONTRACTOR SHALL INSTALL ALL EQUIPMENT WITH ADEQUATE SERVICE CLEARANCES AS RECOMMENDED BY THE EQUIPMENT MANUFACTURER.
- 11. MECHANICAL CONTRACTOR SHALL BE RESPONSIBLE FOR CUTTING AND PATCHING WALLS AND FLOORS FOR NEW EQUIPMENT AND MATERIALS. PATCH TO MATCH EXISTING.

# **DUCTWORK NOTES:**

- (THESE NOTES APPLY TO ALL MECHANICAL DRAWINGS)
- 1. ALL DUCTWORK SIZES NOTED ARE FREE AREA SIZES.
- 2. TURNING VANES SHALL BE PROVIDED IN ALL DUCT ELBOWS.
- 3. PROVIDE ALL DAMPERS, SPLITTERS, AND EXTRACTORS AS REQUIRED FOR PROPER AIR DISTRIBUTION IN GENERAL ACCORDANCE WITH THE STANDARDS OF THE NATIONAL ENVIRONMENTAL BALANCING BUREAU.

4. FURNISH AND INSTALL AS NECESSITATED BY EXISTING CONDITIONS ALL

- SUPPORT MATERIALS TO INSURE A RIGID INSTALLATION. 5. ALL SUPPLY AND RETURN DUCTWORK EXCEPT DOUBLE WALL SPIRAL
- ROUND DUCTWORK SHALL BE INTERNALLY LINED IN ACCORDANCE WITH THE SPECIFICATIONS.
- 6. THE MECHANICAL CONTRACTOR SHALL BE RESPONSIBLE FOR COORDINATING INSTALLATION OF NEW DIFFUSERS AND REGISTERS WITH SUSPENDED CEILING GRID AND LIGHTING FIXTURES TO BE INSTALLED BY THE GENERAL AND ELECTRICAL CONTRACTORS RESPECTIVELY. CEILING DIFFUSERS AND REGISTERS SHALL BE CENTERED IN GRID SYSTEM.
- 7. LENGTH OF FLEXIBLE DUCT BRANCHES SHALL NOT EXCEED 8' 0" MAXIMUM. ANY ADDITIONAL LENGTH AS NEEDED FOR INDIVIDUAL CONNECTIONS SHALL BE ACCOMPLISHED WITH ROUND RIGID DUCTWORK.
- 8. FLEXIBLE DUCT WILL NOT BE ACCEPTABLE FOR EXHAUST FAN INSTALLATIONS.
- 9. THE MECHANICAL CONTRACTOR SHALL FURNISH AND INSTALL FLEXIBLE FABRIC CONNECTIONS BETWEEN DUCTWORK AND FANS IN ORDER TO ISOLATE EQUIPMENT AND PREVENT VIBRATION.

# DUCTWORK SIZE NOTE:

(THIS NOTE SHALL APPLY TO ALL MECHANICAL DRAWINGS) DUCTWORK SIZES AND LOCATIONS ARE APPROXIMATE. MECHANICAL CONTRACTOR SHALL BE RESPONSIBLE FOR DUCTWORK SIZE REVISIONS AS REQUIRED TO ACCOMMODATE AVAILABLE SPACE. SIZING SHALL BE BASED ON A MAXIMUM .08" PER 100FT. OF STATIC PRESSURE AND A MAXIMUM 1100 FPM AIR VELOCITY. DUCTWORK SYSTEMS SHALL BE SIZED BASED ON AVAILABLE HVAC FAN CAPACITY.

#### MECHANICAL ABBREVIATIONS (THESE ABBREVIATIONS APPLY TO ALL DRAWINGS)

**DEVICES** ELECTRICAL DIFFUSER FLA FULL LOAD AMPS REGISTER MCA MAXIMUM CURRENT AMPS LOUVER MOP MAXIMUM OVERCURRENT PROTECTION FIRE DAMPER GA **GAUGE** FIRE/SMOKE DAMPER **GENERAL** SMOKE DAMPER **TYPICAL** BALANCING DAMPER AFF ABOVE FINISHED FLOOR MOD MOTOR OPERATED DAMPER TFB TO FLOOR BELOW ATC AUTOMATIC TEMPERATURE CONTROL TFA TO FLOOR ABOVE <u>HYDRONIC</u> FFA FROM FLOOR ABOVE GPM GALLONS PER MINUTE FFB FROM FLOOR BELOW ABOVE FINISHED FLOOR HWS **HEATING HOT WATER SUPPLY** SUPPLY AIR HEATING HOT WATER RETURN **HWR** RETURN AIR REFRIGERANT PIPING OUTSIDE AIR DESIGN CRITERIA EXHAUST AIR PRESSURE DROP T.O. TRANSFER OPENING RELATIVE HUMIDITY OED OPEN END DUCT REVOLUTIONS PER MINUTE CLG CEILING STATIC PRESSURE ETR EXISTING TO REMAIN ESP EXTERNAL STATIC PRESSURE **ELECTRICAL CONTRACTOR** TOTAL STATIC PRESSURE FPC FIRE PROTECTION CONTRACTOR GENERAL CONTRACTOR DRY BULB MC MECHANICAL CONTRACTOR **AMBIENT** PLUMBING CONTRACTOR WATER PRESSURE DROP B.O.D. BOTTOM OF DUCT AIR PRESSURE DROP C.O.D. CENTER OF DUCT ENTERING WATER TEMPERATURE LEAVING WATER TEMPERATURE LWT ENTERAING AIR TEMPERATURE LEAVING AIR TEMPERATURE

PRESSURE REDUCING VALVE

BOILER BLOWDOWN

EXHAUST FAN

**BOILER** 

CONVECTOR

UNIT HEATER

**EXPANSION TANK** 

AIR SEPARATOR

MAKE-UP AIR UNIT

CABINET HEATER

FINNED TUBE RADIATION

VARIABLE AIR VOLUME BOX

FAN POWERED VARIABLE AIR VOLUME BOX

BASEBOARD HEATER

AIR CONDITIONER

**CONDENSING UNIT** 

BBD

VAV

<u>EQUIPMENT</u>

### **HVAC DEMOLITION SYMBOL SCHEDULE** (ALL TO BE REMOVED EXCEPT WHERE NOTED) (APPLIES TO ALL DWGS.) **EXISTING UNIT VENT TO REMAIN** REMOVE EXISTING UNIT VENT REMOVE EXISTING AIR HANDLER □ □ AH L \_ \_ J EXISTING AIR HANDLER TO REMAIN **EXISTING ROOF VENT TO REMAIN** $\vdash$ $\bot$ $\bot$ REMOVE EXISTING ROOF VENT **EXISTING ROOF VENT TO REMAIN** REMOVE EXISTING EXHAUST FAN REMOVE EXISTING THRU-WALL AIR CONDITIONER \_\_\_\_CH REMOVE EXISTING CABINET HEATER \_\_\_\_\_ C REMOVE EXISTING CONVECTOR T CH EXISTING CABINET HEATER TO REMAIN **EXISTING CONVECTOR TO REMAIN** т\_\_\_\_С REMOVE EXISTING THERMOSTAT - ⊤ -| L REMOVE EXISTING LOUVER REMOVE EXISTING REGISTER **EXISTING LOUVER TO REMAIN EXISTING REGISTER TO REMAIN** [ ] CU REMOVE EXISTING CONDENSING UNIT REMOVE EXISTING DIFFUSERS **EXISTING DIFFUSER TO REMAIN** REMOVE EXISTING UNIT HEATER EXISTING UNIT HEATER TO REMAIN \_ \_ \_ \_ \_ REMOVE EXISTING DUCTWORK \_\_\_\_ **EXISTING DUCTWORK TO REMAIN** EXTENT OF DEMOLITION POINT 1. ENTIRE EXISTING HWS/HWR PIPING SYSTEM TO BE REMOVED. EXCEPT WHERE NOTED. 2. REMOVE ALL EXISTING UNIT VENT WALL LOUVERS. PATCH AS REQUIRED. 3. REMOVE ALL EXISTING DUCTWORK EXCEPT IN AUDITORIUM. 4. MECHANICAL CONTRACTOR SHALL REMOVE ALL HVAC EQUIPMENT SCHEDULED ABOVE UNLESS NOTED OTHERWISE ON PLANS. 5. MECHANICAL CONTRACTOR SHALL REMOVE ALL CONTROLS, PIPING, DUCTWORK, AND LOUVERS ASSOCIATED WITH HVAC EQUIPMENT TO BE REMOVED; EVEN IF NOT SHOWN ON THE PLANS. . MECHANICAL CONTRACTOR IS RESPONSIBLE FOR PATCHING ALL OPENINGS TO MATCH EXISTING WHERE EQUIPMENT IS REMOVED AND NOT REPLACED OR NEW EQUIPMENT SIZE DIFFERS FROM REMOVED EQUIPMENT. . DEMOLITION PLANS ARE SCHEMATIC AND NOT INTENDED TO SHOW EXACT LOCATIONS OF EQUIPMENT AND MATERIALS REMOVED. CONTRACTOR SHALL VERIFY LOCATIONS OF ALL EQUIPMENT, PIPING, DUCTWORK, CONTROLS, ETC. B. MECHANICAL CONTRACTOR SHALL REMOVE ALL SUPPORTS, PADS, ETC., ASSOCIATED WITH EQUIPMENT BEING REMOVED. . THESE DEMOLITION PLANS WERE PREPARED FROM ON-SITE SURVEYS AND ORIGINAL CONSTRUCTION DOCUMENTS. IN AN EFFORT TO PROVIDE THIS CONTRACTOR WITH THE GENERAL SCOPE OF THE PROJECT, THESE DEMOLITION PLANS WERE PREPARED TO SHOW AND/OR NOTE THE EXISTING CONDITIONS TO THE BEST OF THE ENGINEER'S KNOWLEDGE. IT IS STILL THE RESPONSIBILITY OF THE MECHANICAL CONTRACTOR TO VISIT THE SITE AND INCLUDE IN THE BID ALL OTHER DEMOLITION WORK REQUIRED FOR REMOVAL OF ALL MECHANICAL EQUIPMENT. REFER TO ARCHITECTURAL DRAWINGS FOR THE COMPLETE BUILDING DEMOLITION PLANS. REFER TO ARCHTECTURAL DRAWINGS AND SPECIFICATIONS FOR DEMOLITION PHASING.

10. ALL EXISTING HVAC PIPING SHOWN REMAINING TO BE REUSED SHALL HAVE EXISTING

INSULATION REMOVED AND REPLACED WITH NEW INSULATION. NEW INSULATION

THICKNESS SHALL BE IN ACCORDANCE WITH THE SPECIFICATIONS.

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1	3/25/2021	ADDENDUM #3

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NO. DATE REVISION

**ADDITIONS &** 

PROJECT TITLE

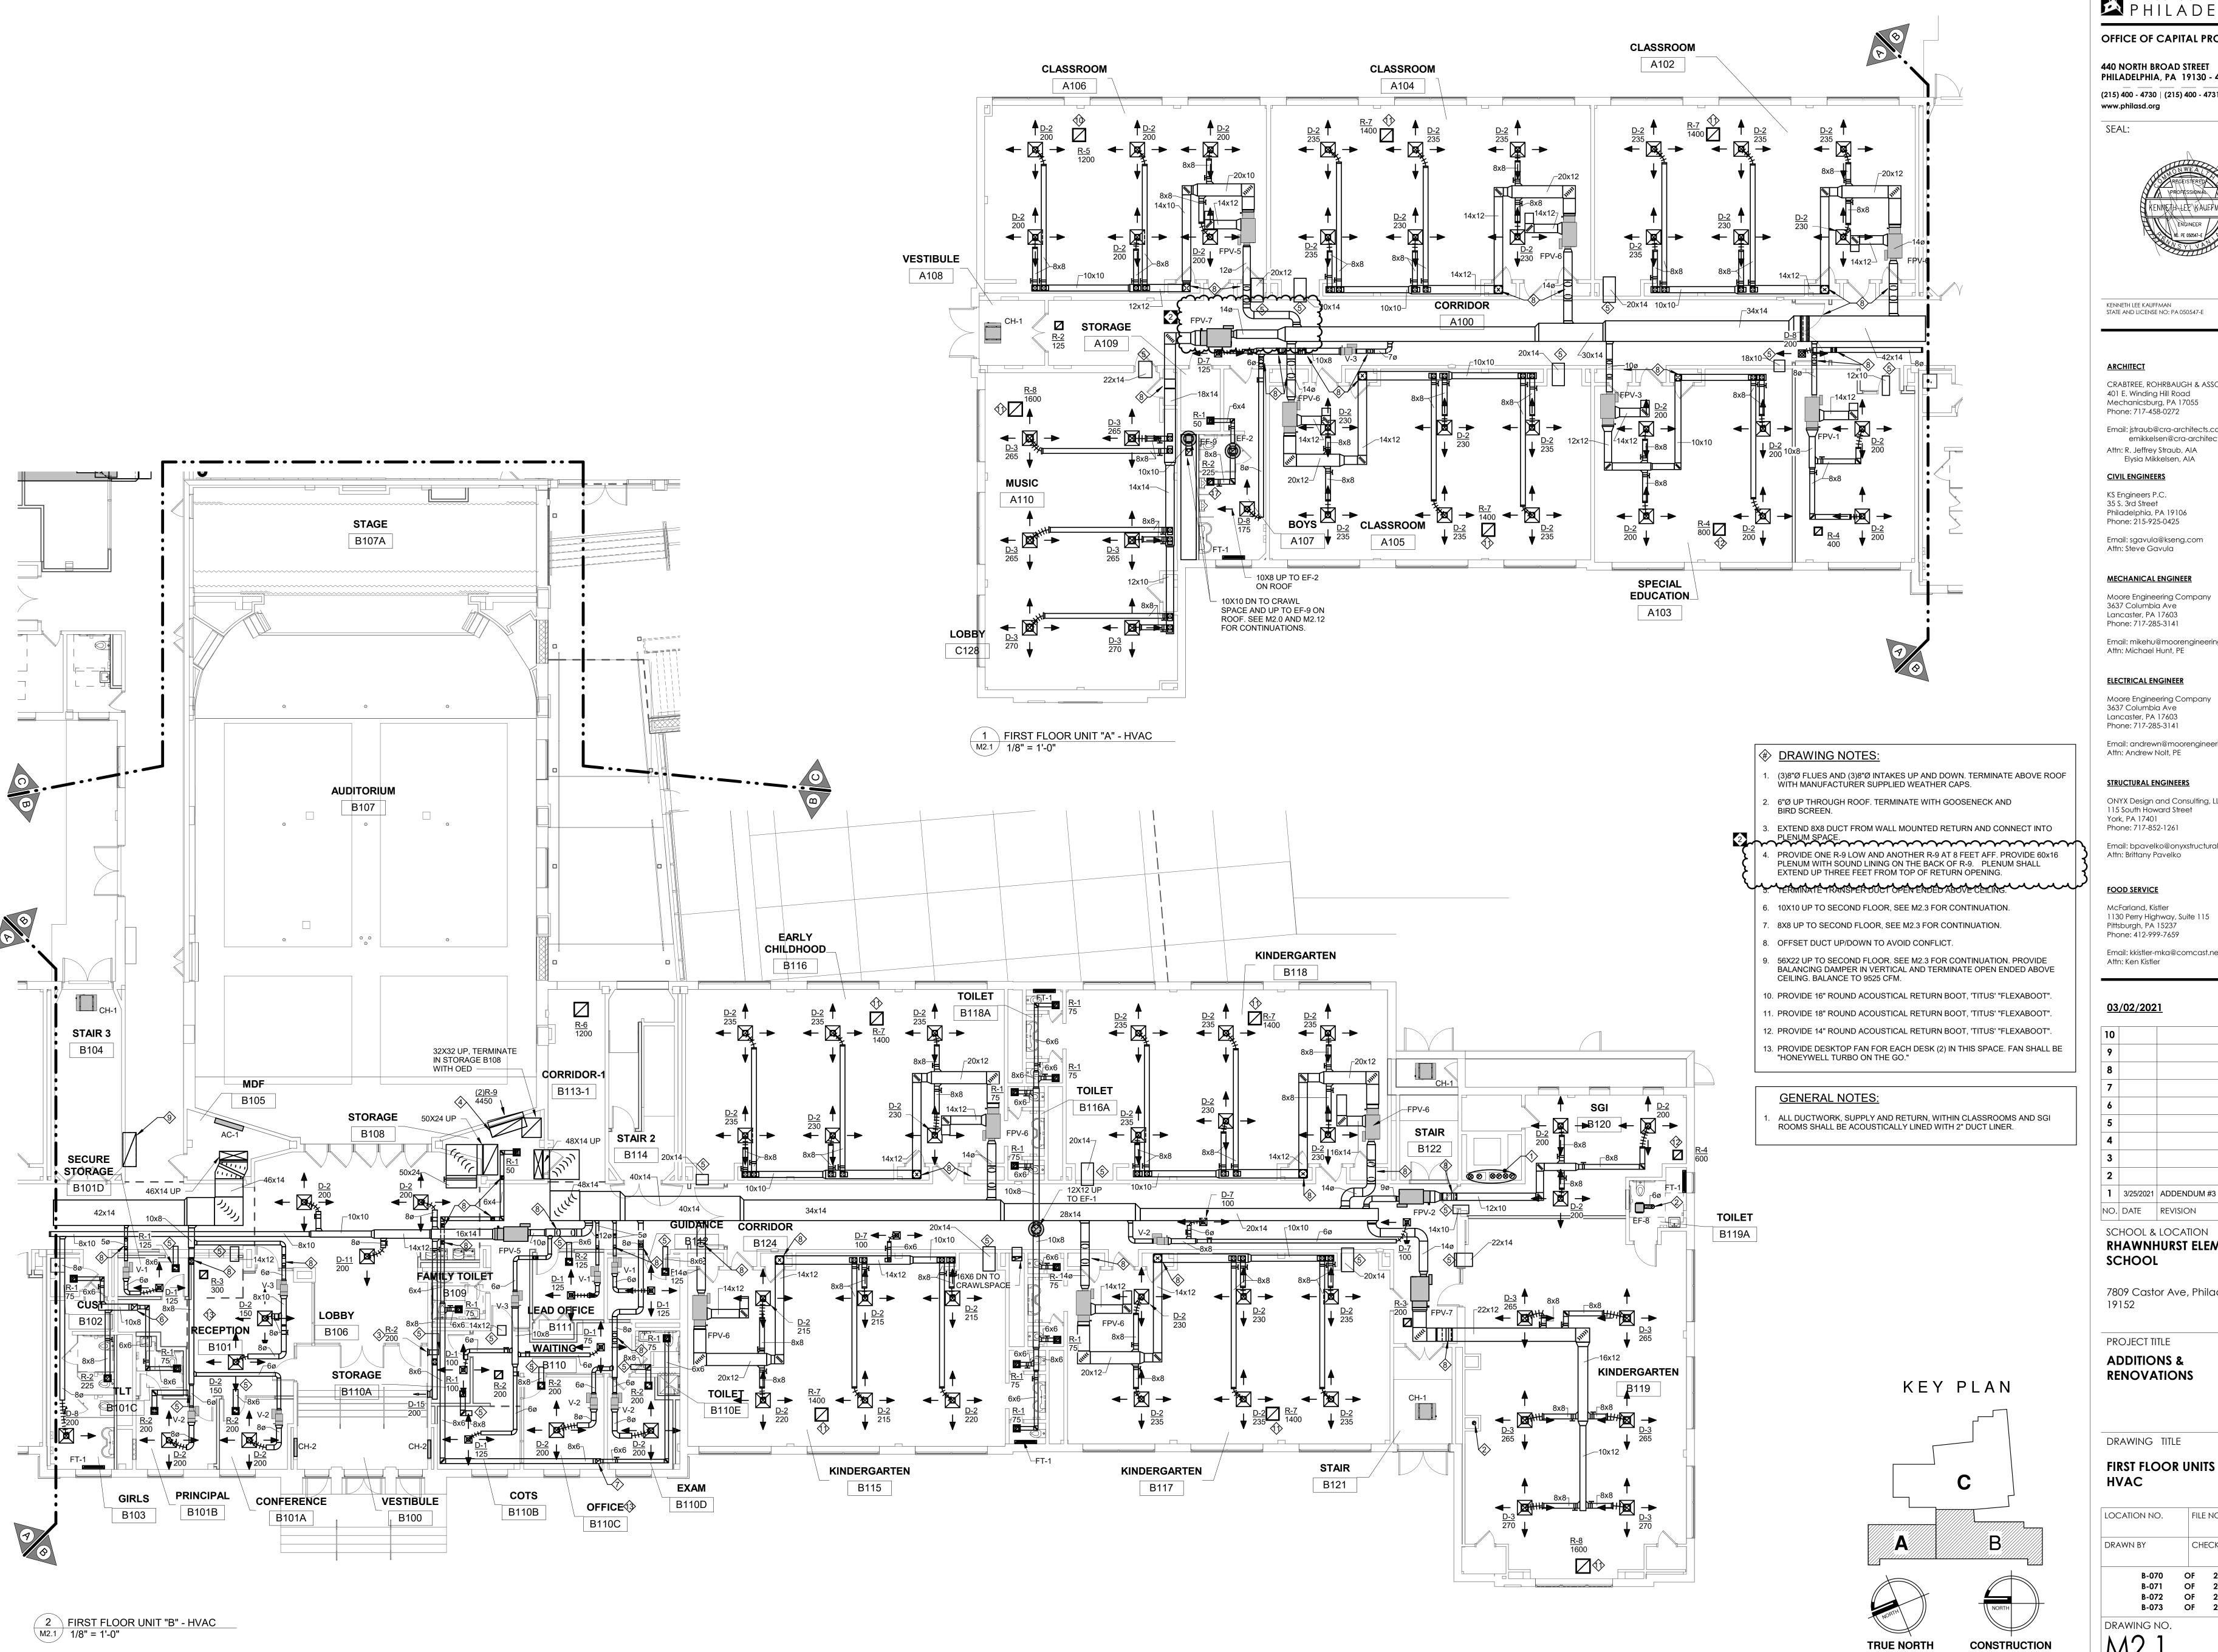
**RENOVATIONS** 

DRAWING TITLE

# LEGEND, ABBREVIATIONS **AND NOTES**

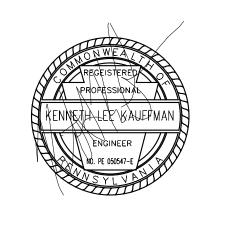
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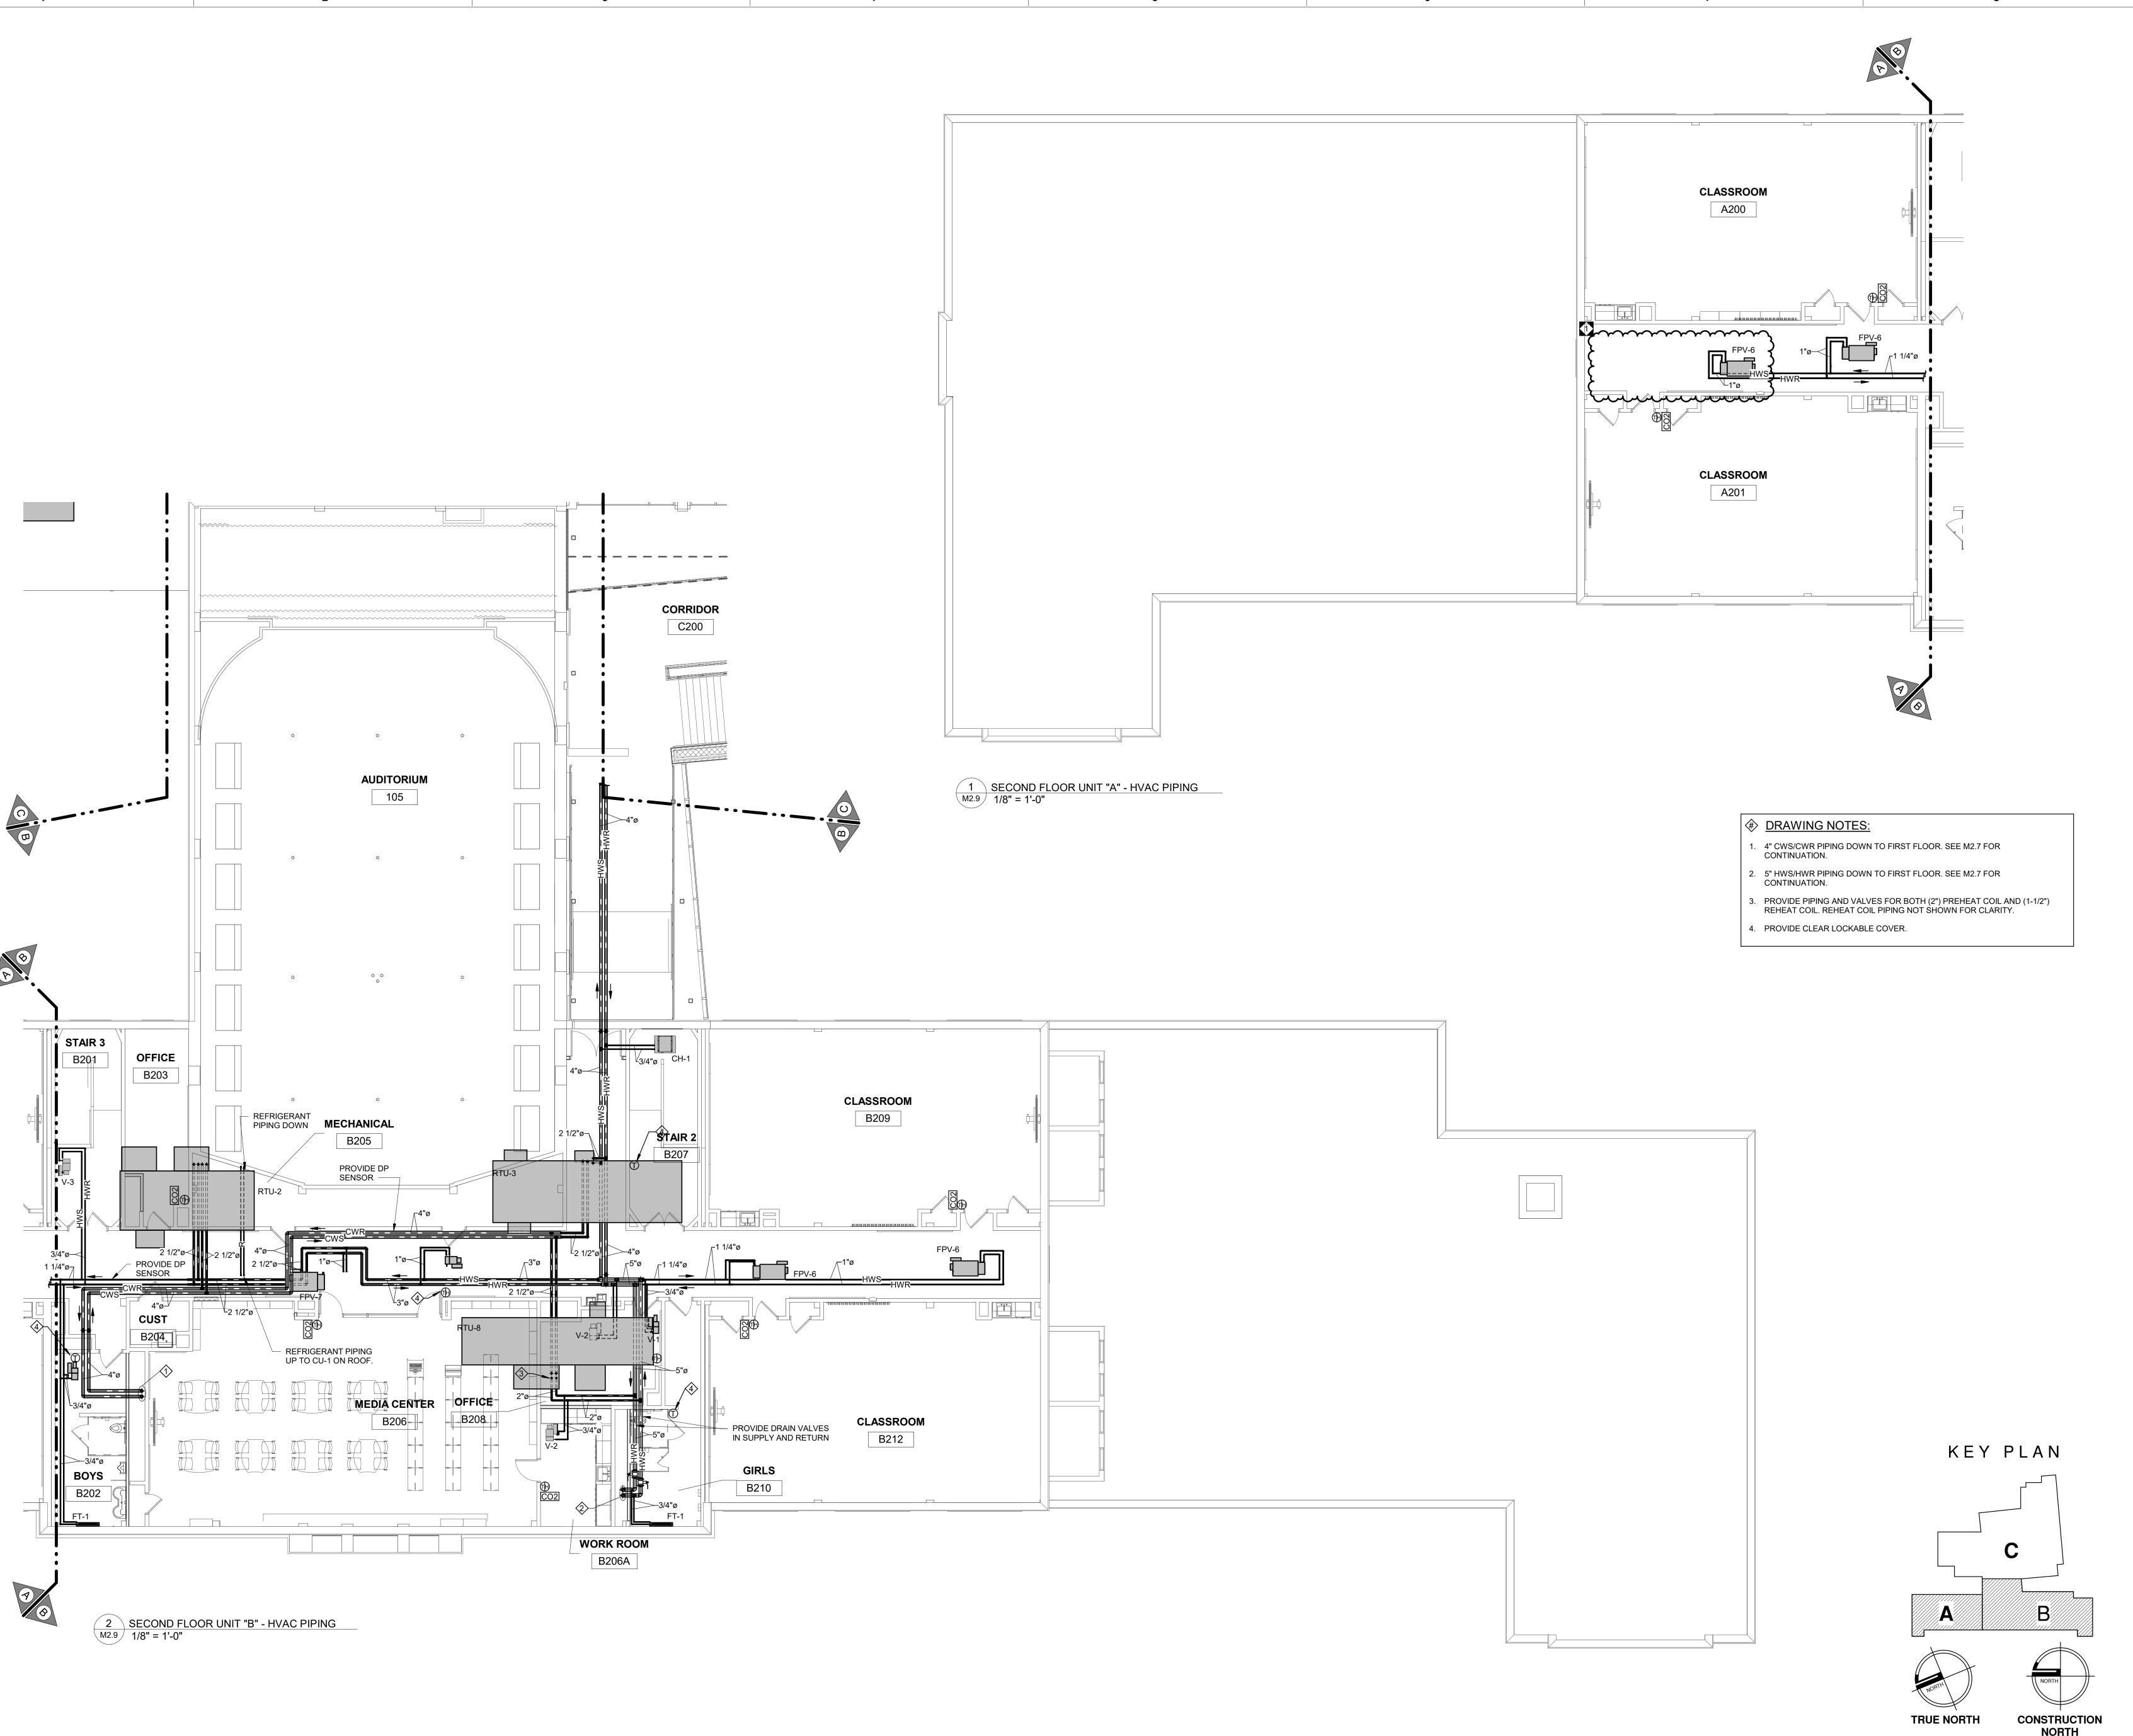
PROJECT TITLE **ADDITIONS &** 

**RENOVATIONS** 

DRAWING TITLE

FIRST FLOOR UNITS "A" & "B" HVAC

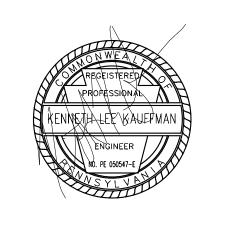
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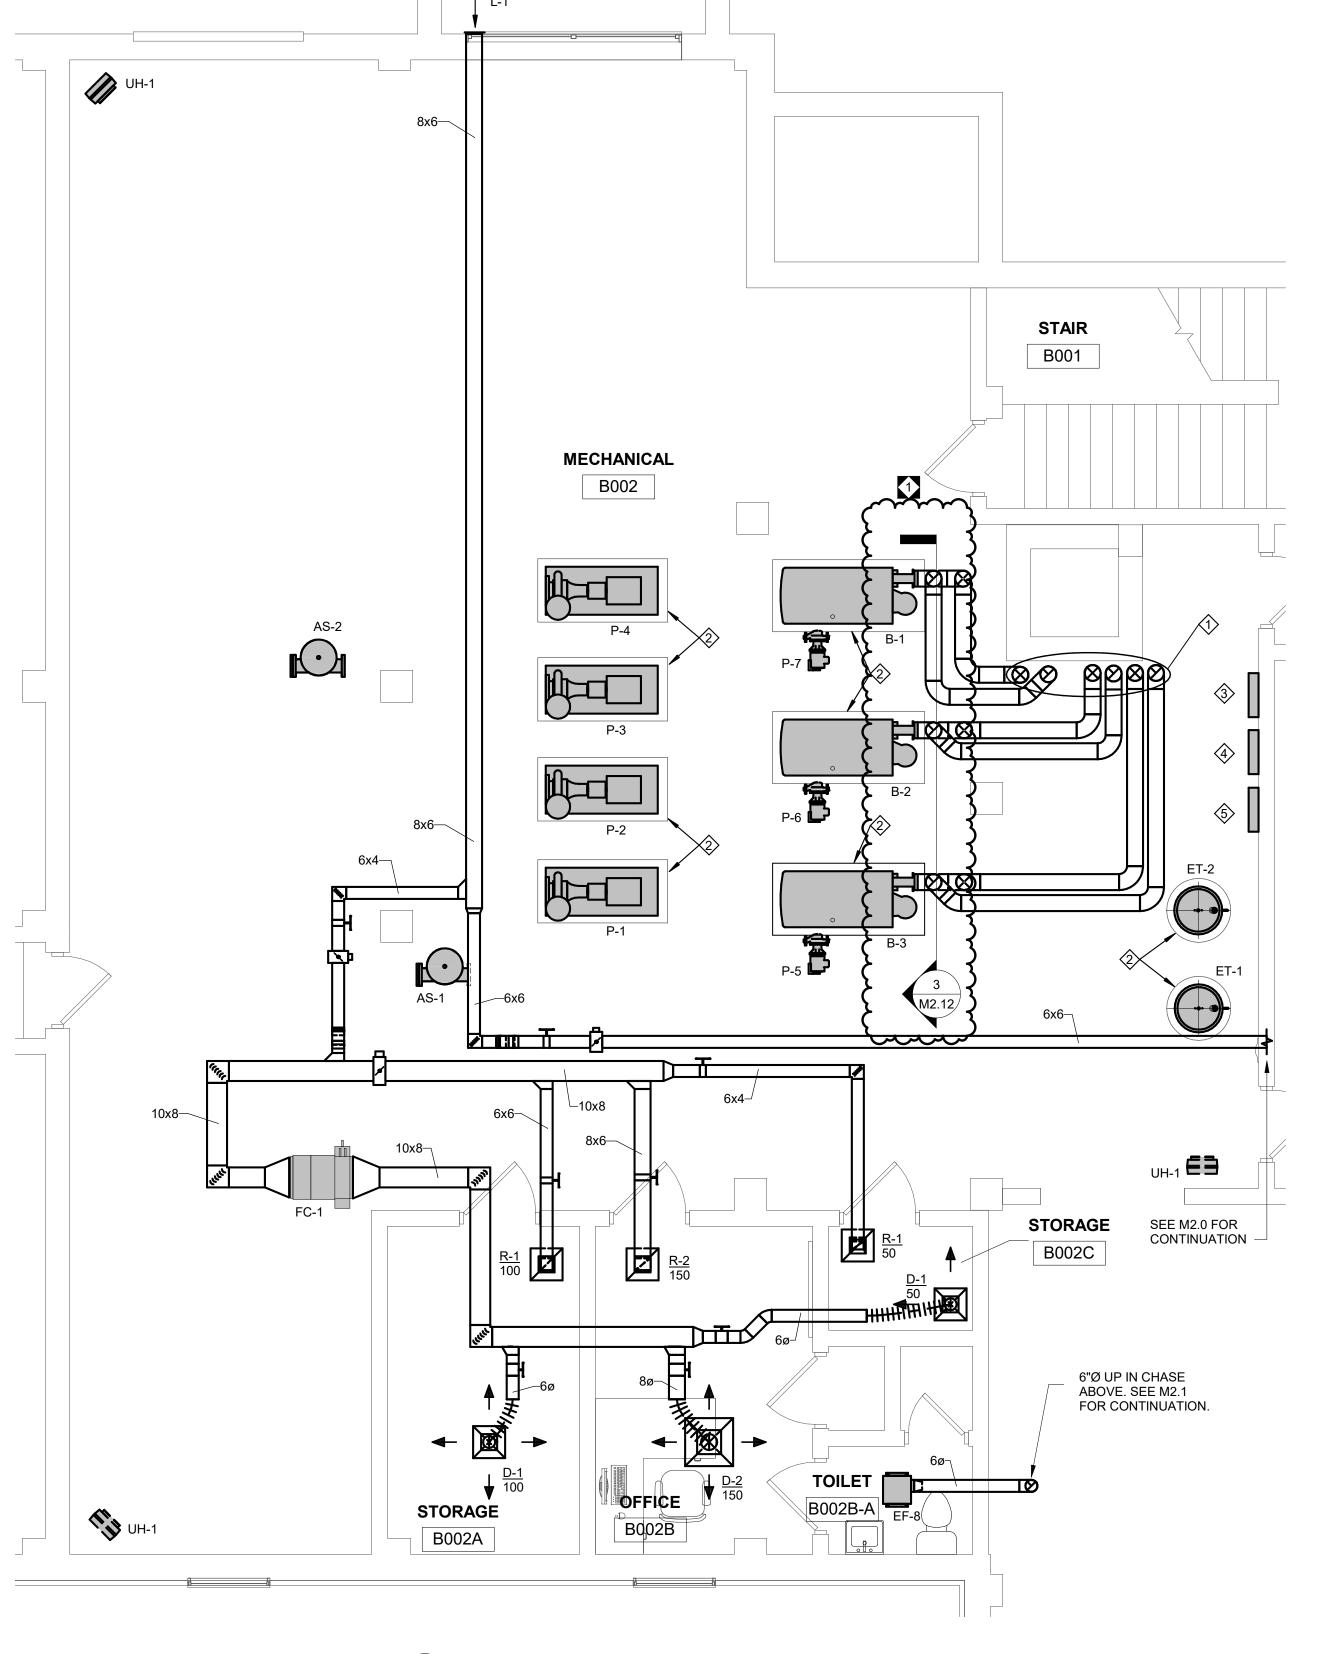
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# ADDITIONS & RENOVATIONS

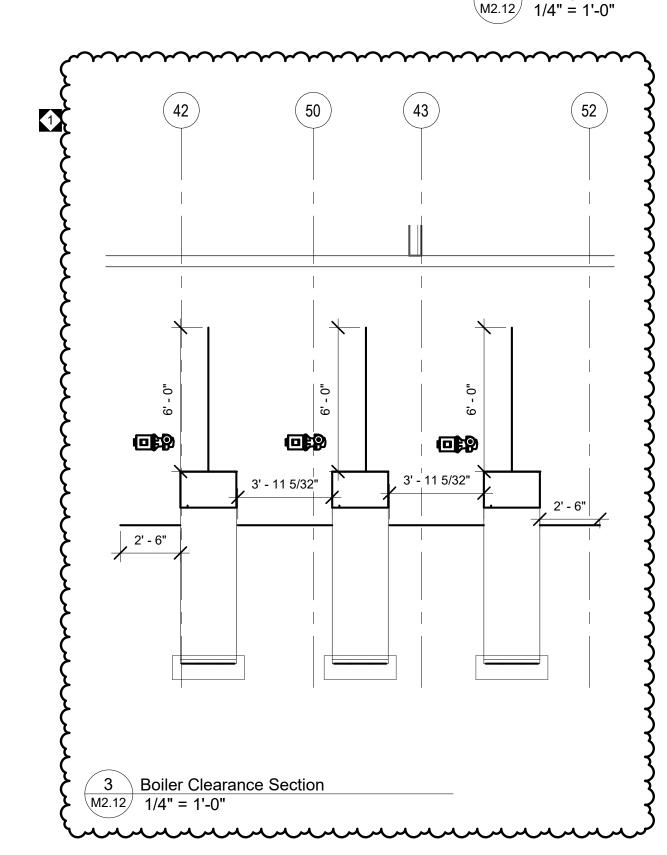
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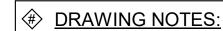
# SECOND FLOOR UNITS "A" & "B" HVAC PIPING

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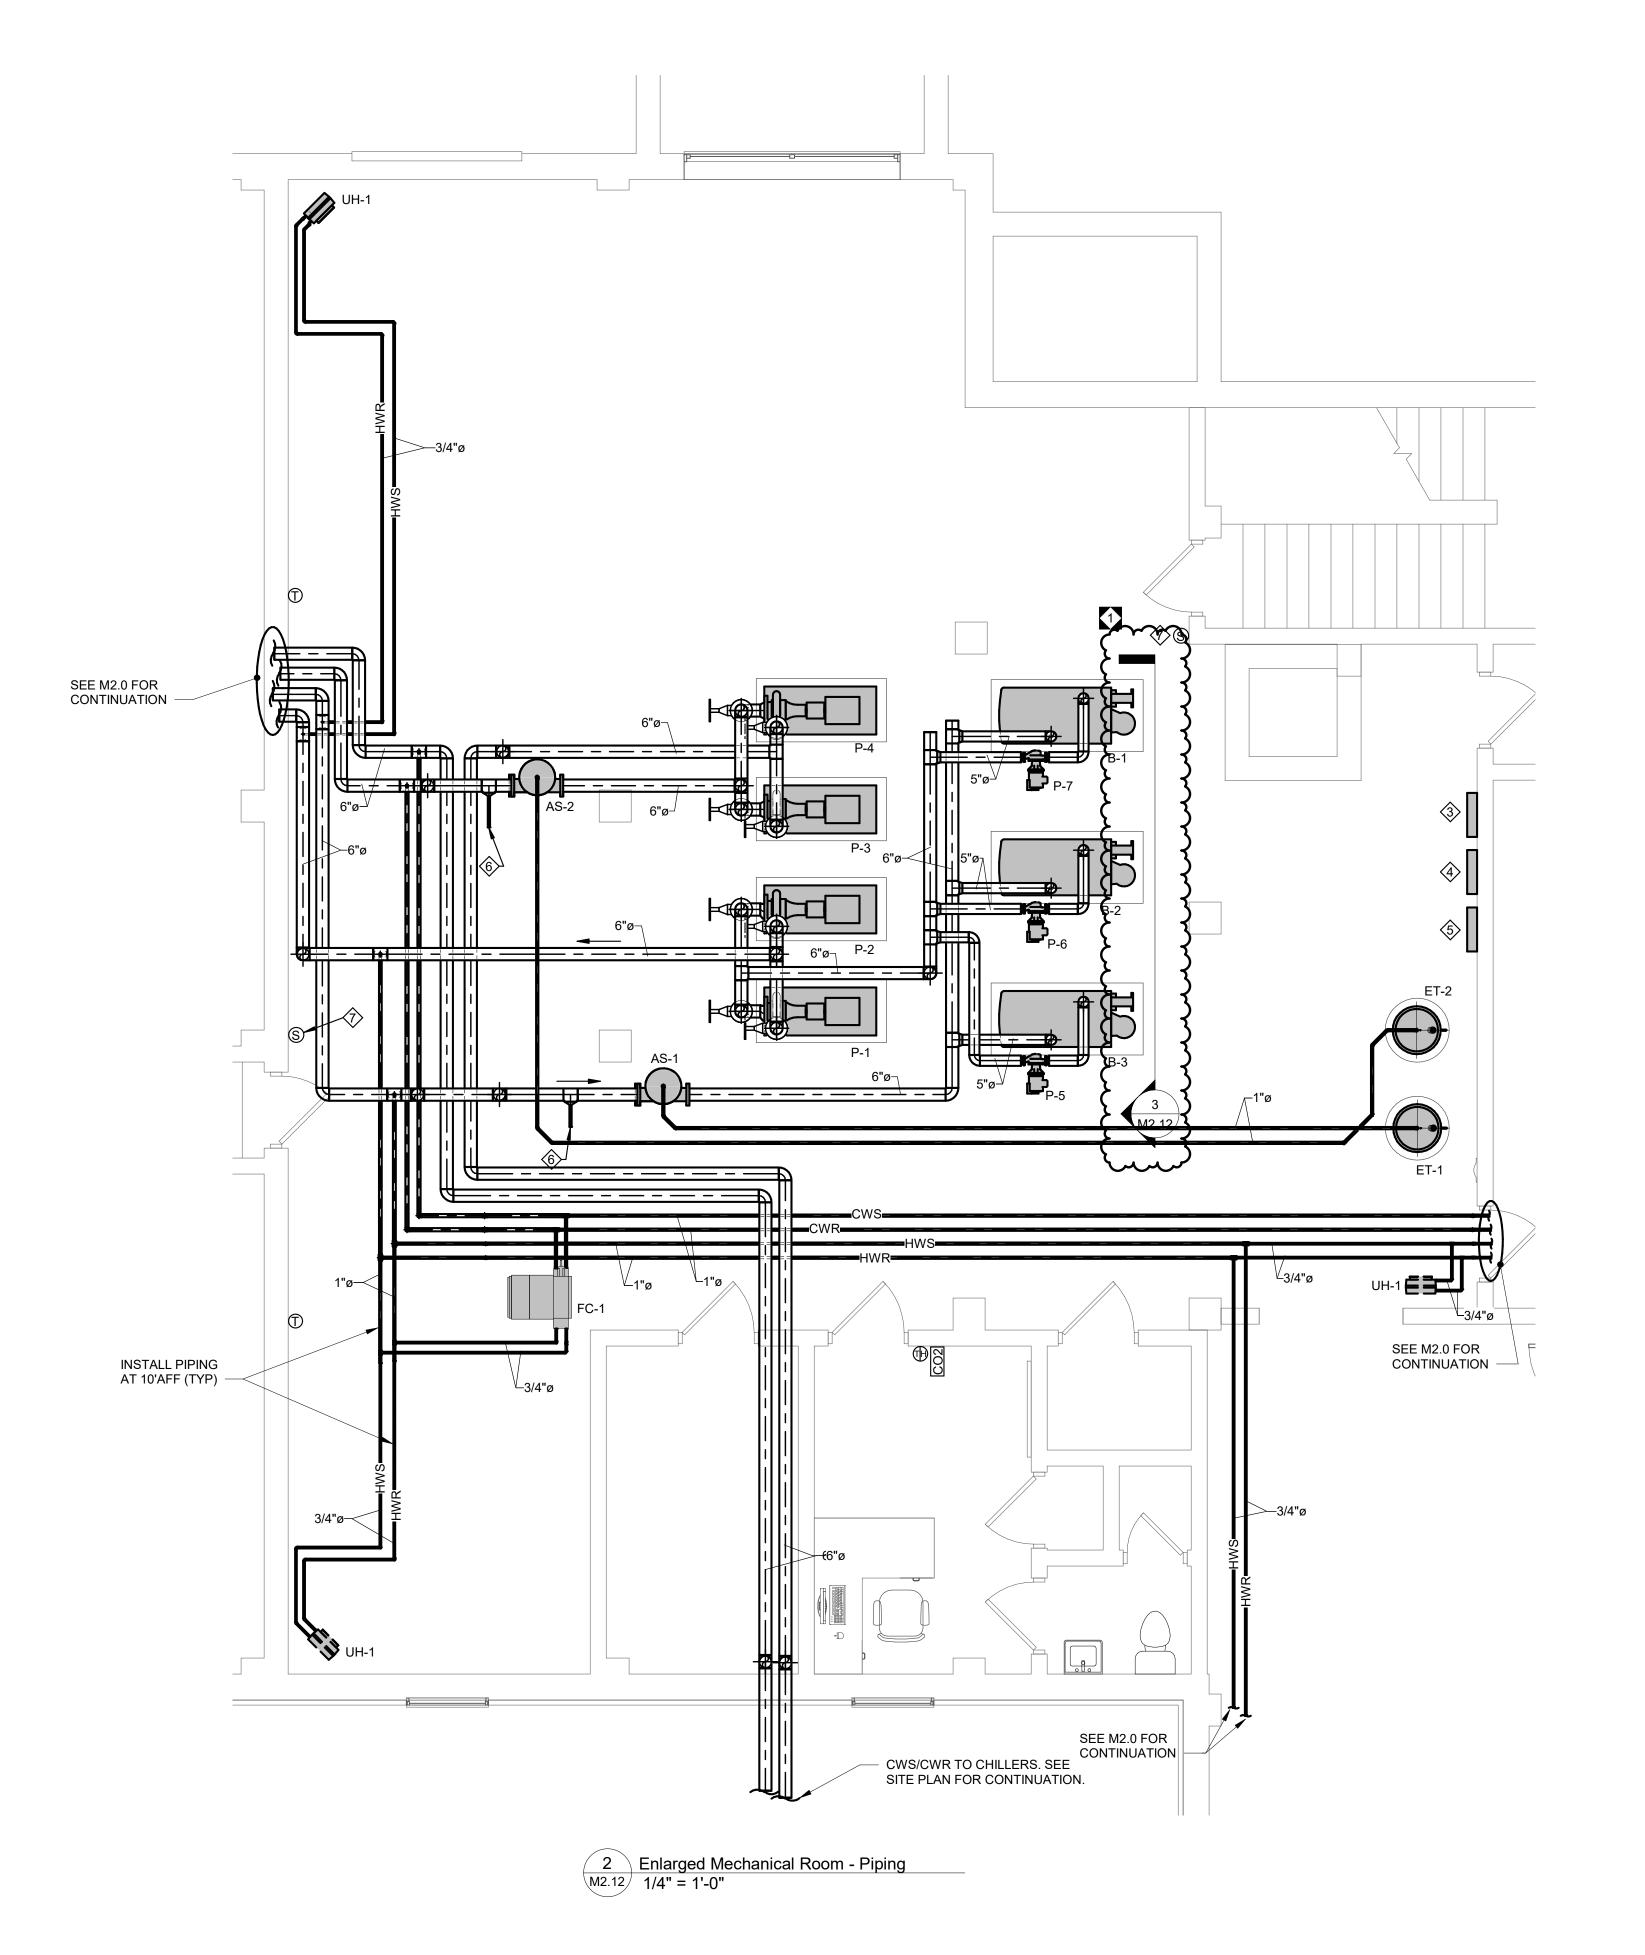








- | W DIVAWING NOTE
- (3) 8" COMBUSTION AIR AND (3) 8" VENT UP IN CHASE.
   MC SHALL PROVIDE HOUSEKEEPING PAD PER DETAIL.
  - ... WC SHALL FROVIDE HOUSEKEEFIN
- 3. DDC PANEL
- 4. BOILER CONTROL PANEL
- 5. CHILLER CONTROL PANEL
- 6. PROVIDE 1" MAKE-UP WATER CONNECTION PER DETAIL.
- 7. PROVIDE EMERGENCY BOILER SHUT OFF SWITCH.

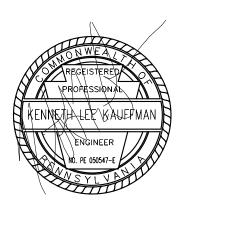


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NO.	DATE	REVISION

# SCHOOL & LOCATION RHAWNHURST ELEMENTARY SCHOOL

7809 Castor Ave, Philadelphia, PA 19152

# PROJECT TITLE

ADDITIONS & RENOVATIONS

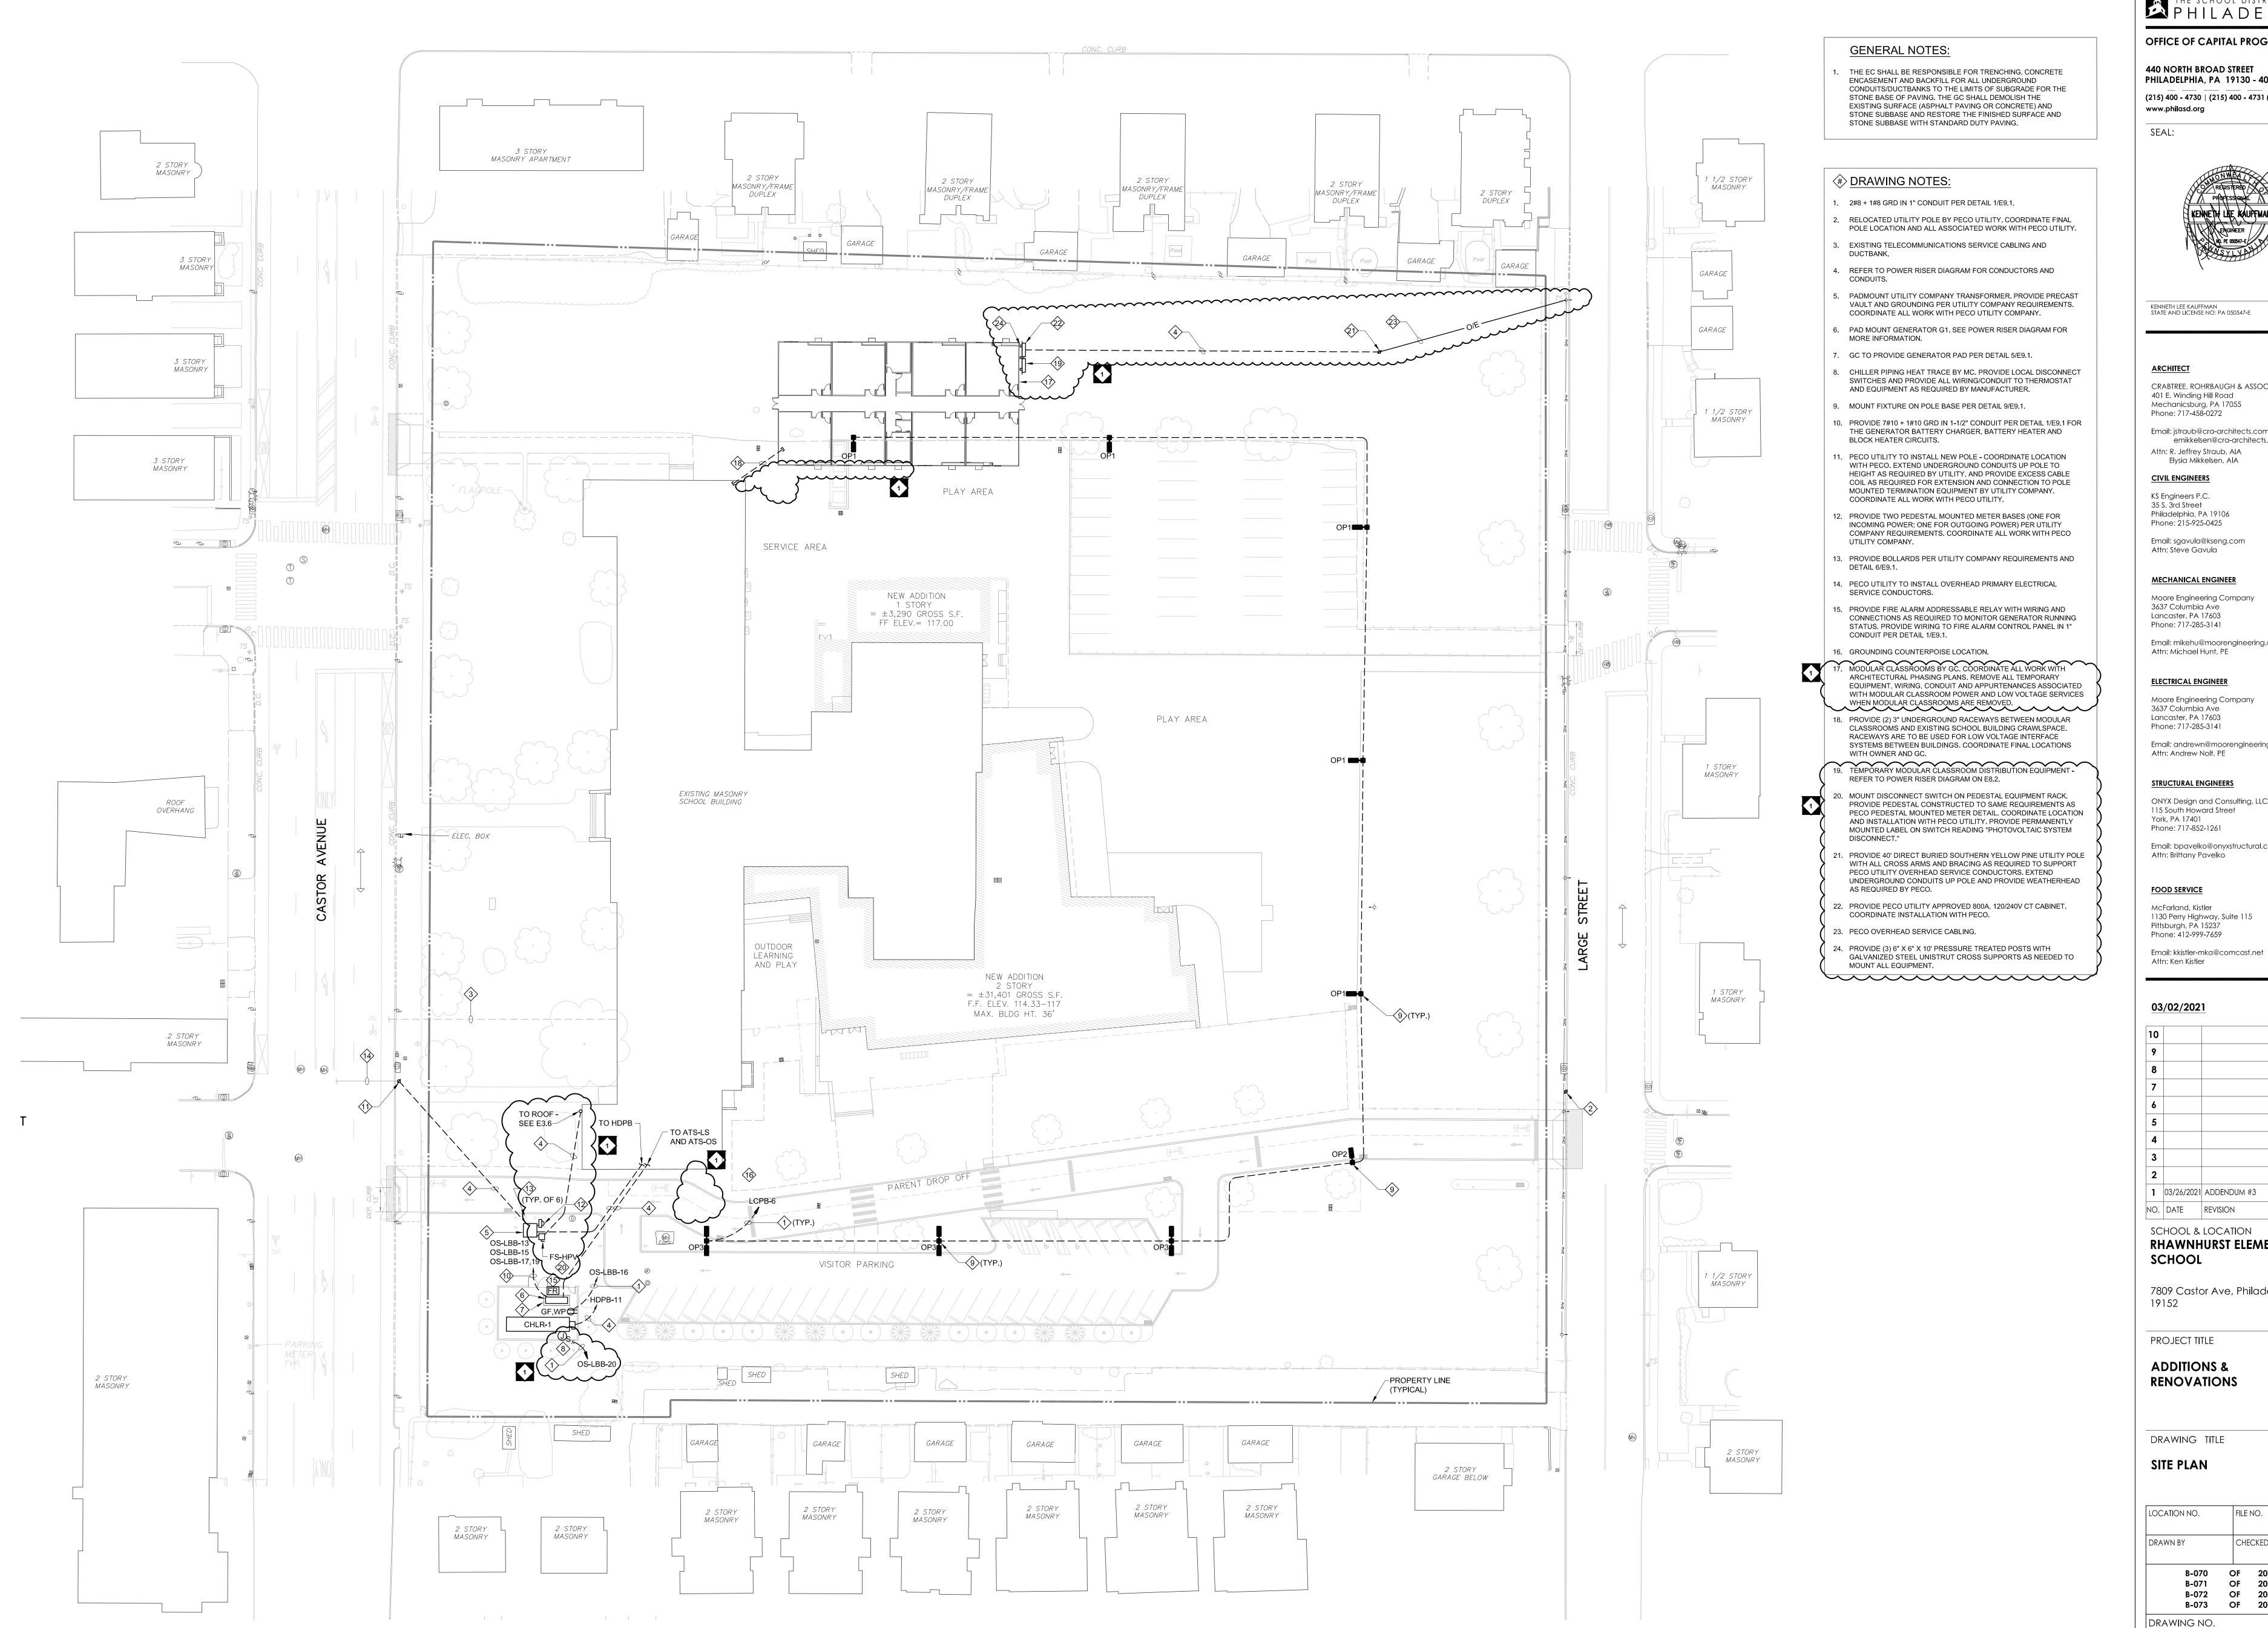
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# ENLARGED MECHANICAL ROOM

LOCATION NO.	FILE NO.
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B-070	OF 2019 /
B-071	OF 2019 /
B-072	OF 2019 /
B-073	OF 2019 /

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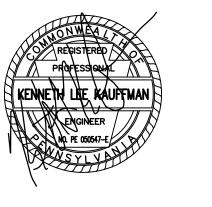
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OFFICE OF CAPITAL PROGRAMS

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KENNETH LEE KAUFFMAN STATE AND LICENSE NO: PA 050547-E

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FOOD SERVICE McFarland, Kistler 1130 Perry Highway, Suite 115 Pittsburgh, PA 15237

Phone: 412-999-7659

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no. date revision SCHOOL & LOCATION RHAWNHURST ELEMENTARY

7809 Castor Ave, Philadelphia, PA

PROJECT TITLE

# **ADDITIONS &**

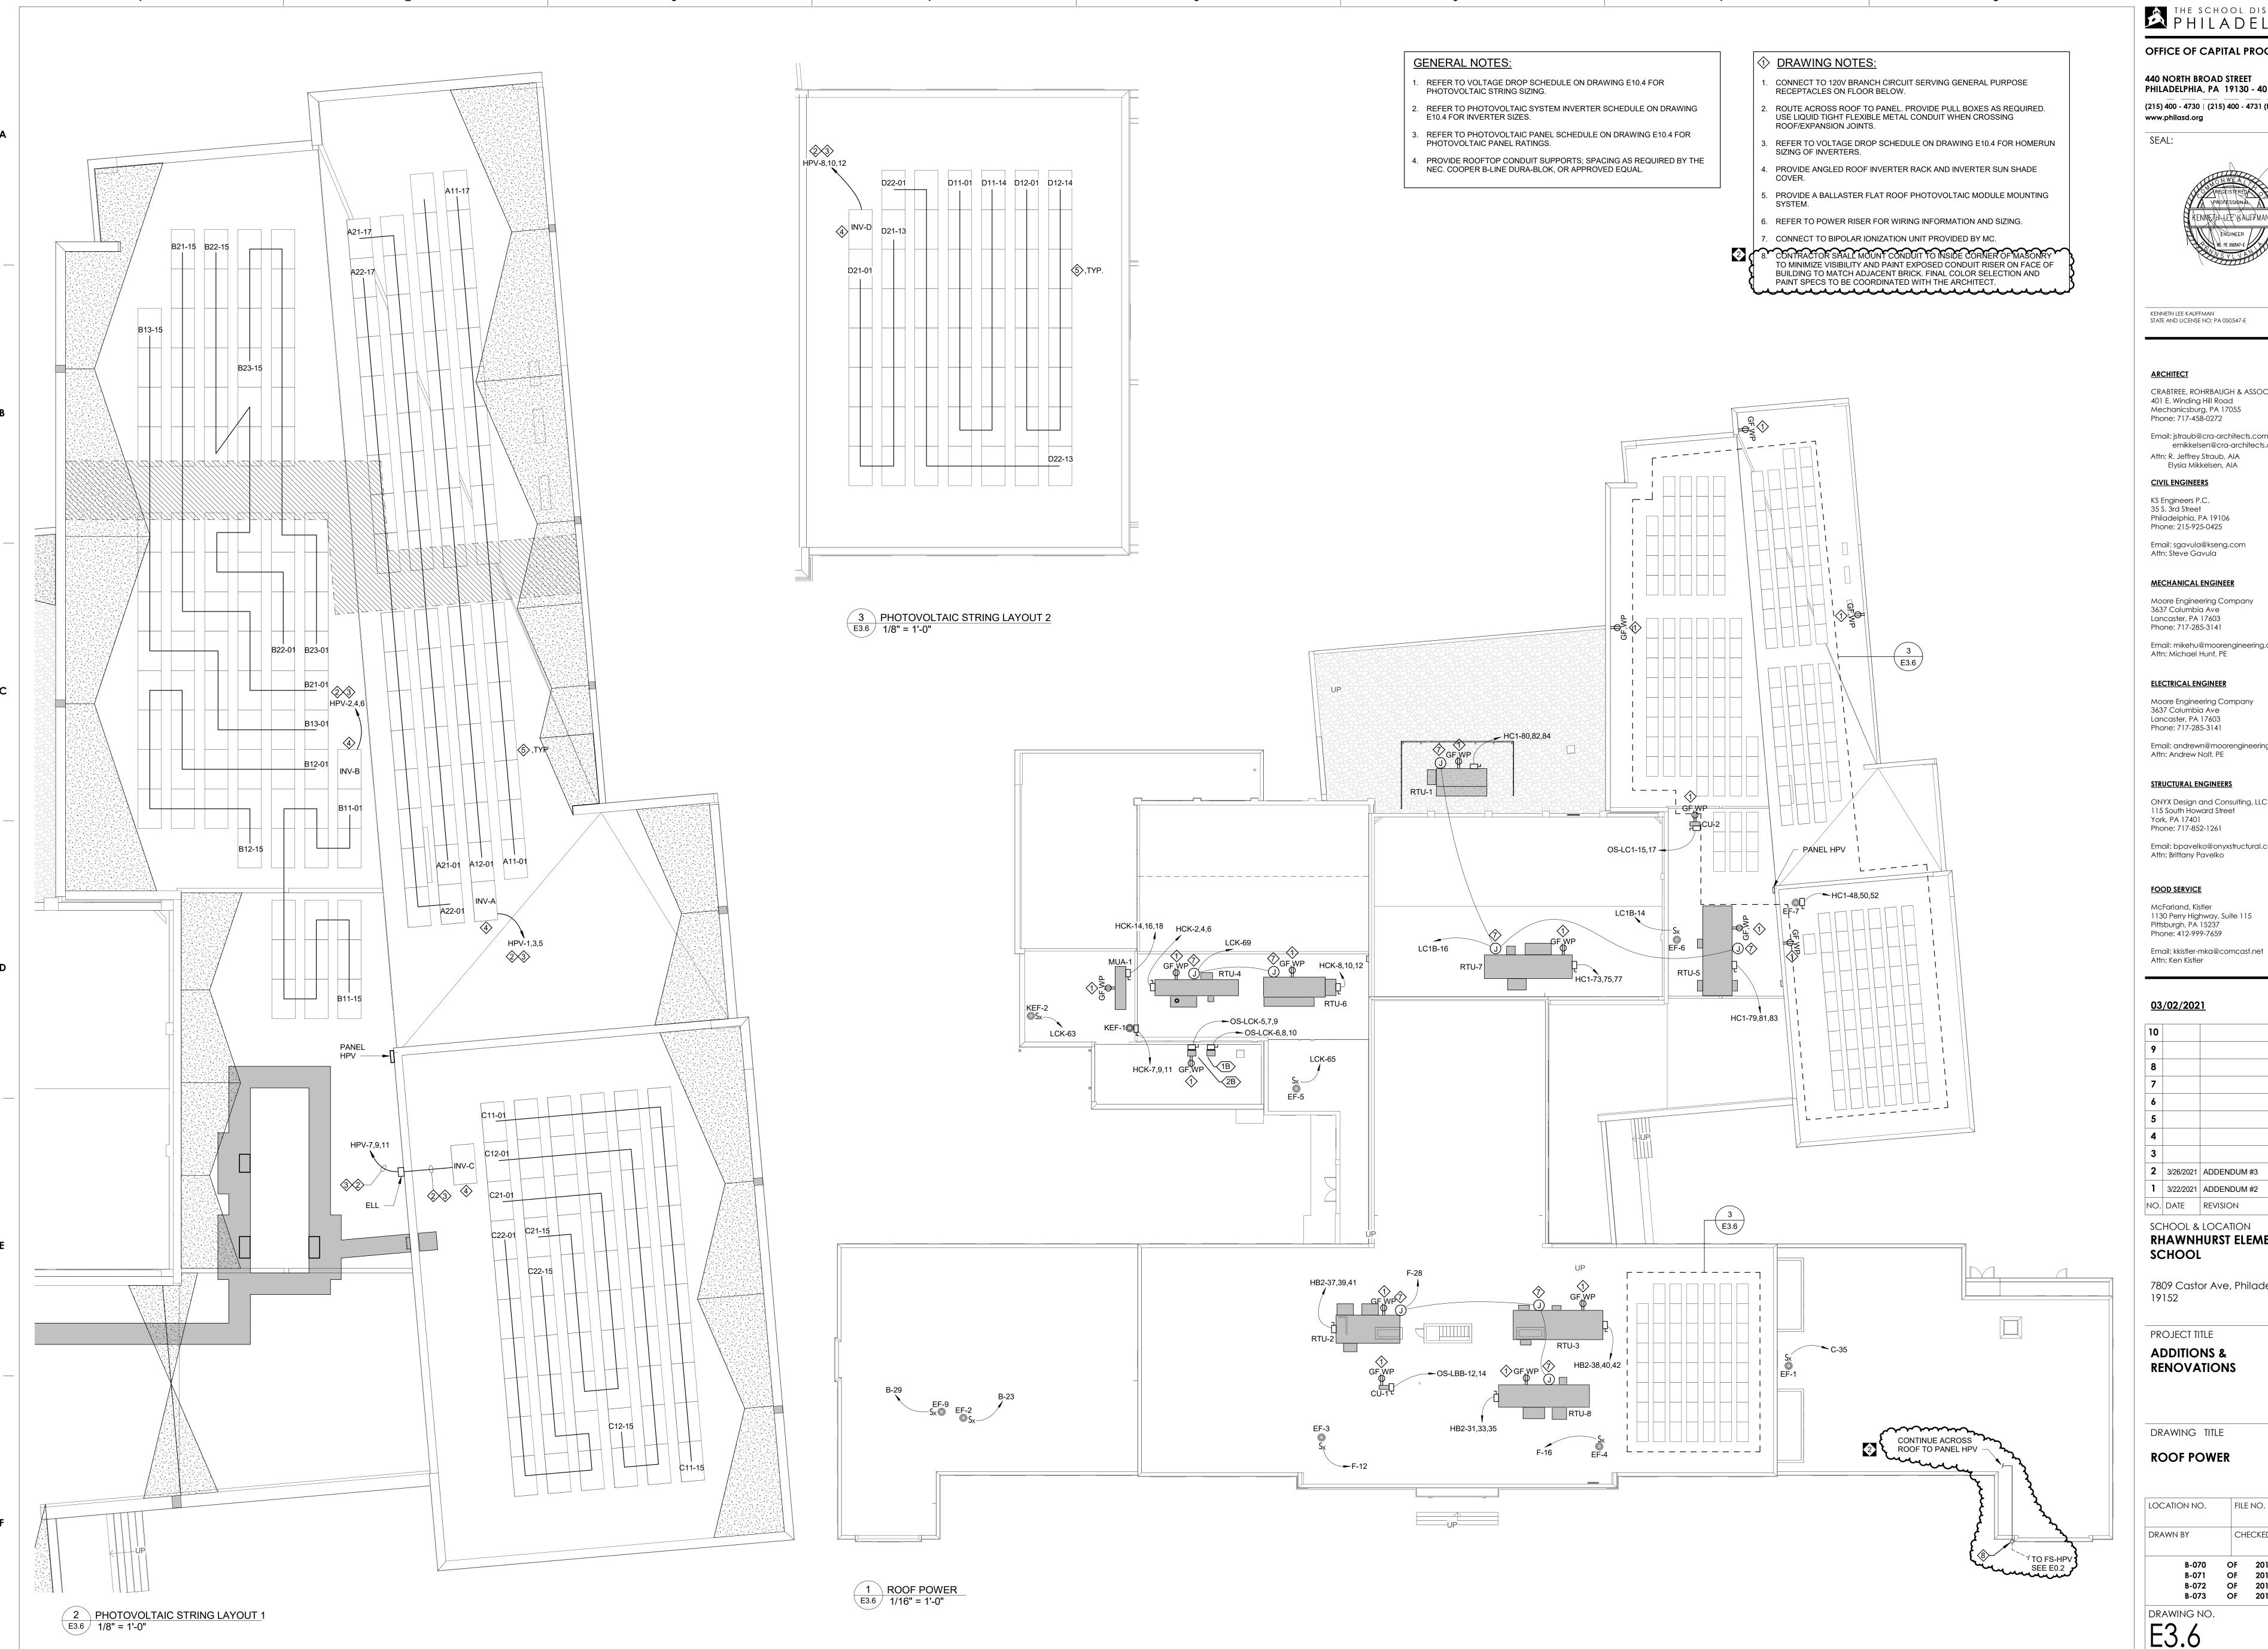
**RENOVATIONS** 

DRAWING TITLE

# SITE PLAN

LOCATION NO.	FILE	NO.	
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B-070 B-071 B-072 B-073	OF OF OF	2019 / 20 2019 / 20 2019 / 20 2019 / 20	

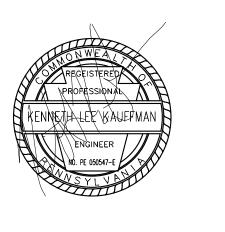
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### SCHOOL & LOCATION RHAWNHURST ELEMENTARY SCHOOL

7809 Castor Ave, Philadelphia, PA 19152

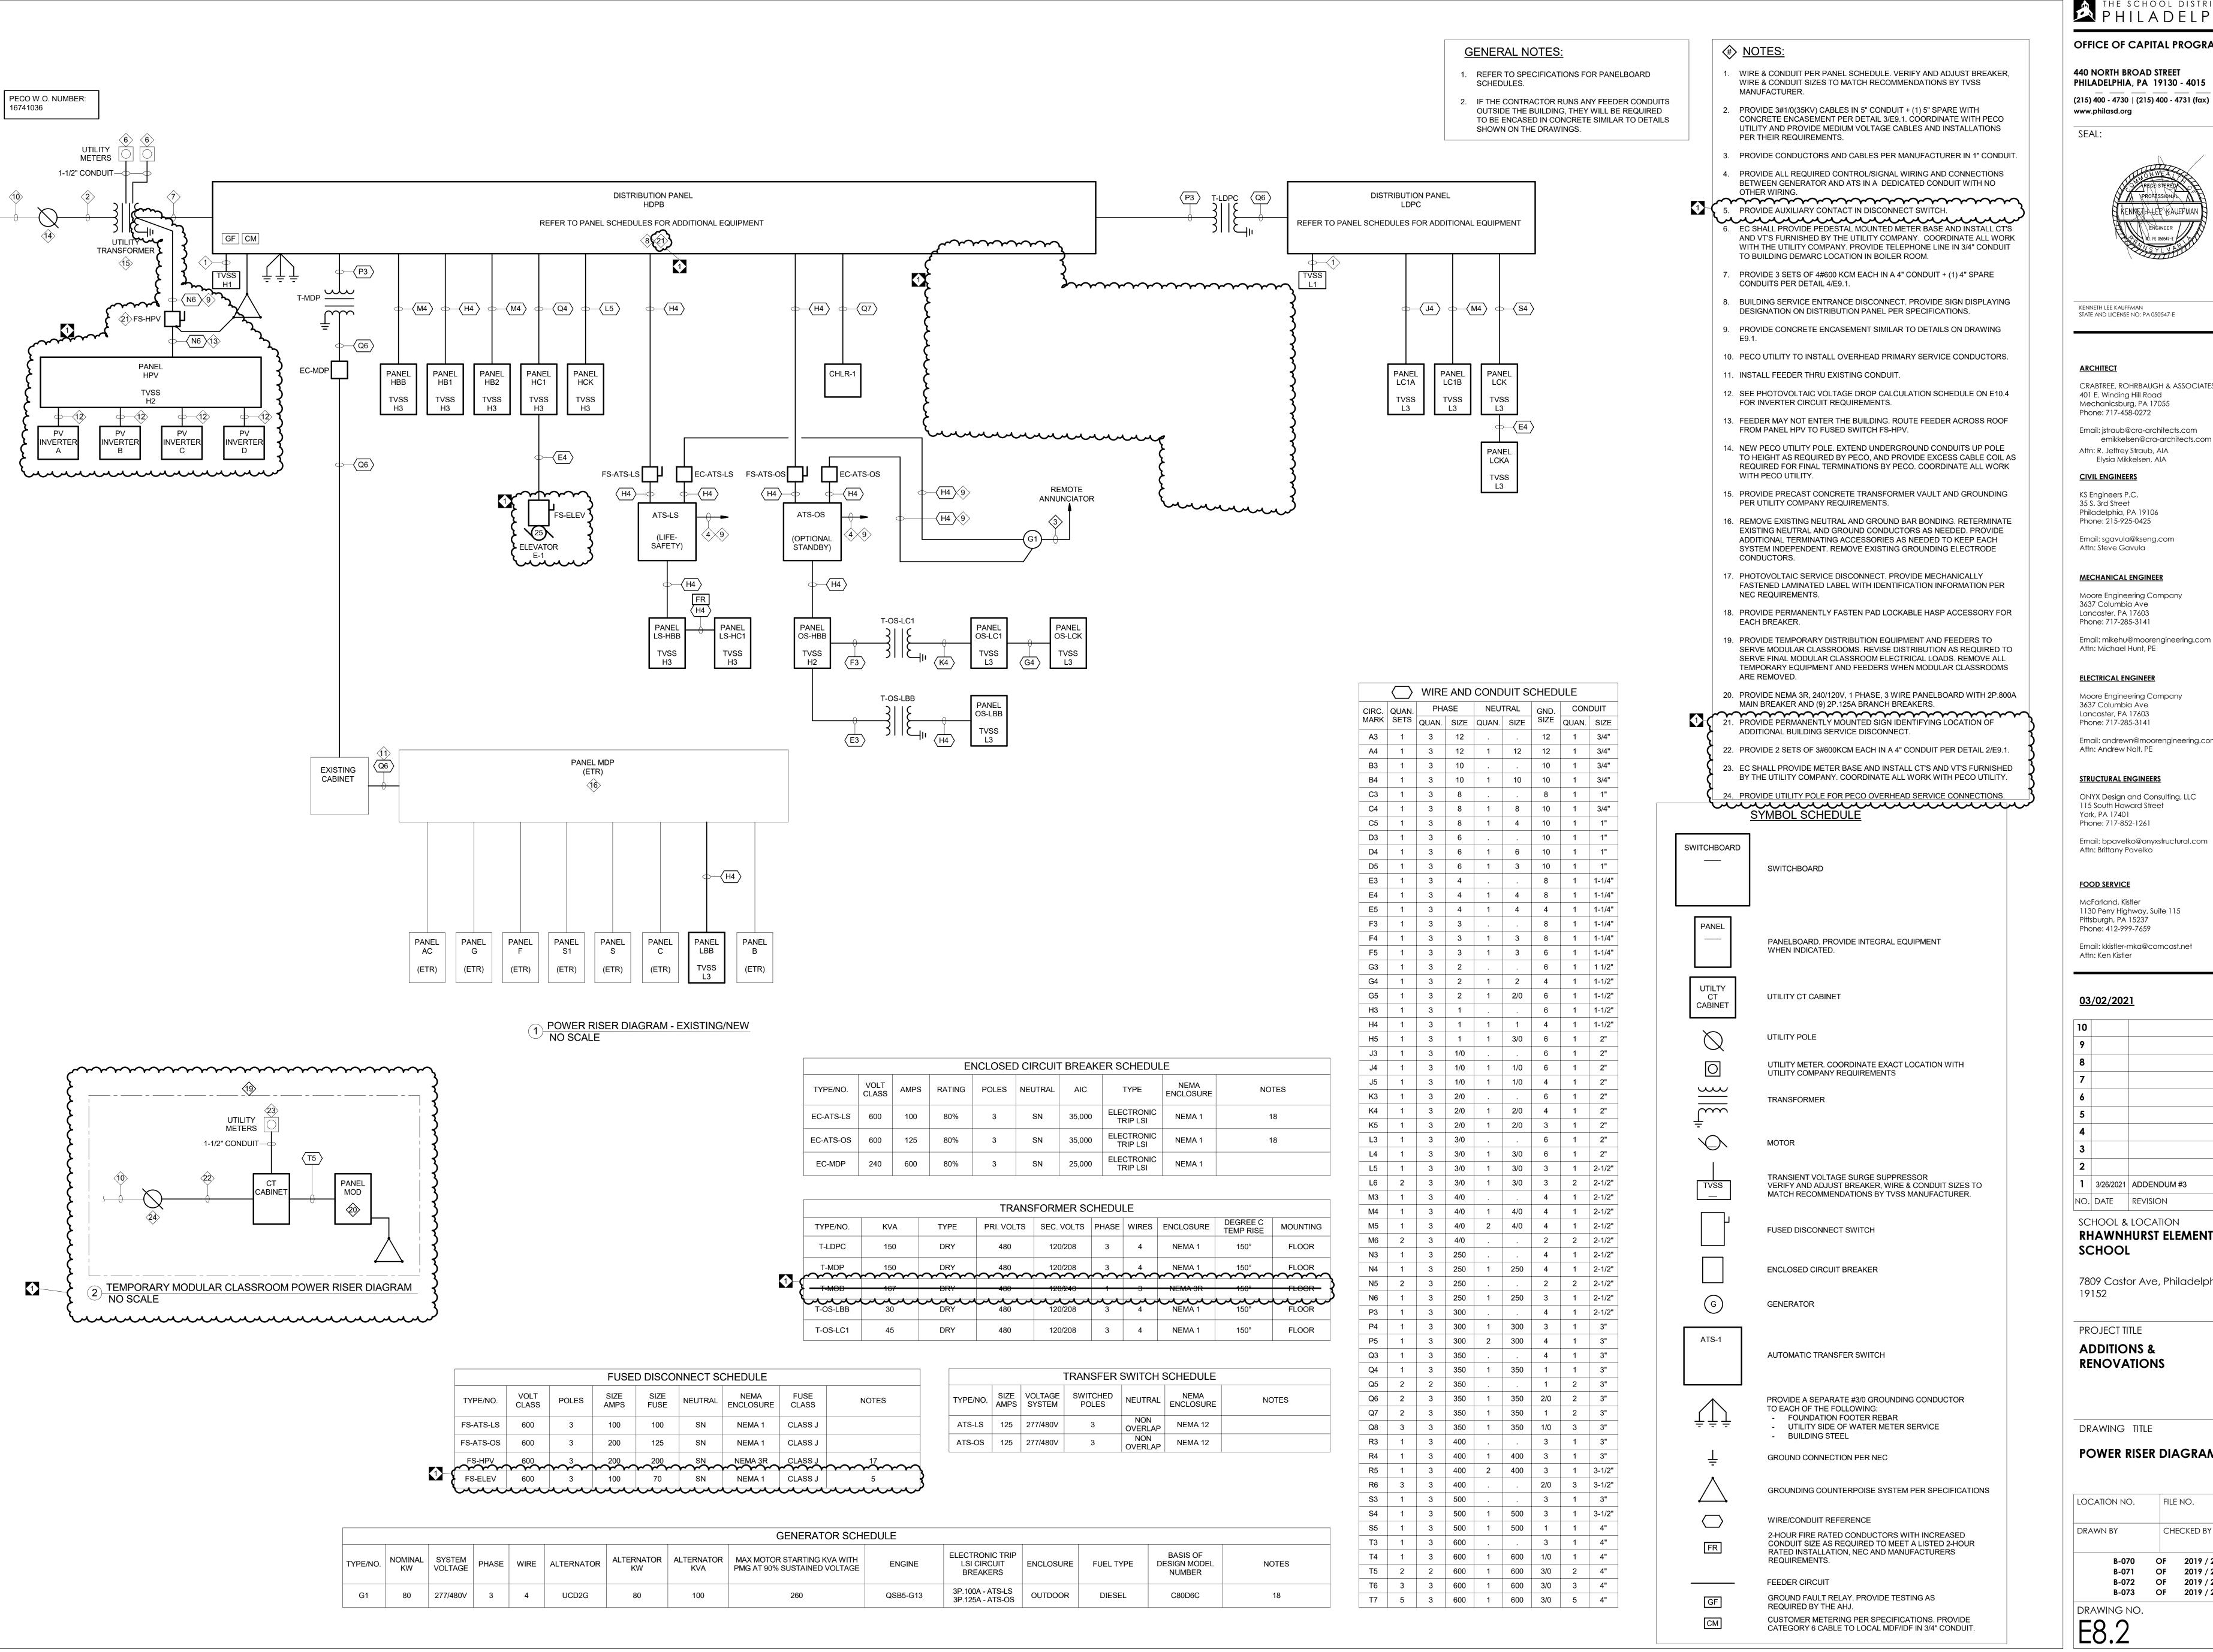
PROJECT TITLE

# **ADDITIONS & RENOVATIONS**

**ROOF POWER** 

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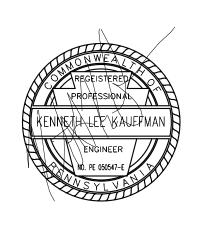
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SEAL:



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03/02/2021

**1** | 3/26/2021 | ADDENDUM #3

NO. DATE REVISION SCHOOL & LOCATION RHAWNHURST ELEMENTARY

7809 Castor Ave, Philadelphia, PA

PROJECT TITLE

**ADDITIONS & RENOVATIONS** 

DRAWING TITLE

POWER RISER DIAGRAM

LOCATION NO. FILE NO. CHECKED BY DRAWN BY B-070 OF 2019 / 20 B-071 OF 2019 / 20 B-072 OF 2019 / 20 B-073 OF 2019 / 20 DRAWING NO. E8.2